

WESTWOOD BOARD OF APPEALS APPLICATION FOR HEARING

1.	Name of Applicant: NSTAR Electric d/b/a Eversource Energy					
2.	Applicant is (check one): Owner Tenant Abutter Purchaser Other					
3.	Mailing address of Applicant: 107 Selden St, Berlin, CT 06037					
4.	Telephone - Home: Business: (860) 665-6151					
5.	E-Mail Address of Applicant:mark.kimball@eversource.com					
	Address of Property subject to Hearing: 1 NSTAR Way, Westwood, MA 02090					
	Owner of Property: NSTAR Electric d/b/a Eversource Energy					
	Mailing Address of Property Owner: 107 Selden St, Berlin, CT 06037					
	Telephone - Home: Business:(860) 665-6151					
	Deed recorded in: Norfolk County Registry of Deeds: Book # _587 Page # _19					
	Land Court Registry: Certificate # Book # Page #					
11.	Property MAP # 37 LOT # 008 DISTRICT					
12.	Has an appeal/application ever been filed with the ZBA on this property? (Y/N) \underline{N} If yes, when:					
13.	3. NATURE of Application (check one):					
	Appeal in accordance with MA G.L.Ch. 40A, Sec. 8 as amended Special Permit in accordance with MA G.L.Ch.40A, Sec. 9 as amended Variance in accordance with MA G.L. Ch. 40A, Sec. 10 as amended					
	When applying for a Special Permit under Section 9.3 of the Westwood Zoning Bylaw, please make					

sure that you and/or your attorney refer to the specific bylaw regarding this section.

STATE the EXACT NATURE of this application including the applicable section number(s) of the Westwood Zoning Bylaw:

Installation of solar parking canopies within the existing paved areas of the site.

I hereby request a hearing before the Westwood Board of Appeals with reference to the subject property.

I am aware that the <u>cost of legal advertising</u> will be billed to me directly as the Applicant, by the newspaper at a later date. I am also aware of the provisions in the Zoning Bylaw with regard to <u>Reimbursement for Consultants</u>, and I agree to reimburse the Board of Appeals and the Town of Westwood for all costs incurred by the Town or its' Boards for all fees, expenses and costs in connection with the review and evaluation of the Application for Special Permit and/or Variance.

I have reviewed the Zoning Board of Appeals Instructions and Information and understand the time requirements.

PROPERTY OWNER (if different from applicant)

SCHEDULE OF FILING FEES FOR THE BOARD OF APPEALS

Residential Properties - \$165.00

Business Properties - \$330.00

Comprehensive Permits - \$2530.00

CHECKLIST:

- 6 copies of the Application
- 6 copies of the OPTIONAL Appendices (if completed)
- 6 copies of a Certified Plot Plan size 11" x 17"
- 6 copies of the Building Plans (interior and/or exterior as applicable) size 11" x 17"
- 6 copies of the Building Commissioner's denial of a building permit or equivalent

<u>File</u> the six (6) packets in the Town Clerk's office located at 580 High Street making sure to include a check for the filing fee in the correct amount.

<u>Deliver</u> one (1) electronic copy of the Application with attachments to the Office of the Board of Appeals at 50 Carby Street.

OPTIONAL

APPENDIX A - Variance Worksheet

The Variance must be with respect to particular land or structures.

Parcel of Land:	
Structures:	
There must be circumstances relating to soil conditions, shape, and topography of such land or structures and especially affecting such land or structures, but not affecting generally the zoning district in which it is located.	
Circumstances would be:	
Literal enforcement of the provisions of the bylaw would involve substantial hardship, financial or otherwise, to petitioner or appellant.	the
Hardship would be:	
Desirable relief may be granted without detriment to the public good and without nullifying or substantially dero from the intent or purpose of such bylaw.	gating
Relief would be:	
Detriment would be:	
Intent or purpose of Bylaw section?	
Would the Variance nullify intent or purpose above?	
Is there any substantial derogating (lessening) of the intent or purpose and if so, what is it?	

OPTIONAL

APPENDIX B - Special Permit Considerations

The structure is in harmony with the general purpose and intent of the bylaw.
Please refer to attached cover letter
 The structure is in an appropriate location and is not detrimental to the neighborhood and does not significantly alter the character of the zoning district.
Please refer to attached cover letter
 Adequate and appropriate facilities will be provided for the proper operation of the proposed structure.
Please refer to attached cover letter
 The proposed structure will not be detrimental or offensive to the adjoining zoning districts and neighboring properties due to the effects of lighting, odors, smoke, noise, sewage, refuse material, visual or other nuisances.
Please refer to attached cover letter
The proposed structure will not cause undue traffic congestion in the immediate area.
Please refer to attached cover letter



August 15, 2017

Ms. Sarah Bouchard, Zoning Agent Zoning Board of Appeals Town of Westwood, Massachusetts 50 Carby Street Westwood, MA 02090 5 Centennial Drive, Peabody, MA 01960 (HQ) Tel: 978.532.1900

Re: Eversource - Solar Canopy Project

Special Permit Application

Dear Ms. Bouchard and Members of the Zoning Board of Appeals:

Weston & Sampson, on behalf of Eversource, is hereby providing the enclosed Special Permit Application and supporting documents for the proposed solar canopy project at the Eversource corporate offices on NSTAR Way. As the Building Inspector has advised us, the Project requires a Special Permit under section 4.3.2.7 of the Town's recently amended Zoning Bylaws.

The Project includes the installation of several "solar PV canopies" within the existing employee parking areas at the site. No new site disturbance or tree clearing is proposed. The canopies will provide shade and a degree of protection from rain and snow for employee parking, with the added benefit of also producing sustainable solar energy from the solar PV modules that comprise the roof of the canopies. Under-canopy lighting has been proposed for employee safety, but the lighting design is such that off-site lighting impacts are expected to be minimal.

The total generating capacity of the solar canopies is expected to be approximately 2,300 kW DC, with an annual output of approximately 2.5 million kWh. The electricity generated by the PV modules will be exported to the grid per utility regulations, but given historic usage data at the existing corporate offices it is anticipated that the offices will consume 100% of the annual generation from the PV modules.

The Project is part of Eversource's statewide program, approved by the Department of Public Utilities, to construct, own and operate up to 62 MW of solar energy projects. The program is designed to help Eversource cost-effectively meet its renewable energy goals under the State's Renewable Portfolio Standard, and to do so by utilizing available areas for solar panel deployment at its existing land holdings.

The following sections address the Project's compliance with section 10.3.3 of the Zoning Bylaw as well as the items listed in Appendix B of the Special Permit application:

Bylaw Section 10.3.3 Special Permit – Decision Factors

1. Social, economic or community needs which are served by the proposal.

The Project supports the overall renewable energy goals of the Commonwealth as set out initially in the Global Warming Solutions Act of 2008 and subsequent related legislation, and helps Eversource, a public utility, in complying with its own renewable energy goals and the regulatory provisions for utility-owned renewable generation established by the Massachusetts Department of Public Utilities.

2. Traffic flow and safety, including parking and loading.

The Project maintains the current adequacy of ingress/egress to the property with no adverse impact to parking or loading, or to pedestrian safety and convenience. The carport canopy structures will also provide a measure of shelter for employee and visitor parking from inclement weather. There are no changes proposed to off-street parking, traffic flow or emergency access, and there will be no additional traffic as a result of the Project.

3. Adequacy of utilities and other public services.

The Project will not create any substantive new impacts to existing utilities at the site. All current utilities and public services will remain unchanged.

4. Neighborhood character, aesthetics and social structures.

The Project is generally compatible with character of the existing Industrial/Office zoning district, and will have no detrimental aesthetic impact on the surrounding neighborhood.

5. Impacts on the natural environment.

The Project will be constructed entirely within previously disturbed areas of the site (parking lots). No new impervious areas will be created, and only minor tree pruning will be required in several locations.

6. Potential fiscal impact, including impact on town services, tax base and employment.

The Project will not have any substantive impacts on town services, tax base or employment.

Special Permit Application, Appendix B - Special Permit Considerations

The structure is in harmony with the general purpose and intent of the bylaw.

The Project is in harmony with the general purpose and intent of the bylaw in that the proposed use is compatible with the underlying zoning district and adjacent land uses, protects the health and safety of residents and visitors, does not impact the cultural and historic heritage of the community and promotes the general welfare through reduction of greenhouse gases and fossil fuel emissions.

The structure is in an appropriate location and is not detrimental to the neighborhood, and does not significantly alter the character of the zoning district.

The Project is located appropriately within an existing commercial parking lot and is not detrimental to the neighborhood, nor does the Project alter the character of the existing Industrial/Office zoning district. Existing landscaping and screening will be preserved.

Adequate and appropriate facilities will be provided for the proper operation of the proposed structure.

The Project will be owned and maintained by Eversource. The PV canopies are fixed, non-mechanical solar arrays and will operate with minimal required operational oversight. Routine maintenance consists of periodic visual inspection of the wiring connections and structural attachments as well as preventive maintenance on the associated inverters and transformers.

The proposed structure will not be detrimental or offensive to the adjoining zoning districts and neighboring properties due to the effects of lighting, odors, smoke, noise, sewage, refuse materials, visual or other nuisances.

The Project will not be detrimental or offensive to neighboring properties for any of the listed nuisances. The solar canopies will operate essentially silently with no nuisance emissions. Existing landscaping and screening will remain in place.



The proposed structure will not cause undue traffic congestion in the immediate area.

The Project will not generate additional traffic at the site.

We believe the project Proponent has developed a well-conceived Project, which complies with the Town of Westwood Zoning Bylaws, and we trust that the Zoning Board of Appeals will find the application worthy of approval. We look forward to discussing the project and will be available to answer any questions or address any comments at the next scheduled Zoning Board public hearing.

In the meantime, if you have any questions or require any additional information, please contact me in our Peabody, MA office at 978-532-1900 x 2221 or by e-mail at wiehes@wseinc.com.

Very truly yours,

WESTON & SAMPSON ENGINEERS, INC.


Stephen Paul Wiehe, PG


Project Manager

28678

*Building Permit - Commercial Projects – COMMERCIAL - NEW CONSTRUCTION

TIMELINE Submission received Aug 14, 2017 at 3:23pm **Permit Fee Deposit** Paid Aug 15, 2017 at 10:35am **Application Completeness Review** Completed Aug 15, 2017 at 10:35am Sewer/Engineering Plan Review Skipped Aug 15, 2017 at 10:55am **Planning Board Review** Skipped Aug 15, 2017 at 11:41am **Conservation Review** Completed Aug 16, 2017 at 10:06am DPW/Highway Review Skipped Aug 16, 2017 at 11:03am Fire Department Review Skipped Aug 16, 2017 at 11:05am **Health Department Review** Skipped Aug 16, 2017 at 11:05am **Building Department Review** In Progress

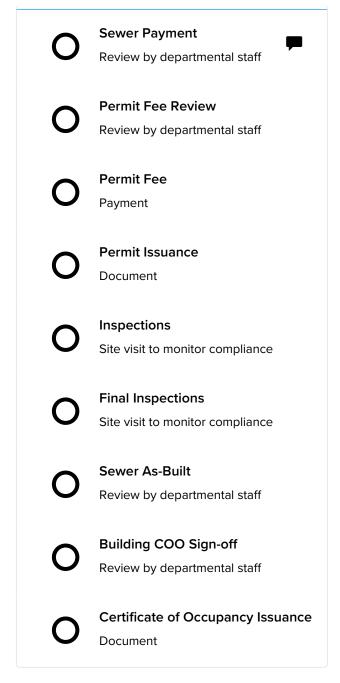

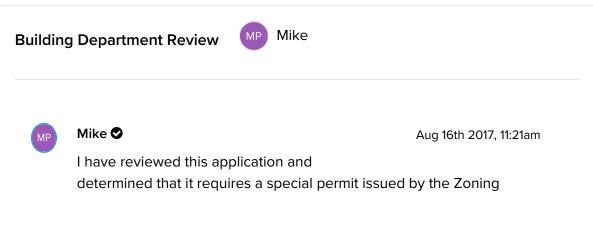

Board of
Appeals as per section 4.3.2.7 of the Westwood Zoning Bylaw.

EVERSOURCE - MASSACHUSETTS PHOTOVOLTAIC PROGRAM - ROUND II

PROPOSED ±2,270.4 kW-DC SOLAR PHOTOVOLTAIC (PV) PROJECT

1 NSTAR WAY WESTWOOD, MA 02090

PROJECT DIRECTORY

WESTON & SAMPSON ENGINEERS, INC.

PEABODY, MASSACHUSETTS 01960 CONTACT: STEPHEN WIEHE, PG

DEVELOPER/APPLICANT:

BERLIN, CONNECTICUT 06037

CONTACT: MARK KIMBALL

107 SELDEN STREET

5 CENTENNIAL DRIVE

EVERSOURCE

(860) 665-6151

(978) 532-1900

EVERSOURCE

(860) 665-6151


107 SELDEN STREET

INDUSTRIAL (I) NOTES:


MINIMUM ZONING REQUIREMENTS.

*SETBACKS AND QUANTITIES PER TABLE 5.2 DIMENSIONAL REQUIREMENTS OF THE WESTWOOD BYLAWS. **PROPOSED SETBACKS AND QUANTITIES ARE APPROXIMATE AND SUBJECT TO CHANGE BASED ON FINAL ENGINEERED DESIGN. FINAL PROPOSED SETBACKS AND DIMENSIONS SHALL BE DESIGNED TO MEET

BERLIN, CONNECTICUT 06037 CONTACT: MARK KIMBALL

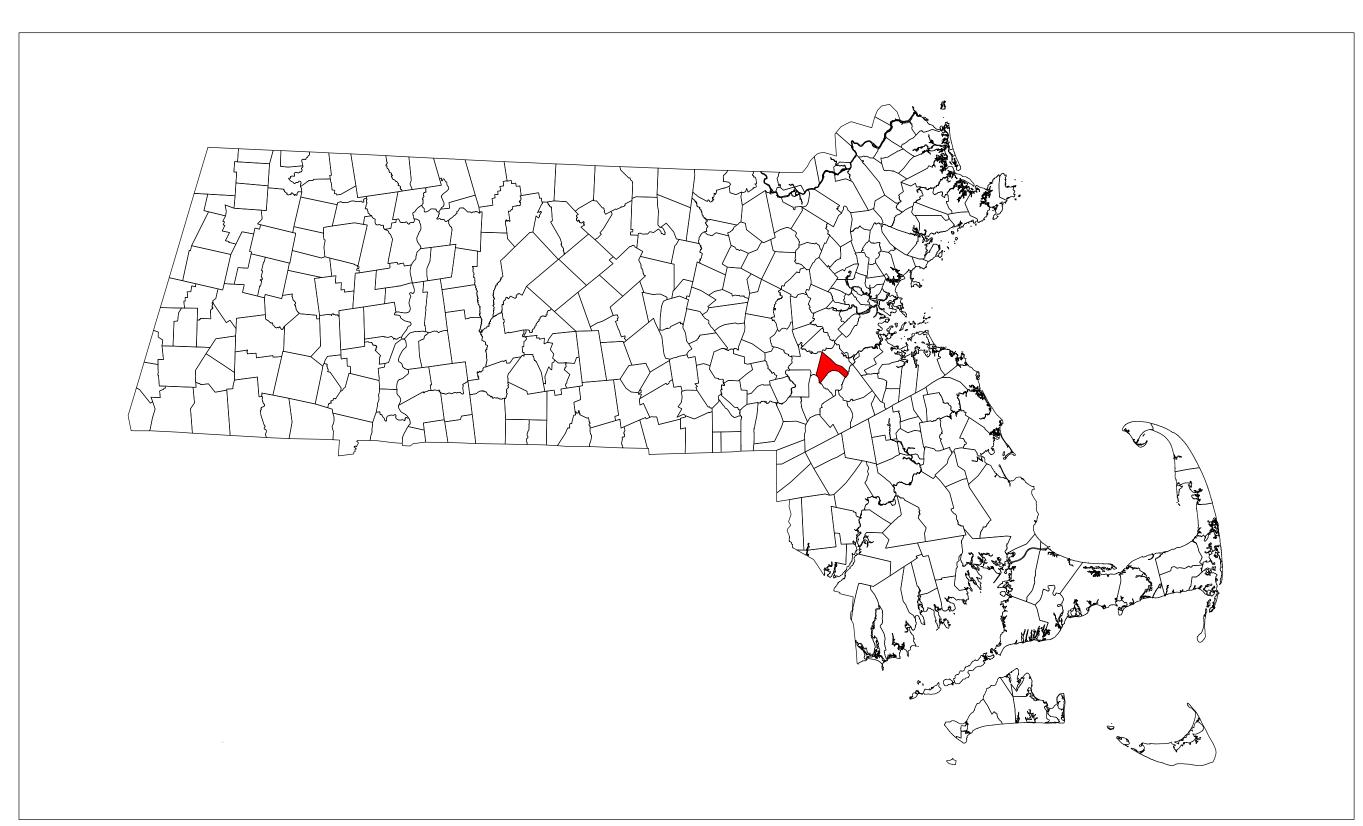

ASSACHUSETTS MUNICIPAL MAP	
SCALE: N.T.S.	

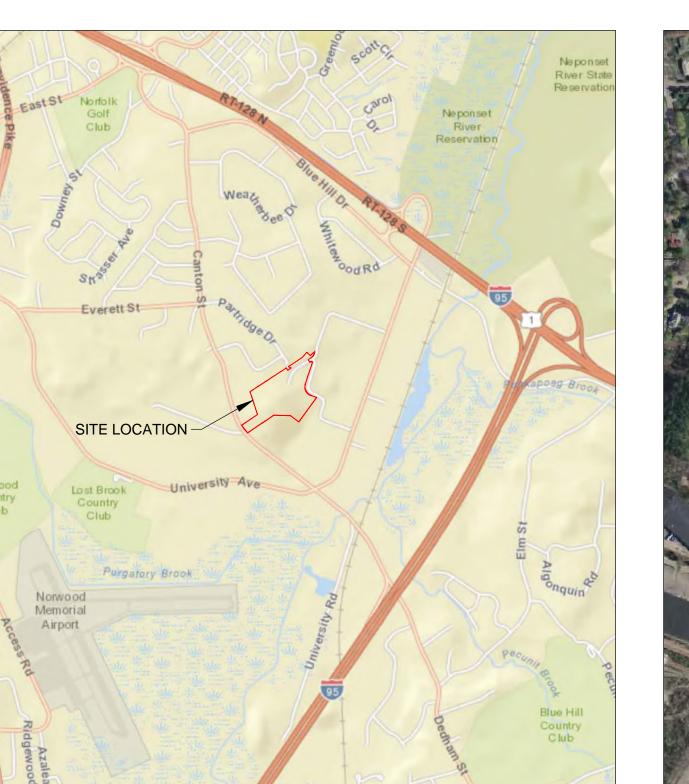

SITE LOCUS MAP SCALE: 1"= 2,000'



SITE LOCATION MAP	(AERIAL VIEW)
SCALE: 1"-	500'

DRAWING INDEX						
SHEET	HEET SHEET TITLE					
T-1	COVER SHEET					
G-1	GENERAL NOTES AND LEGEND					
C-1	EXISTING CONDITIONS PLAN					
C-2	EXISTING CONDITIONS PLAN WITH AERIAL					
C-3	EXISTING UTILITIES PLAN					
C-4	EXISTING LIGHTING PLAN					
C-5	EROSION AND SEDIMENTATION CONTROL PLAN					
C-6	PROPOSED DEMOLITION PLAN					
C-7	PROPOSED SITE PLAN					
C-8	PROPOSED LIGHTING PLAN					
D-1	DETAILS I					
D-2	DETAILS II					
D 0	DETAIL O. III					

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C-8	PROPOSED LIGHTING PLAN					
D-1	DETAILS I					
D-2	DETAILS II					
D-3	DETAILS III					

	SITE INFORMATION TABLE (SEE NOTE 1)
LOCATION:	ONE NSTAR WAY
MAP / LOT:	37_008
USE CODE:	3400
LAND OWNER:	NSTAR ELECTRIC COMPANY
OWNER ADDRESS:	P.O. BOX 270
OWNER CITY:	HARTFORD
OWNER STATE:	CONNECTICUT
OWNER ZIP:	06141-0270
ZONING:	INDUSTRIAL (I)
OVERLAY DISTRICTS:	ACCESS APPROVAL OVERLAY DISTRICT (AAOD) FLEXIBLE MULTIPLE USE OVERLAY DISTRICT (FMUOD1)

SOLAR PHOTOVOLTAIC (PV) SYSTEM DESCRIPTION

TILT ANGLE | SEE CARPORT INFORMATION TABLE (G-1 SHEET)

AZIMUTH | SEE CARPORT INFORMATION TABLE (G-1 SHEET)

RACKING | SEE CARPORT INFORMATION TABLE (G-1 SHEET)

±1,740 kW (AC)

| SYSTEM SIZE (@ STC) | ±2,270.4 kW (DC)

INVERTER(S) (29) 60 kW

MODULE (5,676) 400 WATT

INDUST	RIAL (I) ZONING TABLE (S		SITE INFORMATION TABLE (SEE NOTE 1)	
MAP / LOT: -	37_	_008	LOCATION:	ONE NSTAR WAY
REGULATION REQUIREMENTS REQUIRED*	EXISTING	PROPOSED**	MAP / LOT:	37_008
MIN. FRONT YARD SETBACK (FT.): 50	±153	±50	USE CODE:	3400
MIN. SIDE YARD SETBACK (FT.): 15	±252	±139	LAND OWNER:	NSTAR ELECTRIC COMPANY
MIN. REAR YARD SETBACK (FT.): 15	±45	±45	OWNER ADDRESS:	P.O. BOX 270
MIN. LOT AREA (SQ. FT.): 40,000	±1,191,801.6	±1,191,801.6	OWNER CITY:	HARTFORD
BUILDING COVERAGE (SQ. FT.): ±595,900.8	±114,808.84	±246,399.46	OWNER STATE:	CONNECTICUT
MAX. BUILDING COVERAGE (%): 50	±9.64	±41.35	OWNER ZIP:	06141-0270
IMPERVIOUS AREA (SQ. FT.): ±953,441.28	±650,000	±651,000	ZONING:	INDUSTRIAL (I)
MAX. IMPERVIOUS COVERAGE (%): 80	±54.54	±54.63	OVERLAY	ACCESS APPROVAL OVERLAY DISTRICT (AA
DUSTRIAL (I) NOTES:			DISTRICTS:	FLEXIBLE MULTIPLE USE OVERLAY DISTRICT (FI
DOSTRIAL (I) NOTES.			PARCEL AREA:	±27.36 ACRES (±1,191,801.6 SQ. FT.)

1. EXISTING CONDITIONS AND SITE INFORMATION FROM THE ZONING BYLAW OF THE TOWN OF WESTWOOD, TOWN OF WESTWOOD GIS AND MASSACHUSETTS GIS. ALL QUANTITIES ARE APPROXIMATE.

EVERSURCE EVERSOURCE ENERGY P.O. BOX 5017

HARTFORD, CT. 06102 **MASSACHUSETTS**

> 1 NSTAR WAY WESTWOOD, MA

PHOTOVOLTAIC

PROGRAM - ROUND II



Weston & Sampson Engineers, Inc. 5 Centennial Drive Peabody, Massachusetts (978) 532-1900 (800) Sampson www.westonandsampson.com

Rev Date Description JOB NO. 2170318.B PERMIT SET NOT FOR CONSTRUCTION

08.15.17

AS SHOWN

Drawing Title: COVER SHEET Sheet Number:

Designed By:

Checked By:

Approved By:

LEGEND ☐ ☐ CATCH BASIN S SEWER MANHOLE ● ⑤ ELECTRIC MANHOLE • TELEPHONE MANHOLE ☐ HH - HANDHOLE BOLLARD WATER GATE FIRE HYDRANT G GAS GATE STREET SIGN → UTILITY POLE GUY POLE GUY WIRE MONITORING WELL WELL WELL ▶ FLOOD LIGHT ② TOTAL PARKING SPACES L HANDICAP SYMBOL ★ SHRUB ⇔ SMALL TREE (FP) FLAG POLE STRAW WATTLE (PROPOSED) PV MODULES (PROPOSED) F.F.E.=45.27′ **FINISHED FLOOR ELEVATION** EDGE OF PAVEMENT = CONCRETE CURB VERTICAL GRANITE CURB SLOPED GRANITE EDGE BITUMINOUS BERM BITUMINOUS CURB GUARD RAIL-WOOD POST ---- DRAINAGE LINE — — — — SEWER LINE — · · · — OVERHEAD WIRE —— E — UNDERGROUND ELECTRIC T TELEPHONE LINE — G — GAS LINE -- GAS LINE (FROM PROPOSED PLANS)

——w—— WATER LINE

OOOOOO STONE WALL
TREE LINE

WETLAND BOUNDARY

EXISTING PAVEMENT

PROPERTY LINE

PROPERTY SETBACK LINE
----- CARPORT LIMIT (PROPOSED)

---- WATER LINE (FROM PROPOSED PLANS)

PROTECTION OF EXISTING PROPERTY:

- 1. THE WORK SHALL BE EXECUTED IN SUCH A MANNER AS TO PREVENT ANY DAMAGE TO FACILITIES AT THE SITE AND ADJACENT PROPERTY AND EXISTING IMPROVEMENTS SUCH AS, BUT NOT LIMITED TO, STREETS, CURBS, PAVING, SERVICE UTILITY LINES, STRUCTURES, MONUMENTS, BENCH MARKS, OBSERVATION WELLS, AND OTHER PUBLIC OR PRIVATE PROPERTY. PROTECT EXISTING IMPROVEMENTS FROM DAMAGE CAUSED BY SETTLEMENT, LATERAL MOVEMENTS, UNDERMINING, WASHOUT AND OTHER HAZARDS CREATED BY EARTHWORK OPERATIONS.
- 2. IN CASE OF ANY DAMAGE OR INJURY CAUSED IN THE PERFORMANCE OF THE WORK, THE CONTRACTOR SHALL, AT ITS OWN EXPENSE, MAKE REPAIR/REPLACE OF SUCH DAMAGE OR INJURY TO THE SATISFACTION OF, AND WITHOUT COST TO, THE OWNER. EXISTING ROADS, SIDEWALKS, AND CURBS DAMAGED DURING THE PROJECT WORK SHALL BE REPAIRED OR REPLACED TO AT LEAST THE PRE-CONSTRUCTION CONDITION. THE CONTRACTOR SHALL REPLACE, AT HIS OWN COST, EXISTING BENCHMARKS, OBSERVATION WELLS, MONUMENTS, AND OTHER REFERENCE POINTS WHICH ARE DISTURBED OR DESTROYED.
- 3. BURIED DRAINAGE STRUCTURES AND PIPES, OBSERVATION WELLS, PIEZOMETERS, INCLUDING THOSE WHICH PROJECT LESS THAN EIGHTEEN INCHES (18") ABOVE GRADE, WHICH ARE SUBJECT TO DAMAGE FROM CONSTRUCTION EQUIPMENT SHALL BE CLEARLY MARKED TO INDICATE THE HAZARD. MARKERS SHALL INDICATE LIMITS OF DANGER AREAS, BY MEANS WHICH WILL BE CLEARLY VISIBLE TO OPERATORS OF TRUCKS AND OTHER CONSTRUCTION EQUIPMENT, AND SHALL BE MAINTAINED AT ALL TIMES UNTIL COMPLETION OF PROJECT.

DRAINAGE:

1. THE CONTRACTOR SHALL PROVIDE, AT ITS OWN EXPENSE, ADEQUATE DRAINAGE FACILITIES TO COMPLETE ALL WORK ITEMS IN AN ACCEPTABLE MANNER. DRAINAGE SHALL BE DONE IN A MANNER SO THAT RUNOFF WILL NOT ADVERSELY AFFECT CONSTRUCTION PROCEDURES NOR CAUSE EXCESSIVE DISTURBANCE OF UNDERLYING NATURAL GROUND OR ABUTTING PROPERTIES.

FROST PROTECTION AND SNOW REMOVAL:

- THE CONTRACTOR SHALL, AT ITS OWN EXPENSE, KEEP EARTHWORK OPERATIONS CLEAR AND FREE OF ACCUMULATIONS OF SNOW AS REQUIRED TO CARRY OUT THE WORK.
- 2. THE CONTRACTOR SHALL PROTECT THE SUBGRADE BENEATH NEW STRUCTURES AND PIPES FROM FROST PENETRATION WHEN FREEZING TEMPERATURES ARE EXPECTED.

CONSTRUCTION NOTES:

- 1. THE CONTRACTOR SHALL CALL DIGSAFE AT 811 OR 1-888-344-7233 AT LEAST 72 HOURS, SATURDAYS, SUNDAYS, AND HOLIDAYS EXCLUDED, PRIOR TO EXCAVATING AT ANY LOCATION. A COPY OF THE DIGSAFE PROJECT REFERENCE NUMBER(S) SHALL BE GIVEN TO THE OWNER PRIOR TO EXCAVATION.
- 2. LOCATIONS OF EXISTING PIPES, CONDUITS, UTILITIES, FOUNDATIONS AND OTHER UNDERGROUND OBJECTS ARE NOT WARRANTED TO BE CORRECT AND THE CONTRACTOR SHALL HAVE NO CLAIM ON THAT ACCOUNT SHOULD THEY BE OTHER THAN SHOWN. CONTRACTOR TO RELOCATE ANY EXISTING UTILITIES FOUND TO BE IN CONFLICT WITH FOUNDATION LOCATIONS.
- 3. STONE WALLS, FENCES, CURBS, ETC. SHALL BE REMOVED AND REPLACED AS NECESSARY TO PERFORM THE WORK. UNLESS OTHERWISE INDICATED, ALL SUCH WORK SHALL BE INCIDENTAL TO CONSTRUCTION OF THE PROJECT.
- 4. ALL AREAS DISTURBED BY THE CONTRACTOR BEYOND PAYMENT LIMITS SHALL BE RESTORED AT NO ADDITIONAL COST TO THE OWNER.
- 5. THE FOLLOWING NOTES ARE PROVIDED AS A SUMMARY REFERENCE FOR THE CONTRACTOR ONLY. THE REQUIREMENTS IN THE FULL SPECIFICATIONS FOR THE PROJECT SHALL BE FOLLOWED BY THE CONTRACTOR. IN THE EVENT OF A CONFLICT BETWEEN THE DRAWINGS AND THE SPECIFICATIONS, THE ENGINEER SHALL DETERMINE THE CORRECT REQUIREMENTS.
- 6. PRIOR TO CONSTRUCTION, CONTRACTOR TO SUBMIT A CONSTRUCTION SEQUENCE/TRAFFIC AND CONSTRUCTION PARKING PLAN. PLAN SHALL DETAIL CONSTRUCTION PHASING TIED TO SCHEDULE, TRAFFIC FLOW AND PARKING AREAS TO BE USED DURING CONSTRUCTION.

				CARPORT INFORMATION	I TABLE*			
CARPORT	CARPORT TYPE	LENGTH (FT.)	WIDTH (FT.)	TILT (DEGREES)	AZIMUTH (DEGREES)	MODULE QTY.	SYSTEM SIZE kW (DC)	FOUNDATIONS QTY.
1	DUAL-TILT	±300.6522	±41.6688	±1 (L.S.) / ±7 (H.S.)**	±146	±540	±216	10
2	DUAL-TILT	±240.5135	±41.6688	±1 (L.S.) / ±7 (H.S.)**	±146	±432	±172.8	8
3	DUAL-TILT	±220.4672	±41.6688	±1 (L.S.) / ±7 (H.S.)**	±146	±396	±158.4	8
4	DUAL-TILT	±193.7388	±41.6688	±1 (L.S.) / ±7 (H.S.)**	±146	±348	±139.2	7
5	DUAL-TILT	±180.3747	±41.6688	±1 (L.S.) / ±7 (H.S.)**	±146	±324	±129.6	6
6	DUAL-TILT	±180.3747	±41.6688	±1 (L.S.) / ±7 (H.S.)**	±146	±324	±129.6	6
7	DUAL-TILT	±180.3747	±41.6688	±1 (L.S.) / ±7 (H.S.)**	±146	±324	±129.6	6
8	DUAL-TILT	±193.7388	±41.6688	±1 (L.S.) / ±7 (H.S.)**	±146	±348	±139.2	7
9	DUAL-TILT	±187.0568	±34.8213	±1 (L.S.) / ±7 (H.S.)**	±180	±280	±112	8
10	DUAL-TILT	±153.6463	±41.6688	±1 (L.S.) / ±7 (H.S.)**	±198	±276	±110.4	6
11	DUAL-TILT	±73.4163	±41.6688	±1 (L.S.) / ±7 (H.S.)**	±214	±132	±52.8	3
12	DUAL-TILT	±120.2359	±41.6688	±1 (L.S.) / ±7 (H.S.)**	±94	±216	±86.4	5
13	DUAL-TILT	±120.2359	±41.6688	±1 (L.S.) / ±7 (H.S.)**	±107	±216	±86.4	5
14	DUAL-TILT	±173.6926	±41.6688	±1 (L.S.) / ±7 (H.S.)**	±120	±312	±124.8	7
15	SINGLE-SIDED	±146.9642	±27.1233	±7	±108	±176	±70.4	5
16	DUAL-TILT	±66.7792	±41.6688	±1 (L.S.) / ±7 (H.S.)**	±108	±120	±48	3
17	DUAL-TILT	±193.7388	±41.6688	±1 (L.S.) / ±7 (H.S.)**	±108	±348	±139.2	7
18	DUAL-TILT	±314.0164	±41.6688	±1 (L.S.) / ±7 (H.S.)**	±108	±564	±225.6	11
				•	TOTALS	±5,676	±2,270.4 kW (DC)	118

CARPORT INFORMATION TABLE NOTES:

*PROPOSED DIMENSIONS AND QUANTITIES ARE APPROXIMATE AND SUBJECT TO CHANGE BASED ON FINAL ENGINEERED DESIGN. FINAL PROPOSED SETBACKS AND DIMENSIONS SHALL BE DESIGNED TO MEET MINIMUM ZONING REQUIREMENTS.

**LOW SIDE (L.S.) AND HIGH SIDE (H.S.) TILT ANGLES FOR DUAL-TILTED CARPORTS.

PHOTOVOLTAIC
PROGRAM - ROUND II

1 NSTAR WAY
WESTWOOD, MA

EVERS

EVERSOURCE ENERGY

P.O. BOX 5017

HARTFORD, CT. 06102

MASSACHUSETTS

02090

Project:

Weston & Sampson Engineers, Inc.
5 Centennial Drive Peabody, Massachusetts
(978) 532-1900 (800) Sampson
www.westonandsampson.com

Revisions:

Rev Date Description

Seal:

THOF MASO

FRANCIS M
RICCIARDI
CIVIO
NO. MEGG

JOB NO. 2170318.B
PERMIT SET
NOT FOR CONSTRUCTION

Date: 08.15.17

Scale: AS SHOWN

Designed By: RWG

Reviewed By: RWG

Checked By: SPW


Approved By: FMR

Drawing Title:

GENERAL NOTES
AND LEGEND

Sheet Number:

G-1

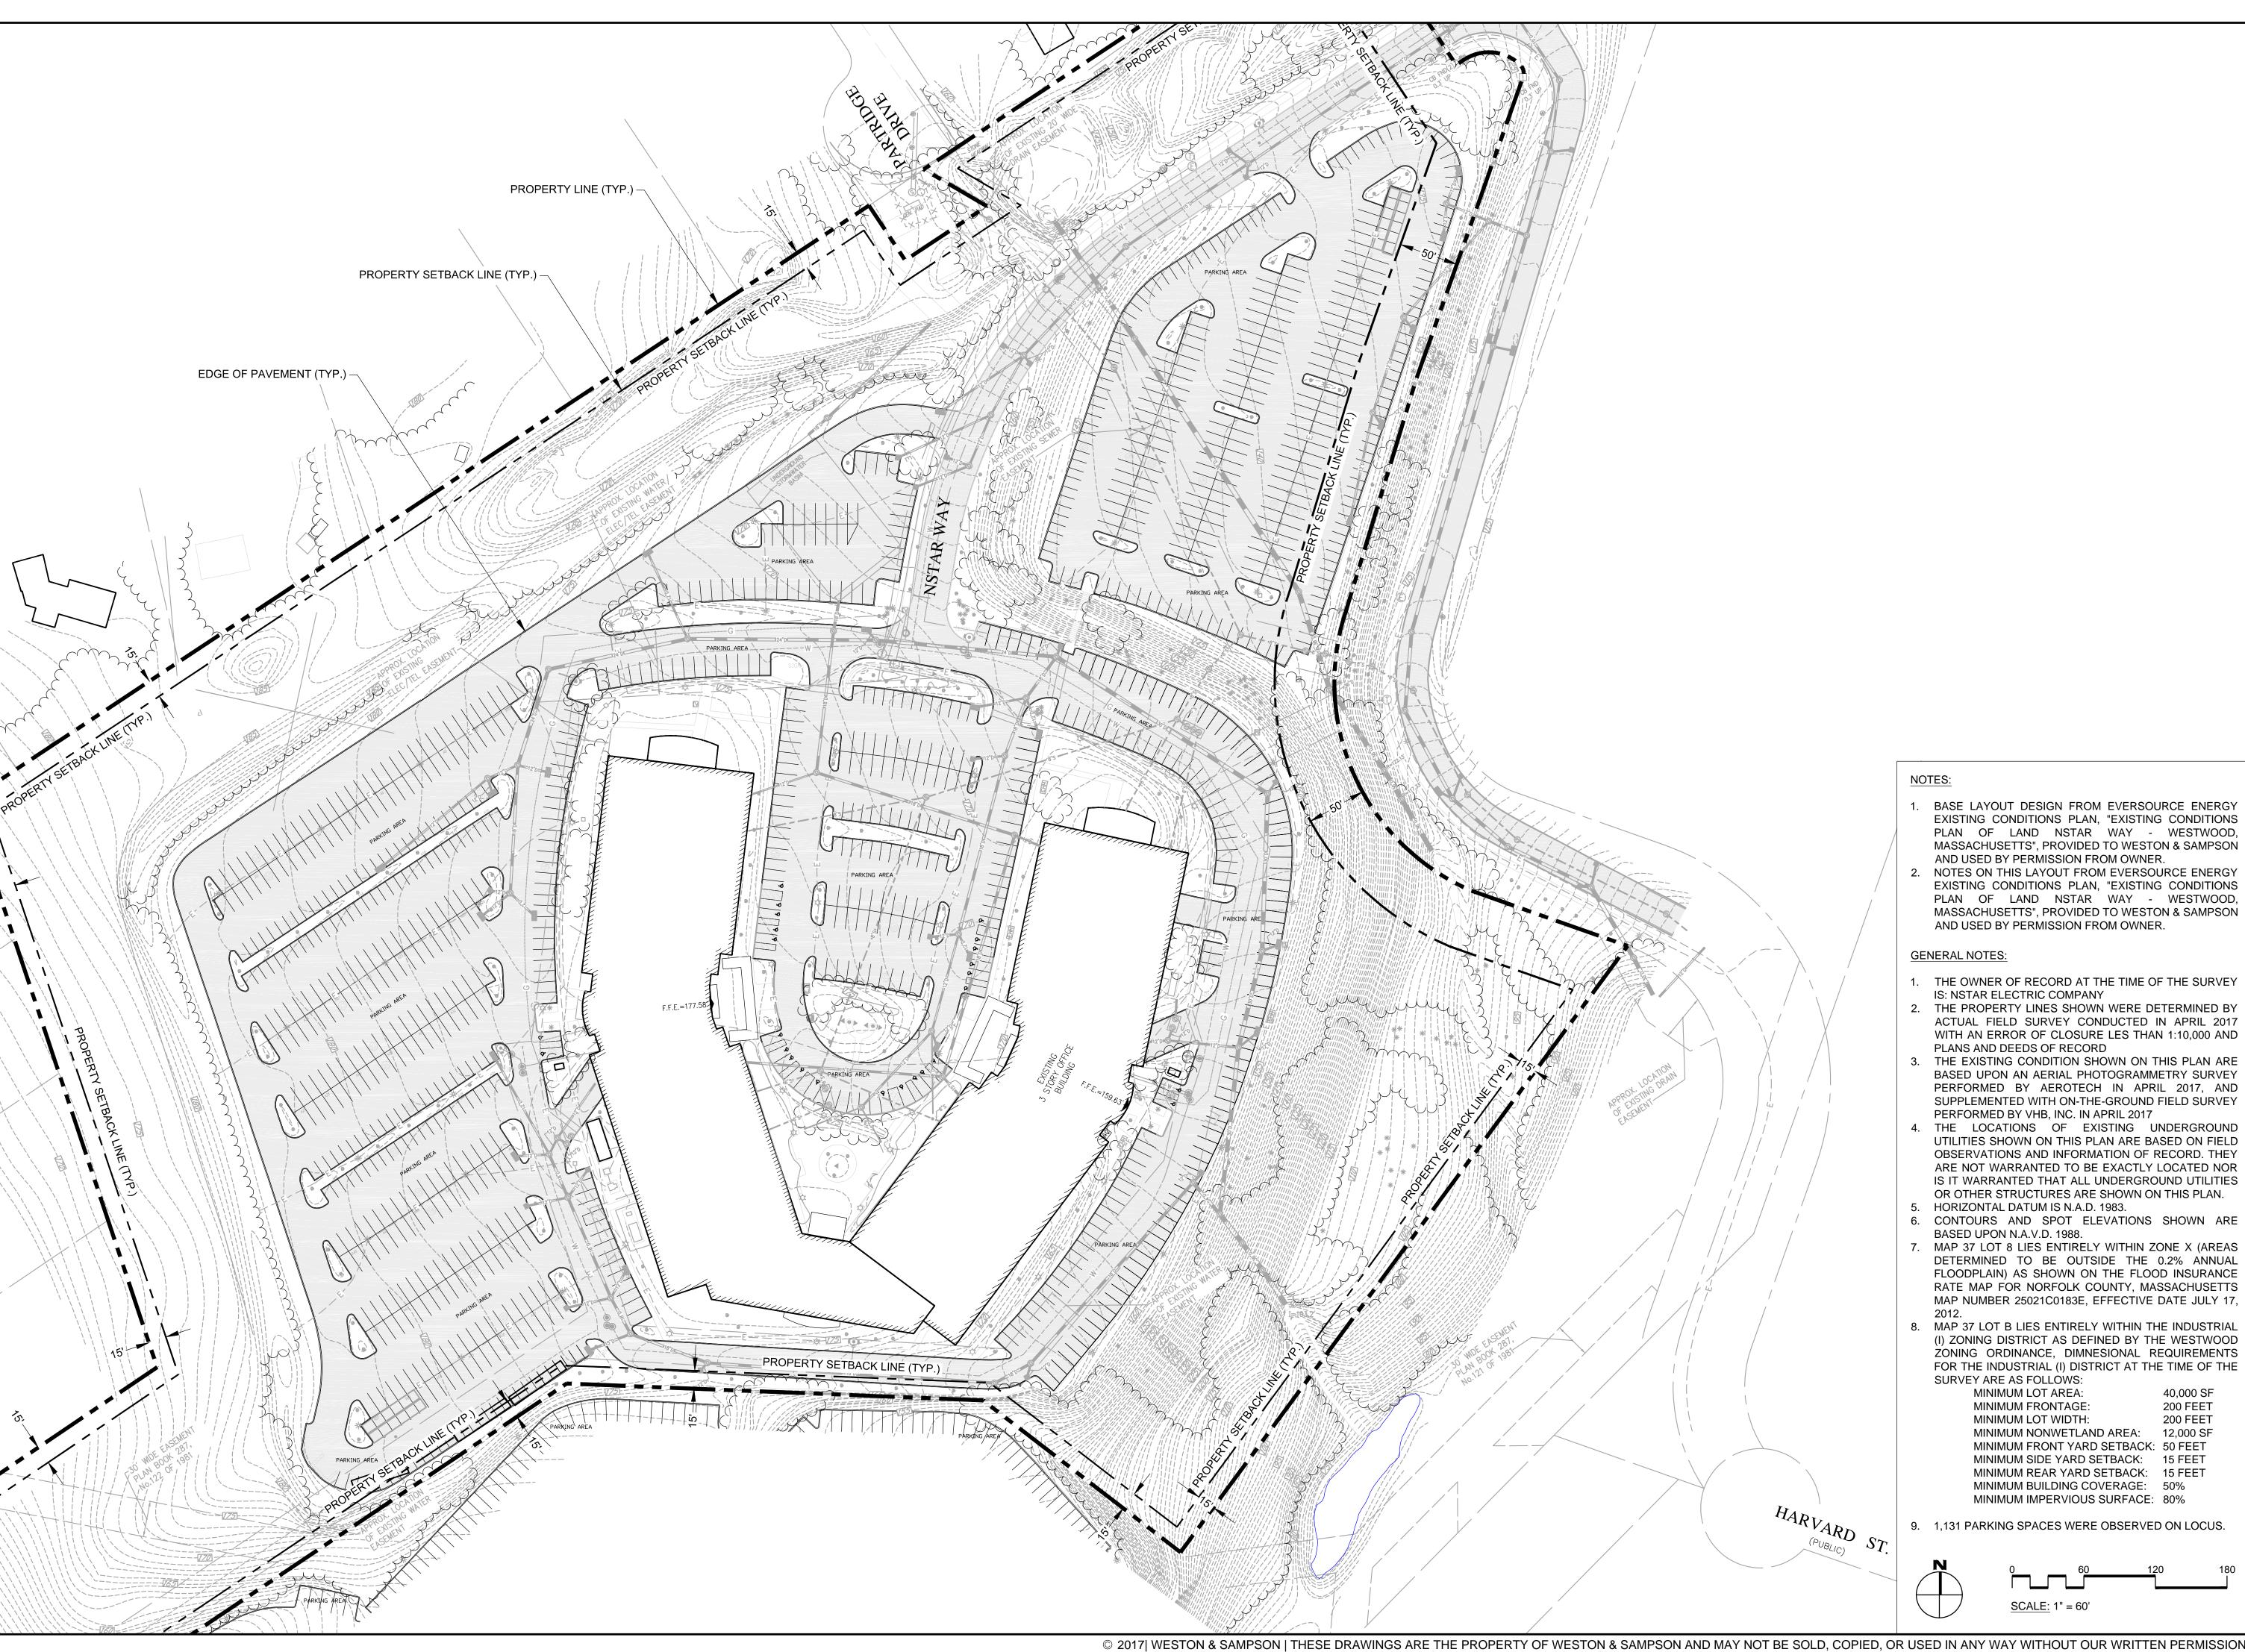

EVERSURCE EVERSOURCE ENERGY P.O. BOX 5017 HARTFORD, CT. 06102 **MASSACHUSETTS**

> 1 NSTAR WAY WESTWOOD, MA

PHOTOVOLTAIC

PROGRAM - ROUND II

Weston & Sampson Weston & Sampson Engineers, Inc.
5 Centennial Drive Peabody, Massachusetts (978) 532-1900 (800) Sampson www.westonandsampson.com

Rev Date Description

JOB NO. 2170318.B PERMIT SET NOT FOR CONSTRUCTION

08.15.17 **AS SHOWN** Designed By:

Reviewed By: Checked By: Approved By:

Drawing Title:

40,000 SF

200 FEET

200 FEET

EXISTING CONDITIONS




Rev Date Description

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EXISTING CONDITIONS PLAN WITH AERIAL



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> **PHOTOVOLTAIC** PROGRAM - ROUND II

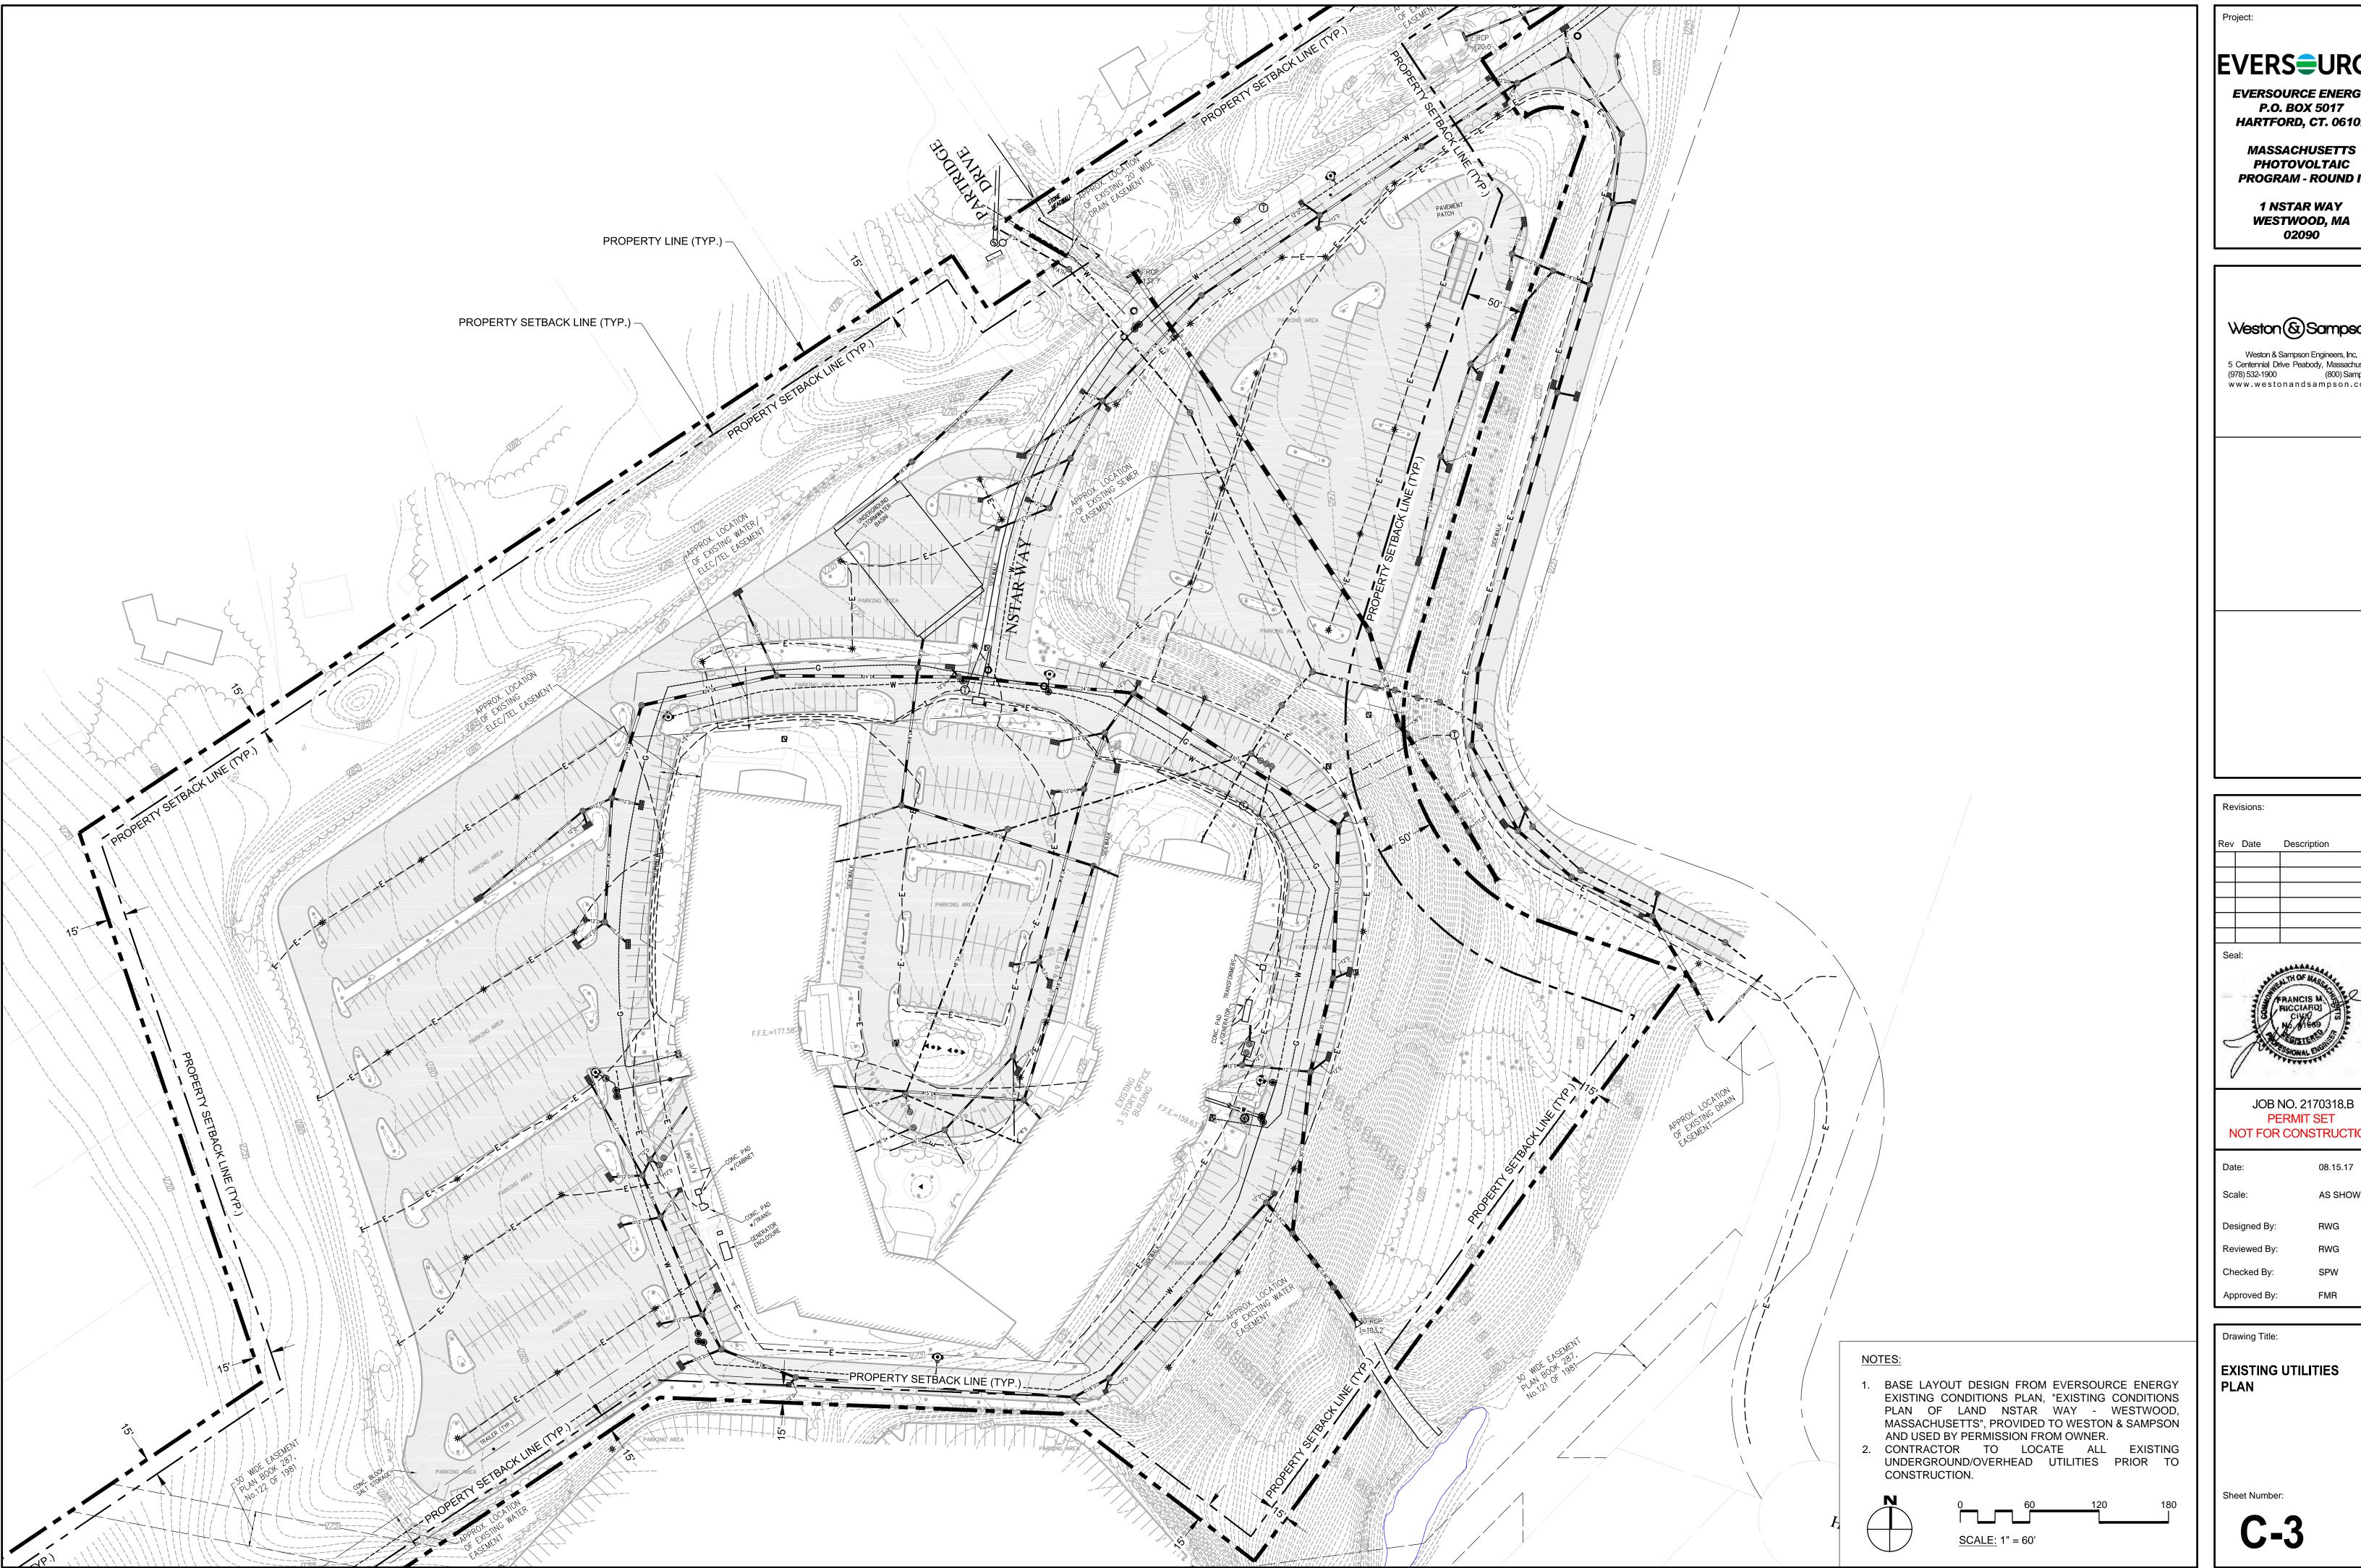Weston & Sampsoñ


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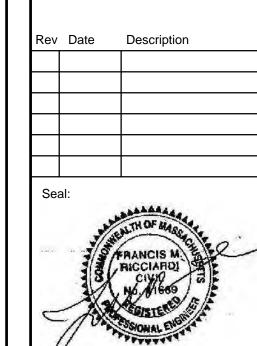
AS SHOWN

EXISTING UTILITIES



EVERSURCE EVERSOURCE ENERGY P.O. BOX 5017 HARTFORD, CT. 06102 **MASSACHUSETTS**


> Weston & Sampsoñ Weston & Sampson Engineers, Inc.
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EXISTING LIGHTING

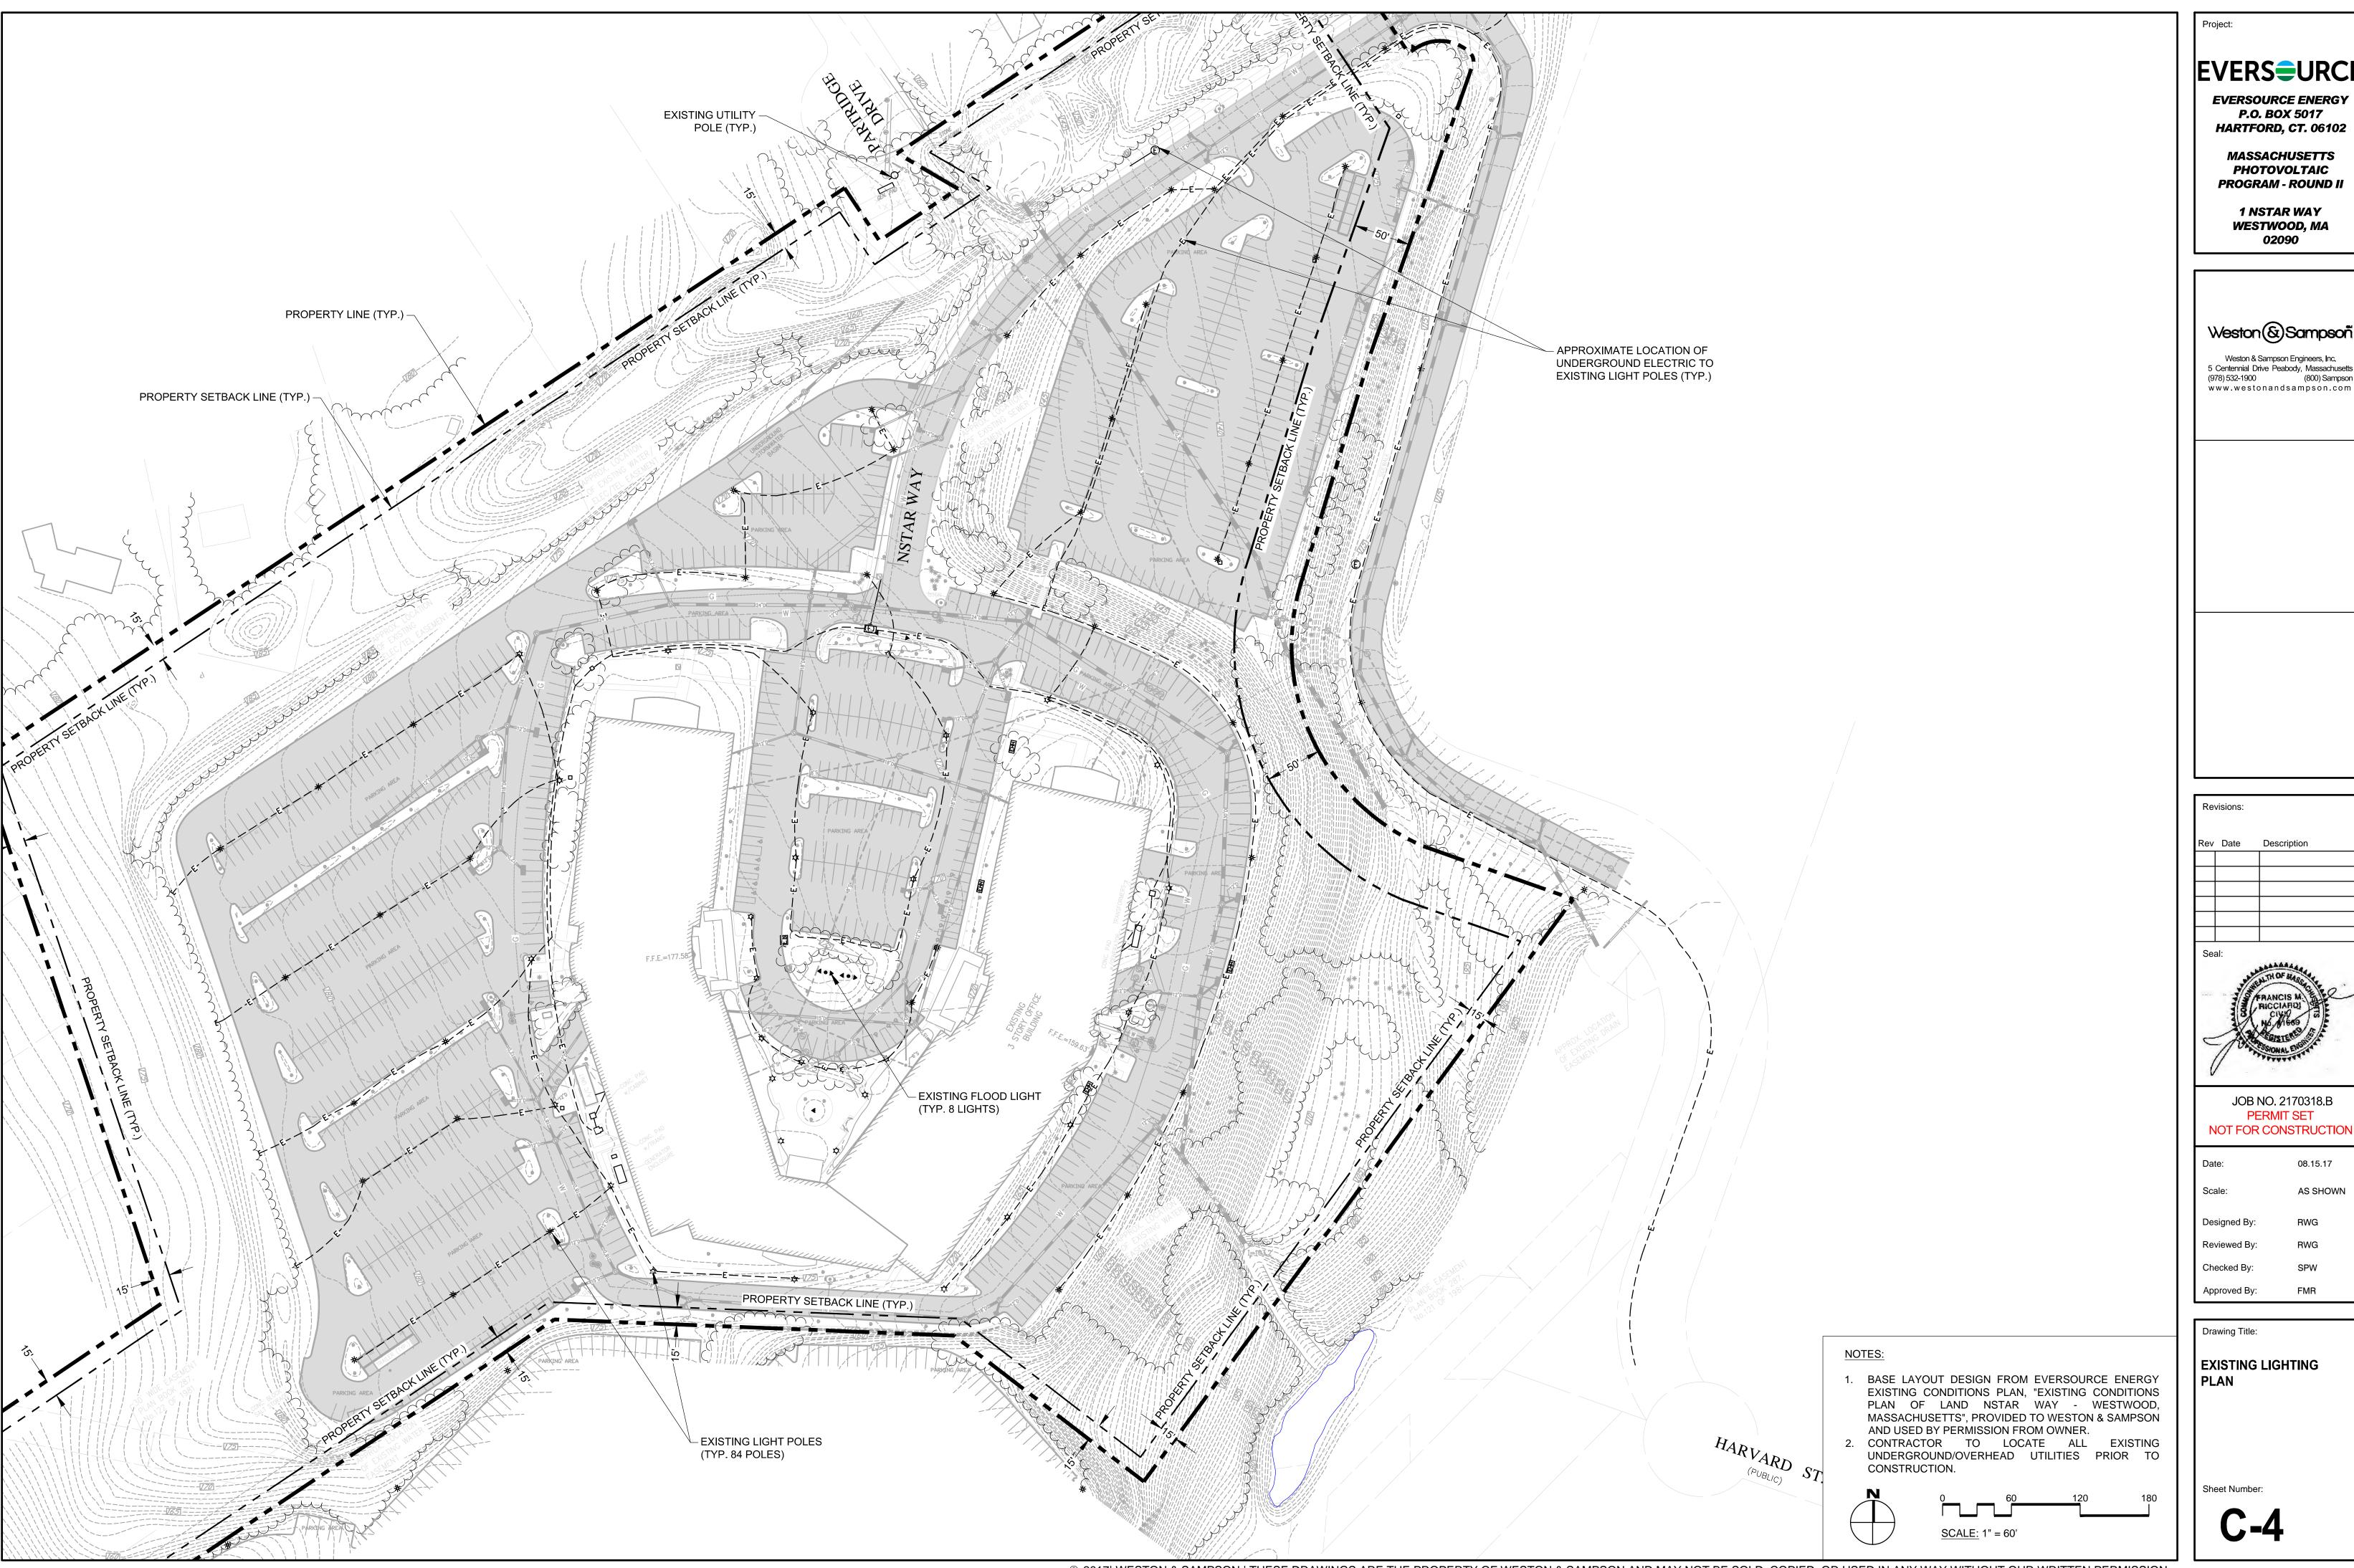

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PHOTOVOLTAIC PROGRAM - ROUND II

1 NSTAR WAY

WESTWOOD, MA

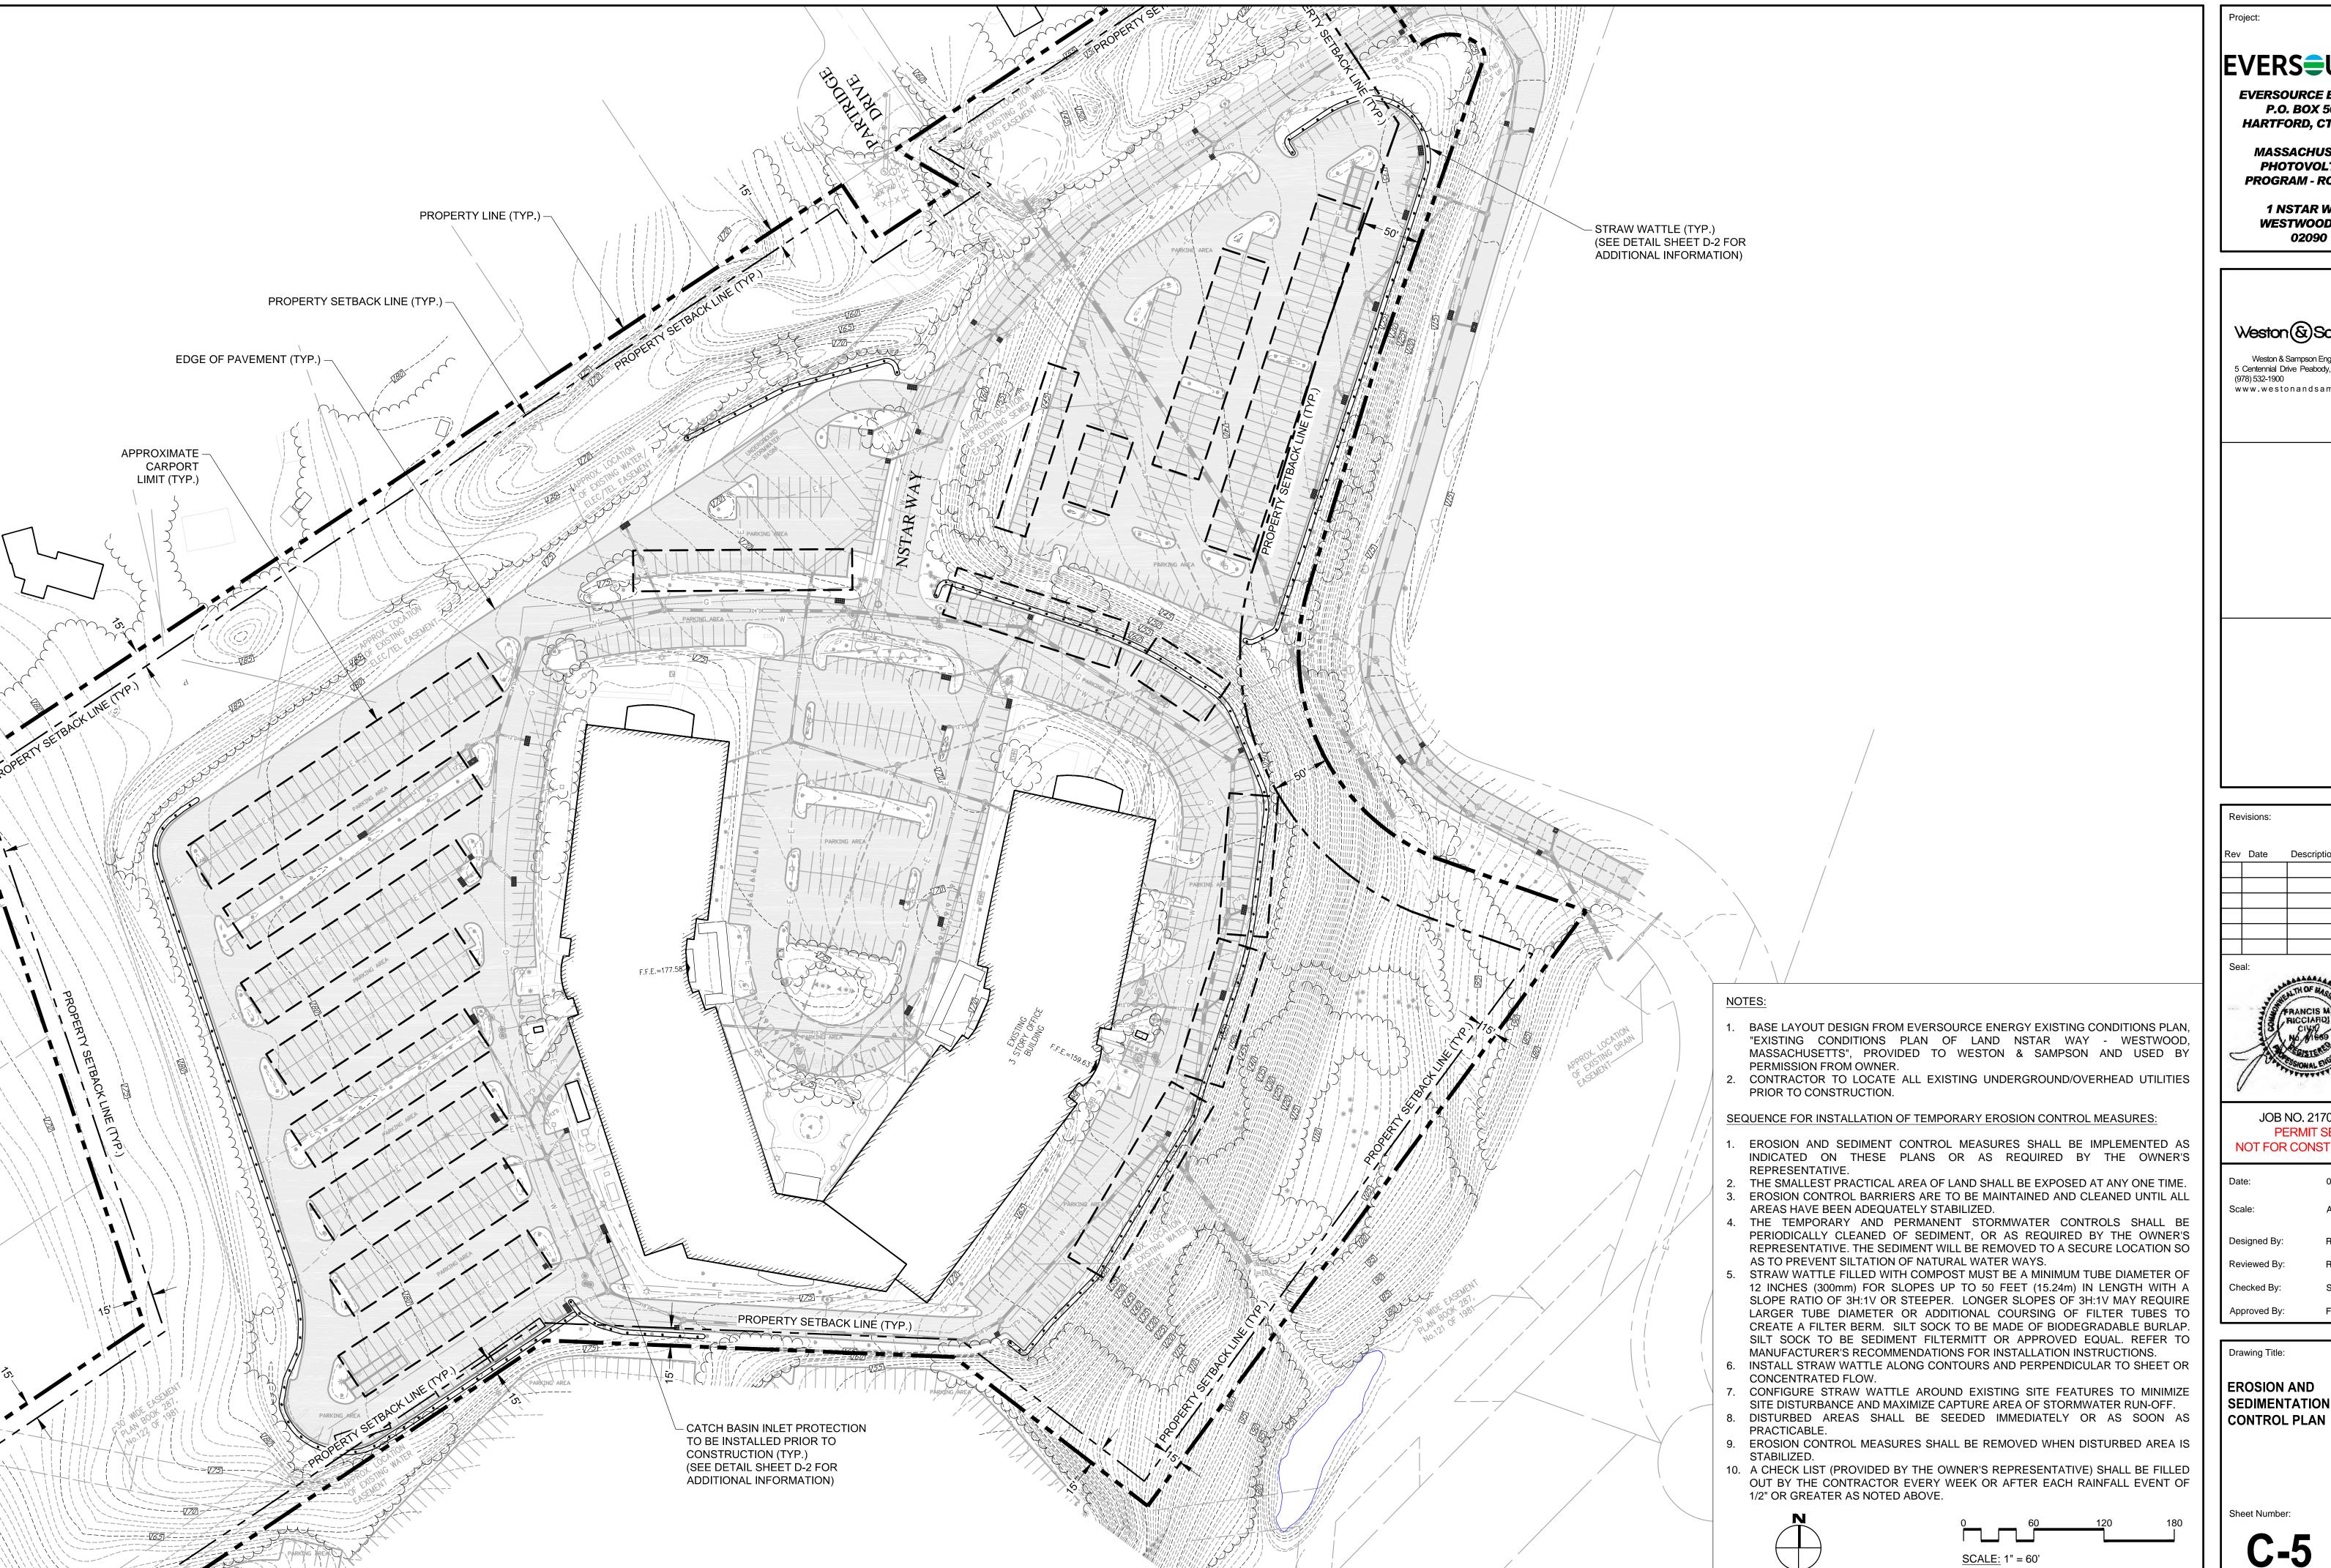MASSACHUSETTS

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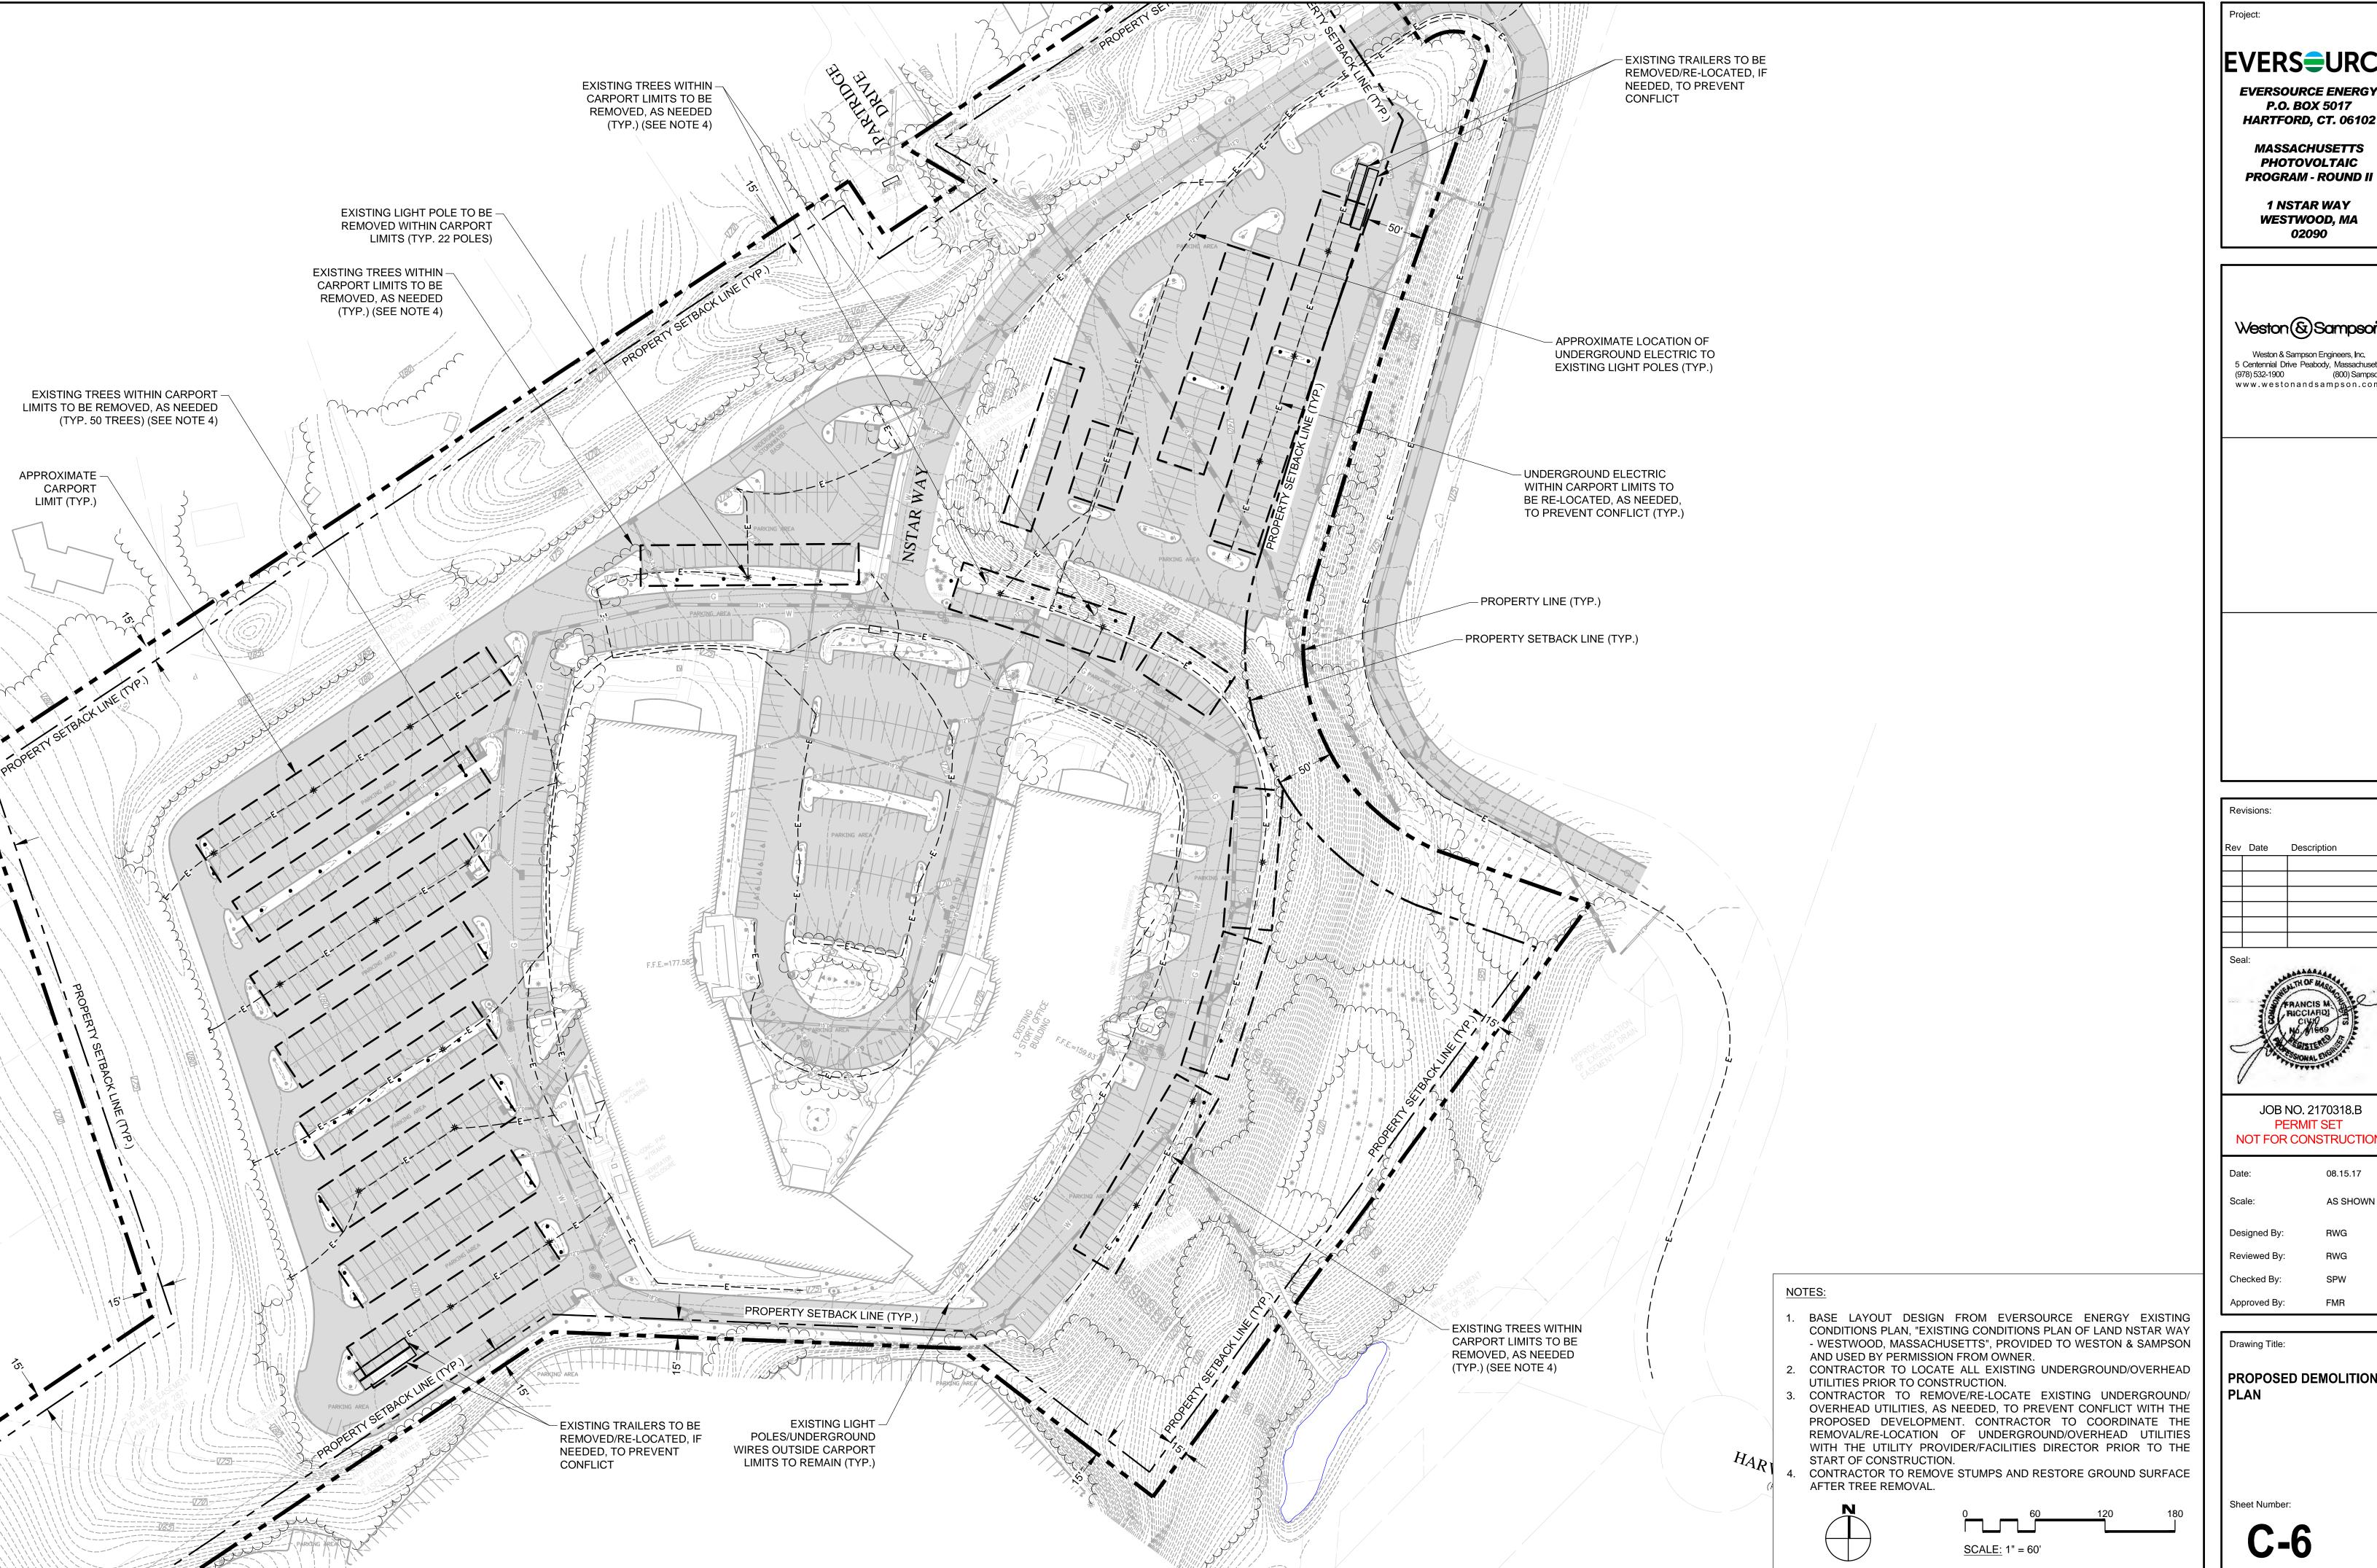
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Designed By: Checked By:

Drawing Title:

EROSION AND SEDIMENTATION



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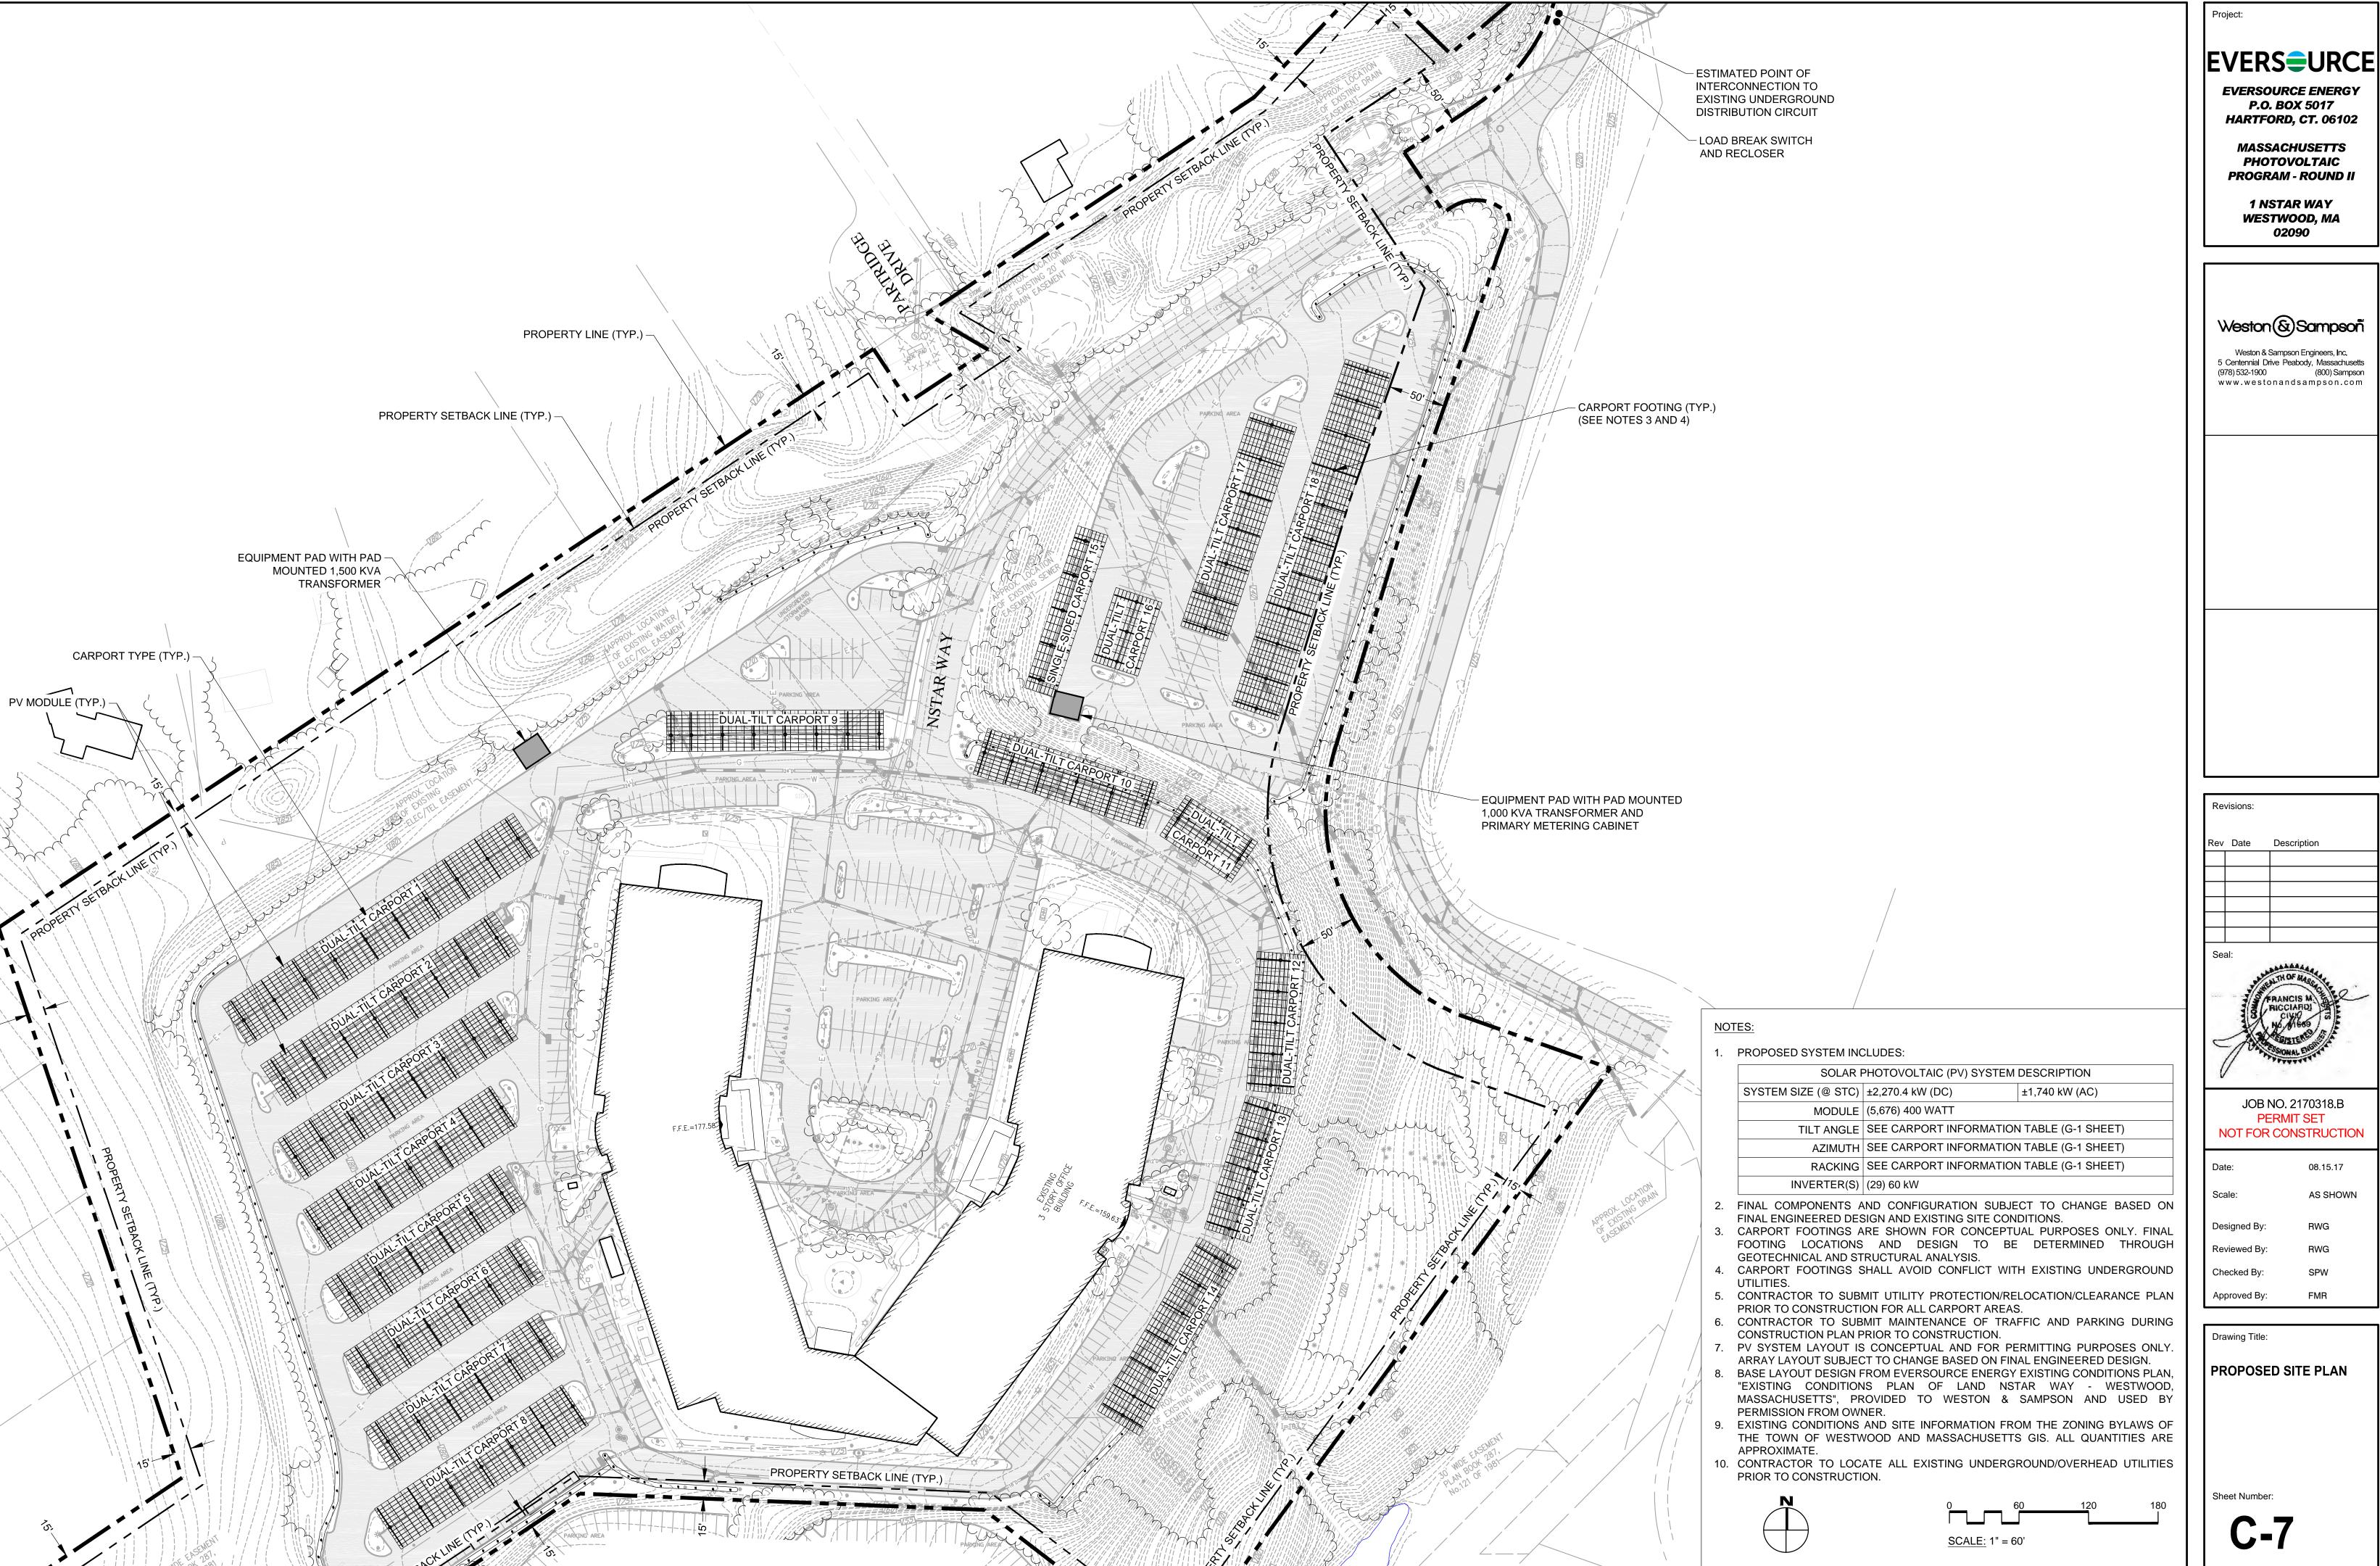
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Rev	Date	Description
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	100	SIONAL ENGINEER
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08.15.17 AS SHOWN

PROPOSED DEMOLITION



EVERSOURCE ENERGY

HARTFORD, CT. 06102

1 NSTAR WAY WESTWOOD, MA

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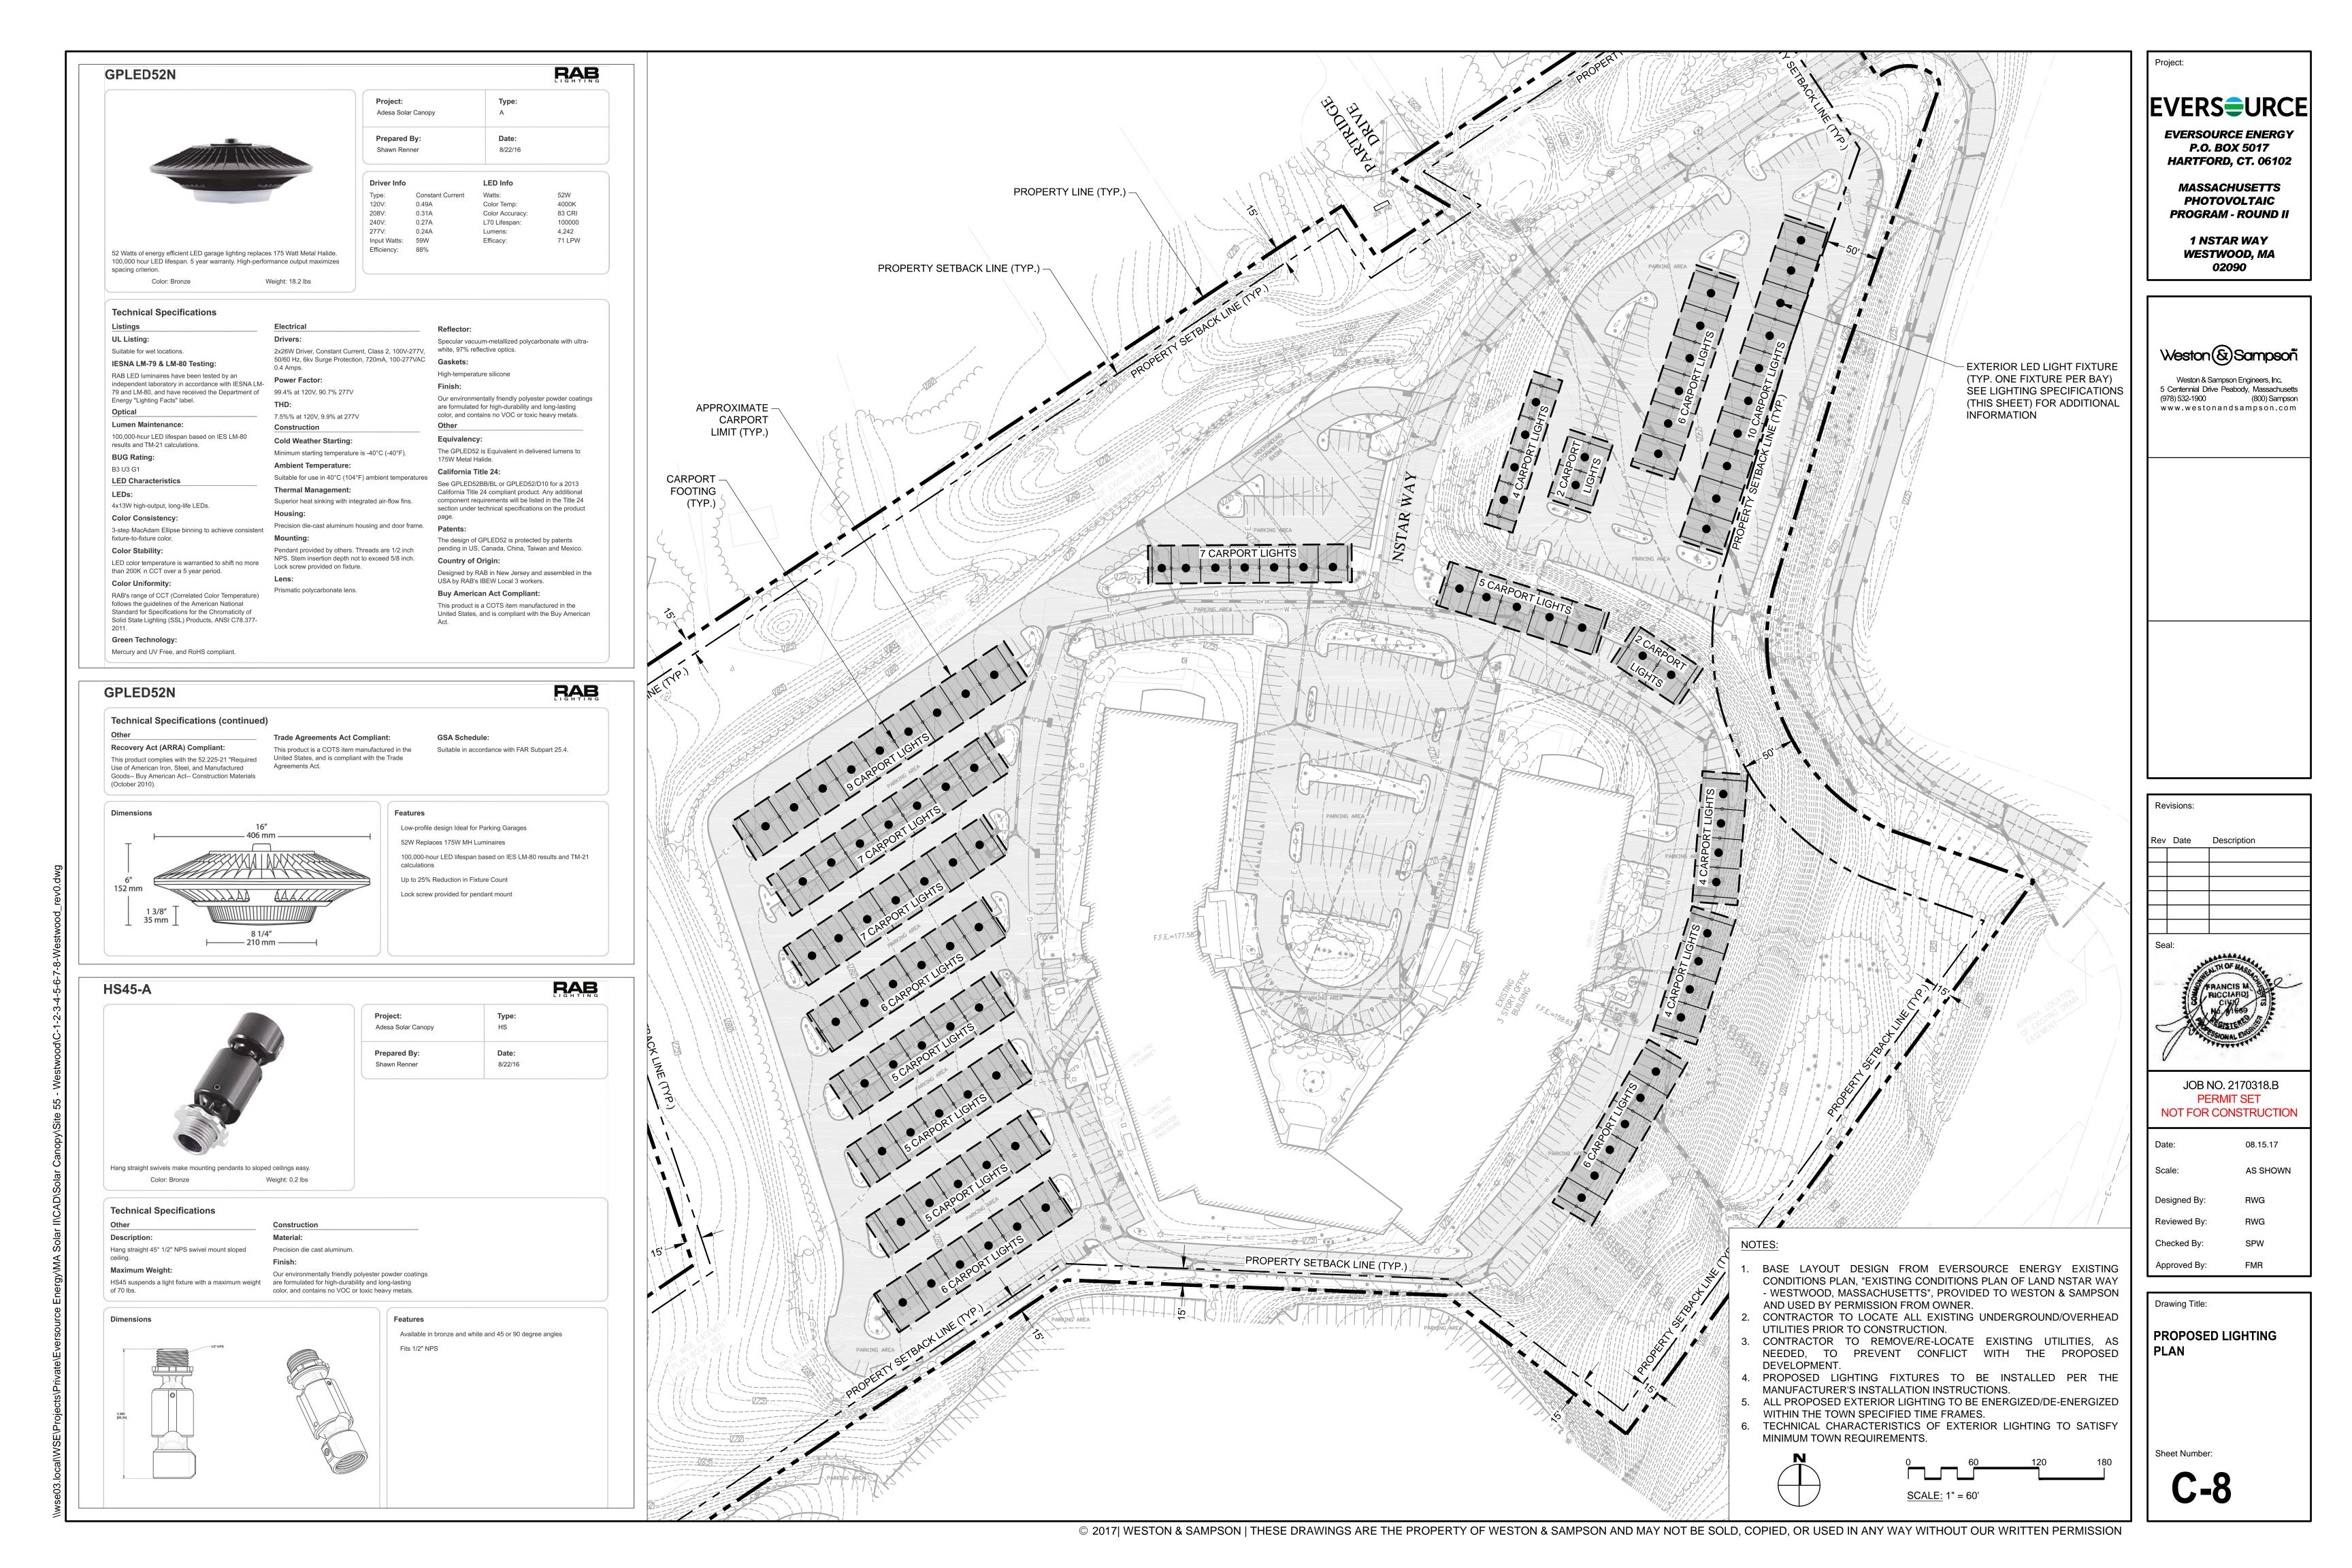
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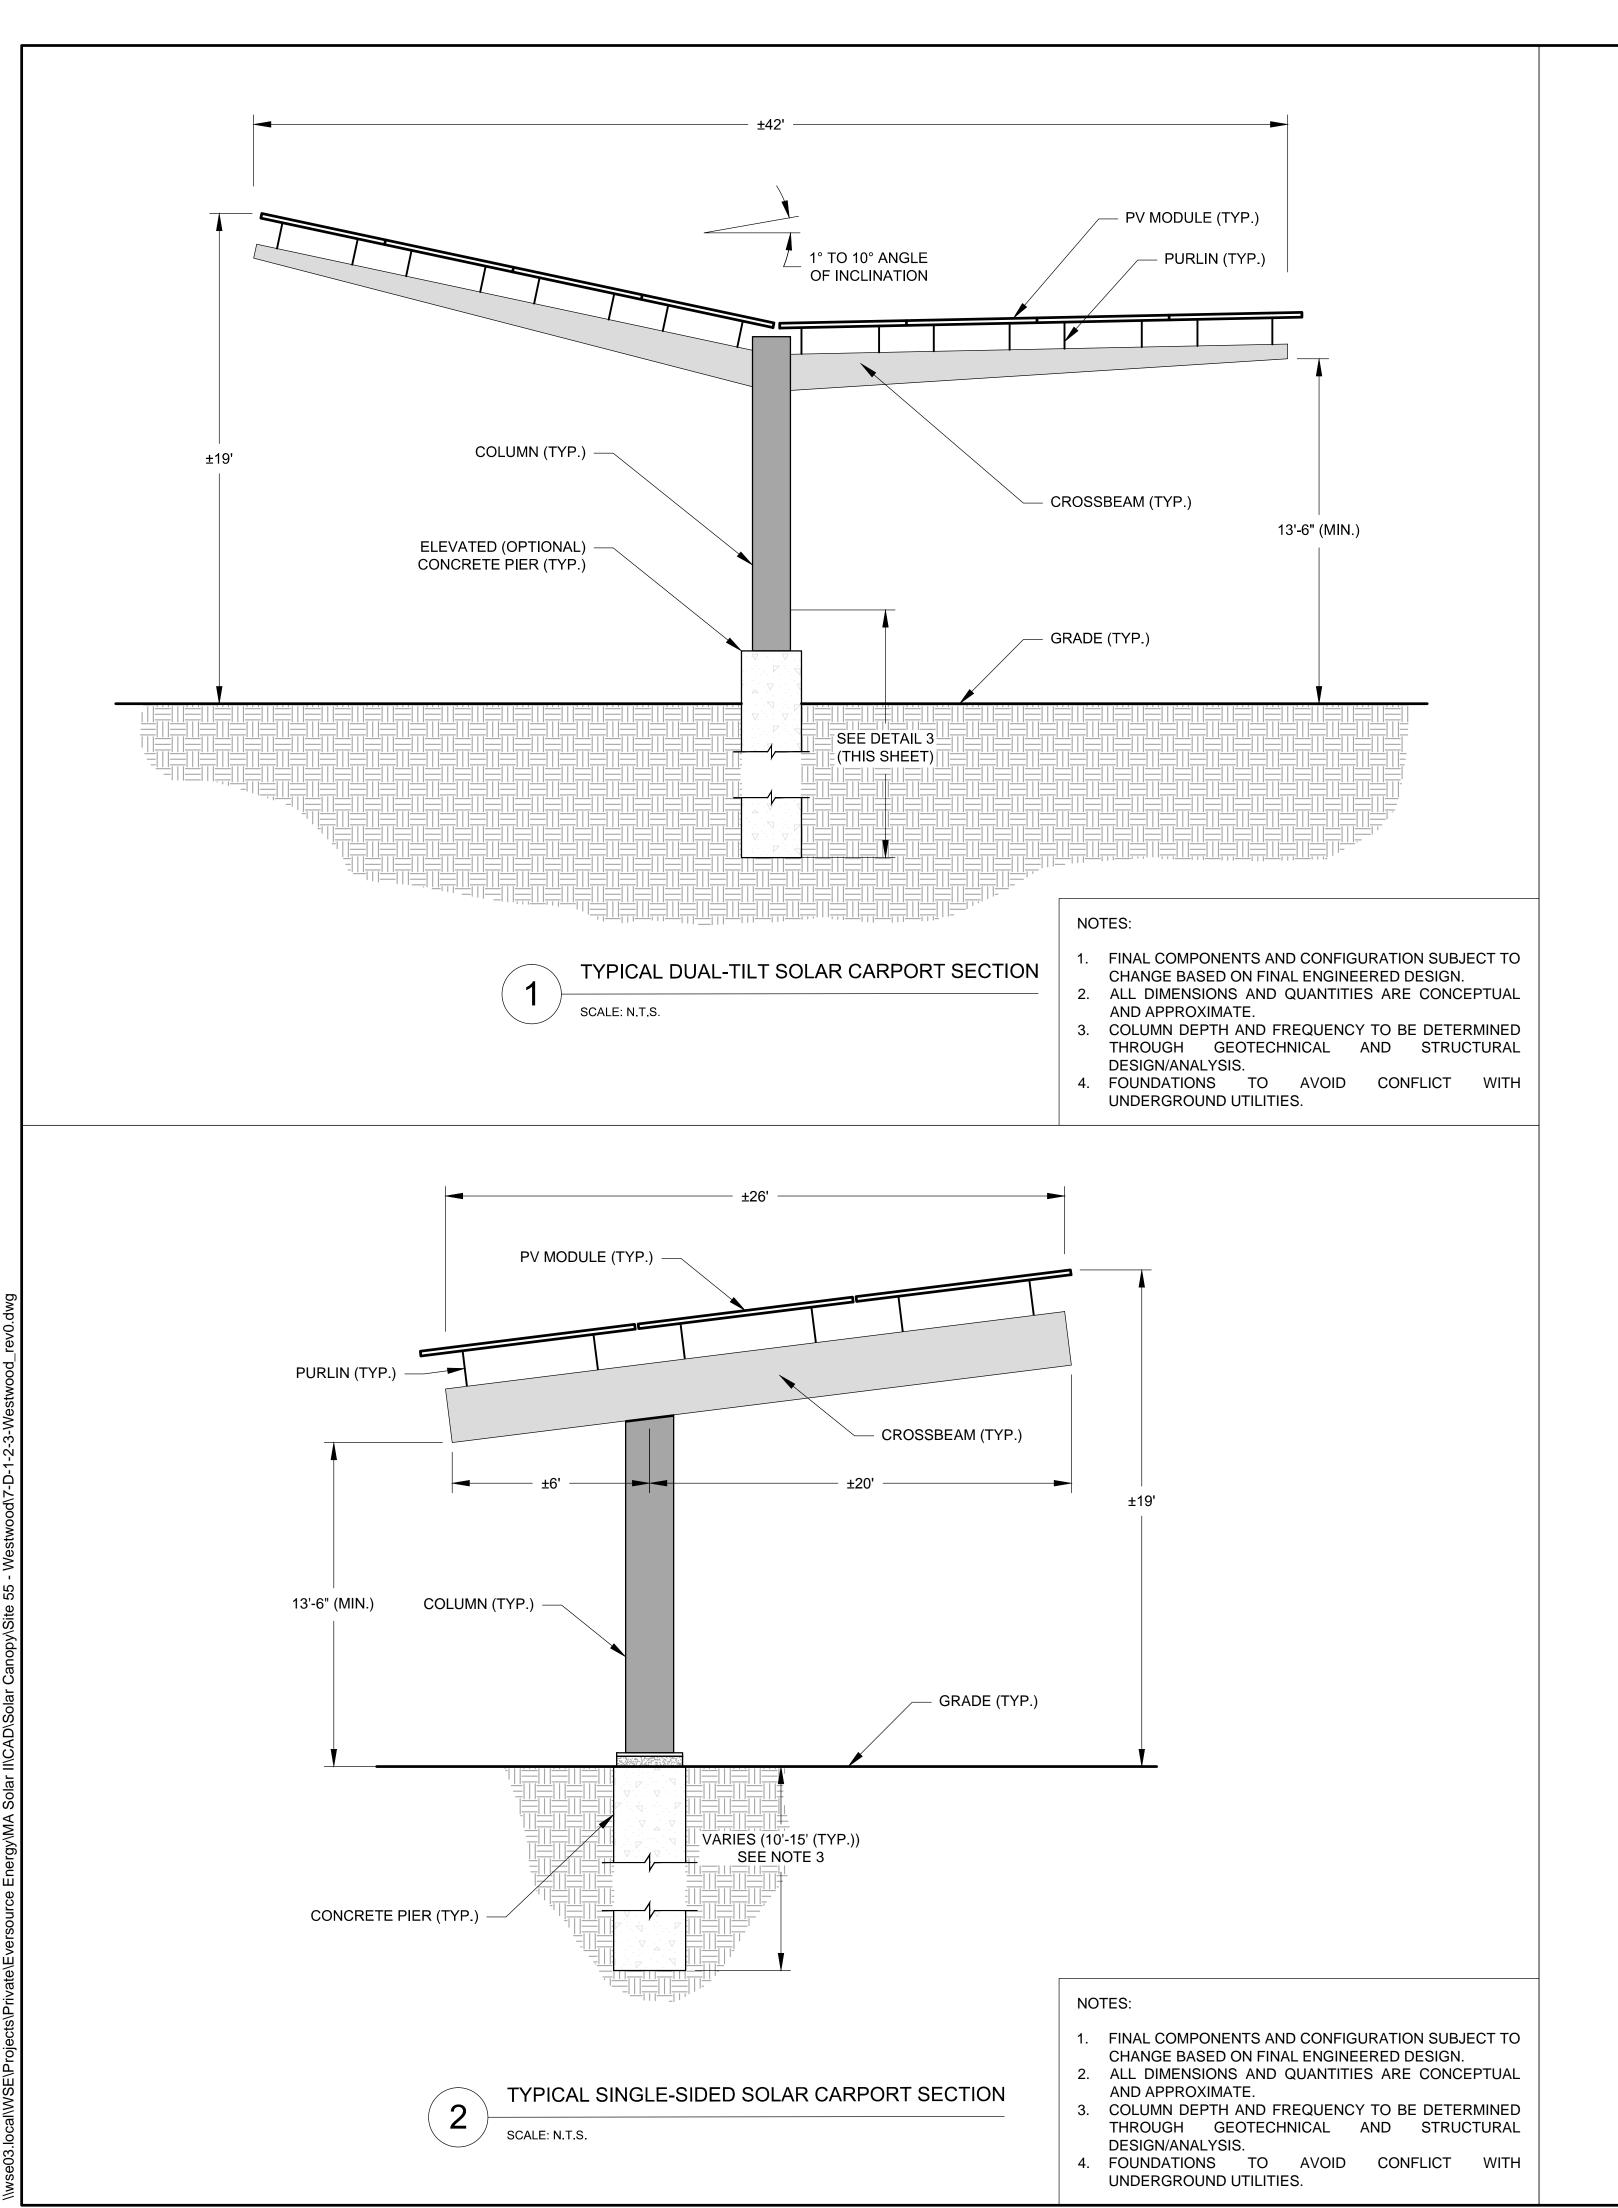
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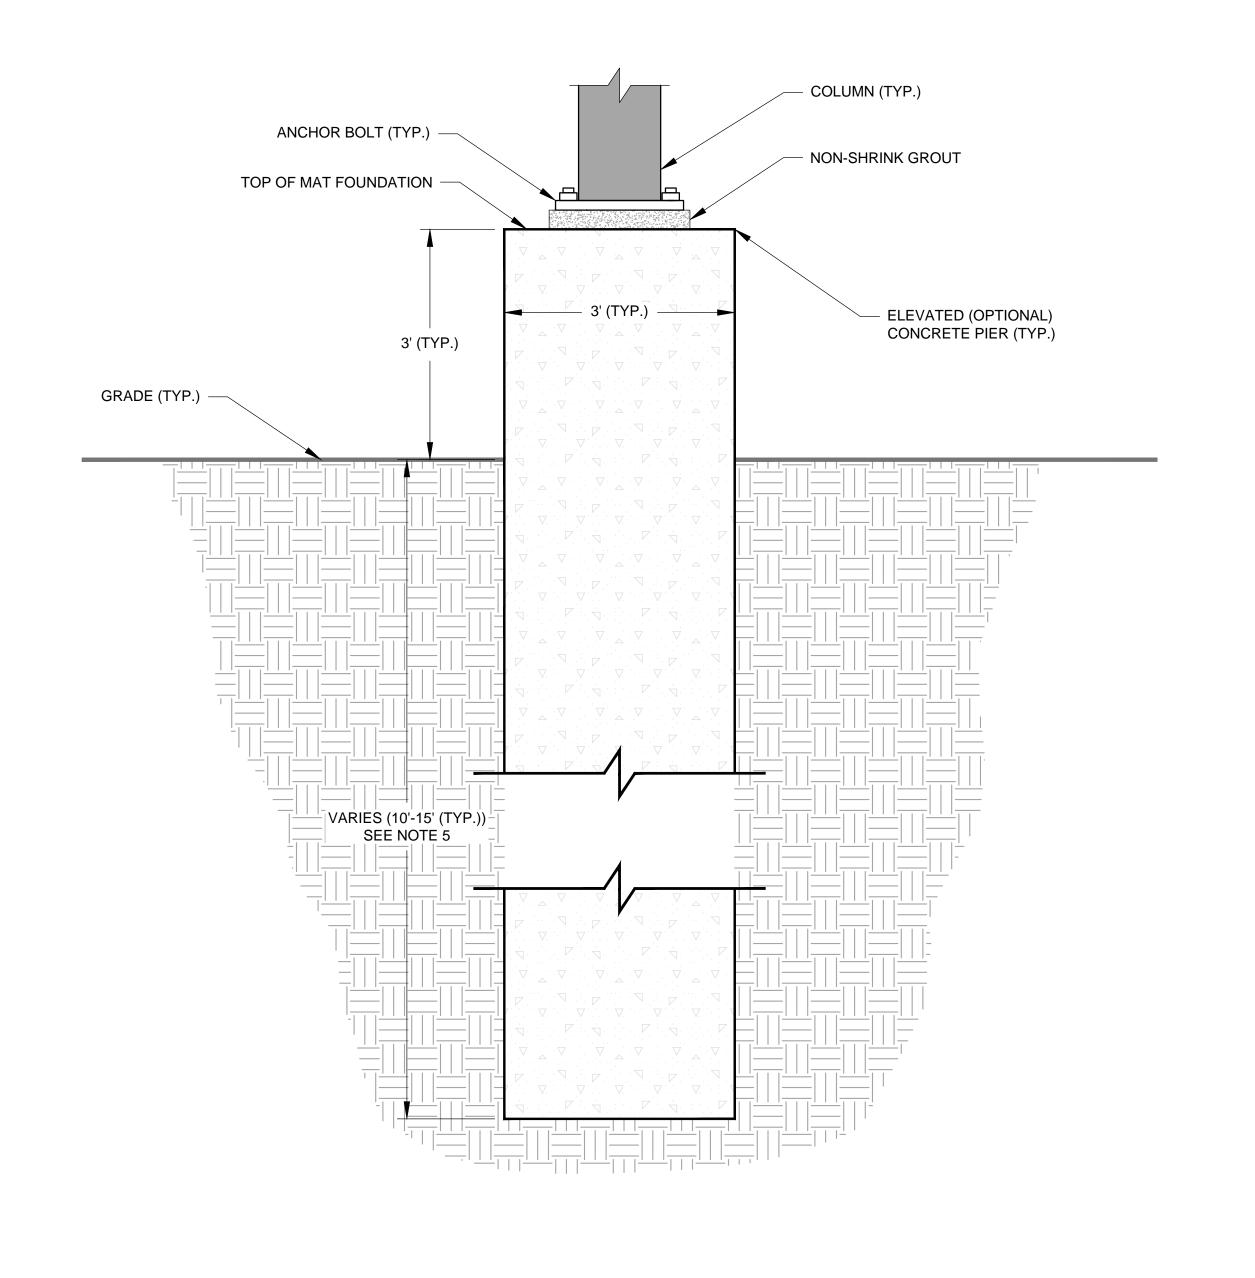
JOB NO. 2170318.B PERMIT SET

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PROPOSED SITE PLAN







TYPICAL FOOTING DETAIL

SCALE: N.T.S.

NOTES:

- FOUNDATION DESIGN TO BE DETERMINED THROUGH
 GEOTECHNICAL AND STRUCTURAL ANALYSIS.

 FOUNDATIONS
 ANALYSIS.

 ANALYSIS.

 ANALYSIS.

 ANALYSIS.

 ANALYSIS.

 ANALYSIS.
- 2. FOUNDATIONS TO AVOID CONFLICT WITH UNDERGROUND UTILITIES.
- FINAL COMPONENTS AND CONFIGURATION SUBJECT TO CHANGE BASED ON FINAL ENGINEERED DESIGN.
 ALL DIMENSIONS AND QUANTITIES ARE CONCEPTUAL
- AND APPROXIMATE.

 5. COLUMN DEPTH AND FREQUENCY TO BE DETERMINED THROUGH GEOTECHNICAL AND STRUCTURAL DESIGN/ANALYSIS.

EVERS URCE EVERSOURCE ENERGY

MASSACHUSETTS
PHOTOVOLTAIC
PROGRAM - ROUND II

P.O. BOX 5017

1 NSTAR WAY WESTWOOD, MA 02090

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Date: 08.15.17

Scale: AS SHOWN

Designed By: RWG

Reviewed By: RWG

Reviewed By: RWC

Checked By: SPW


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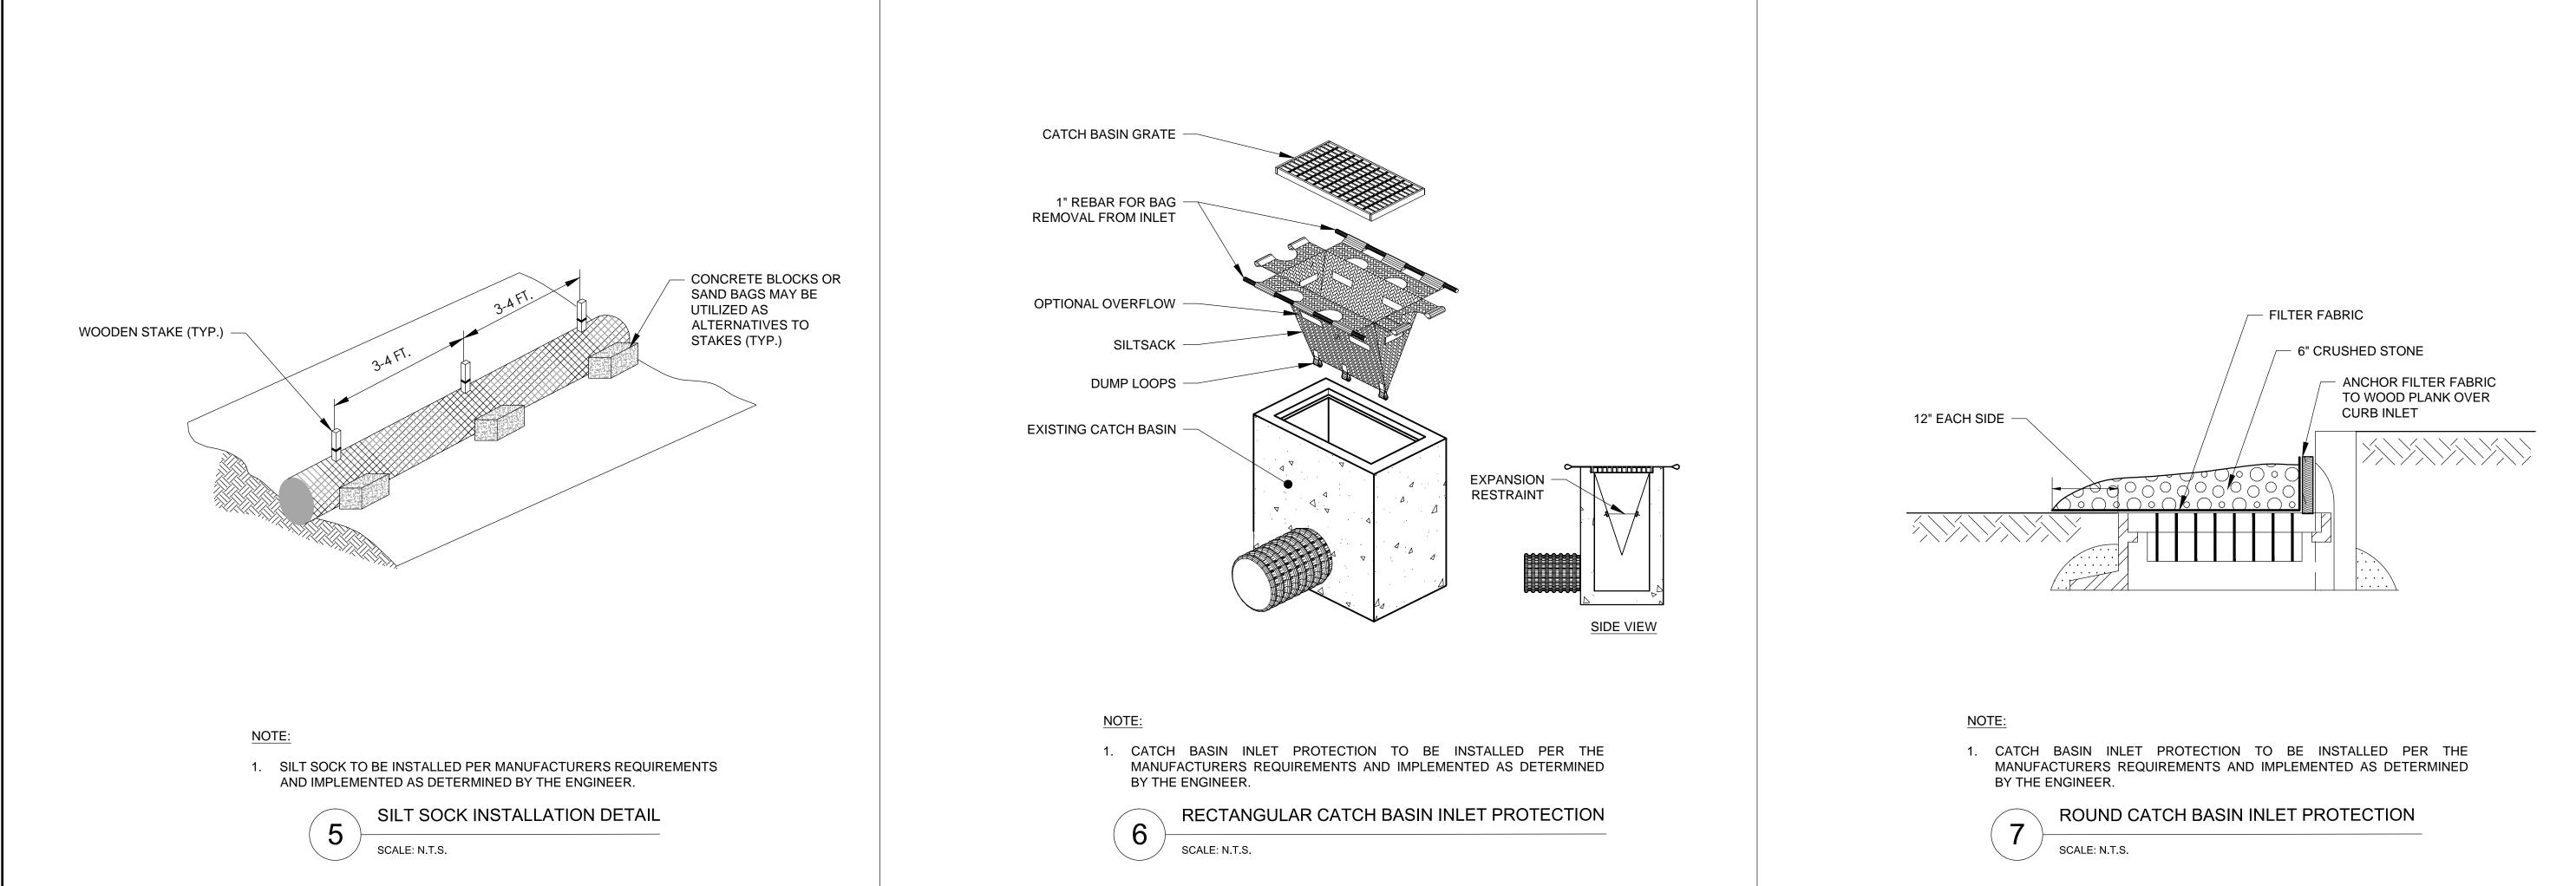
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DETAILS I

Sheet Number:

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Sheet Number:

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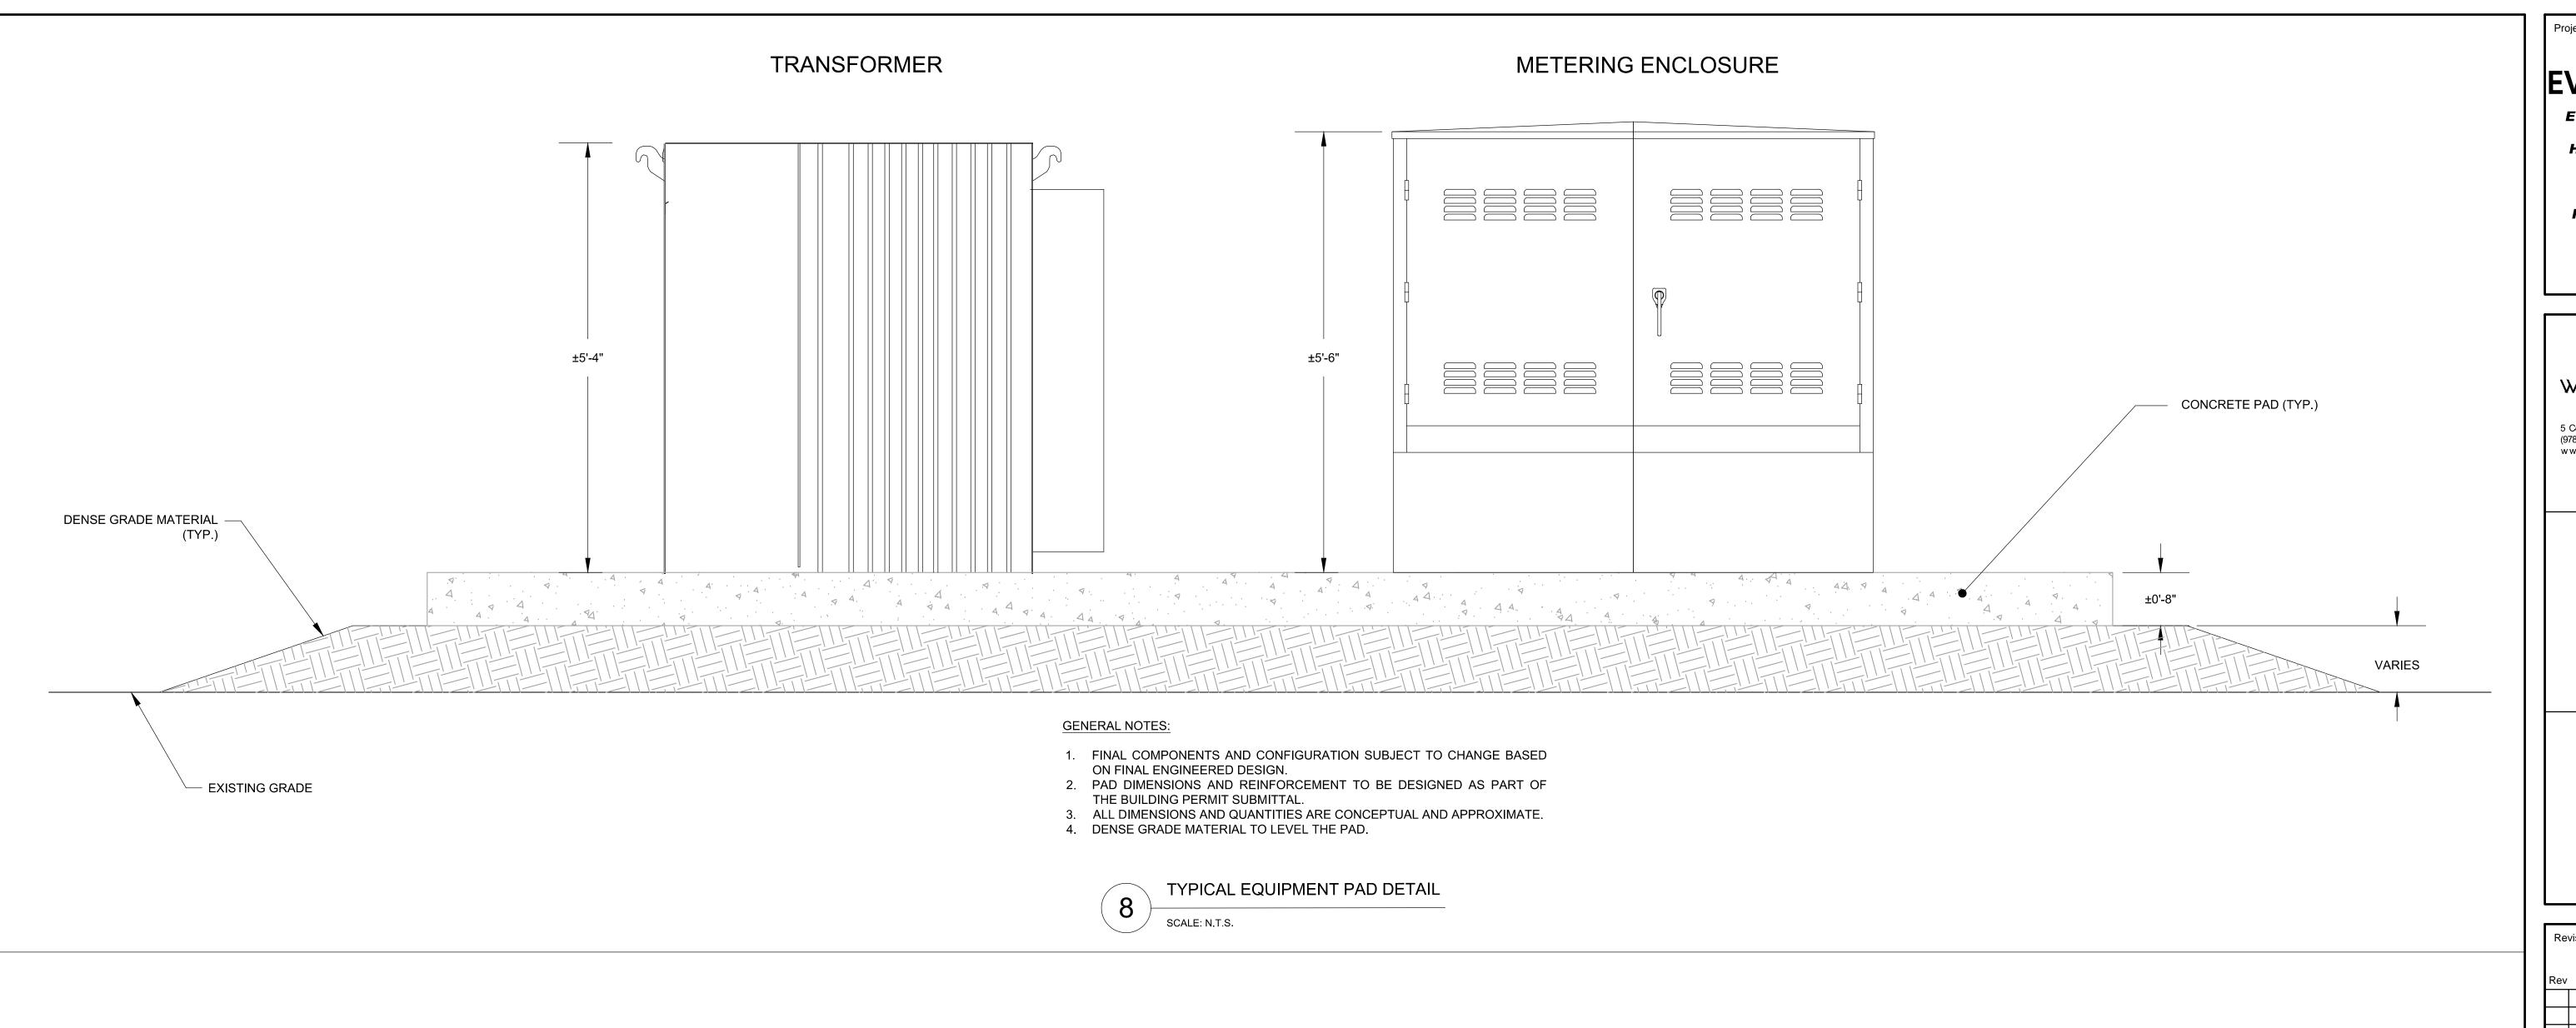
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Designed By: RWG

Reviewed By: RWG

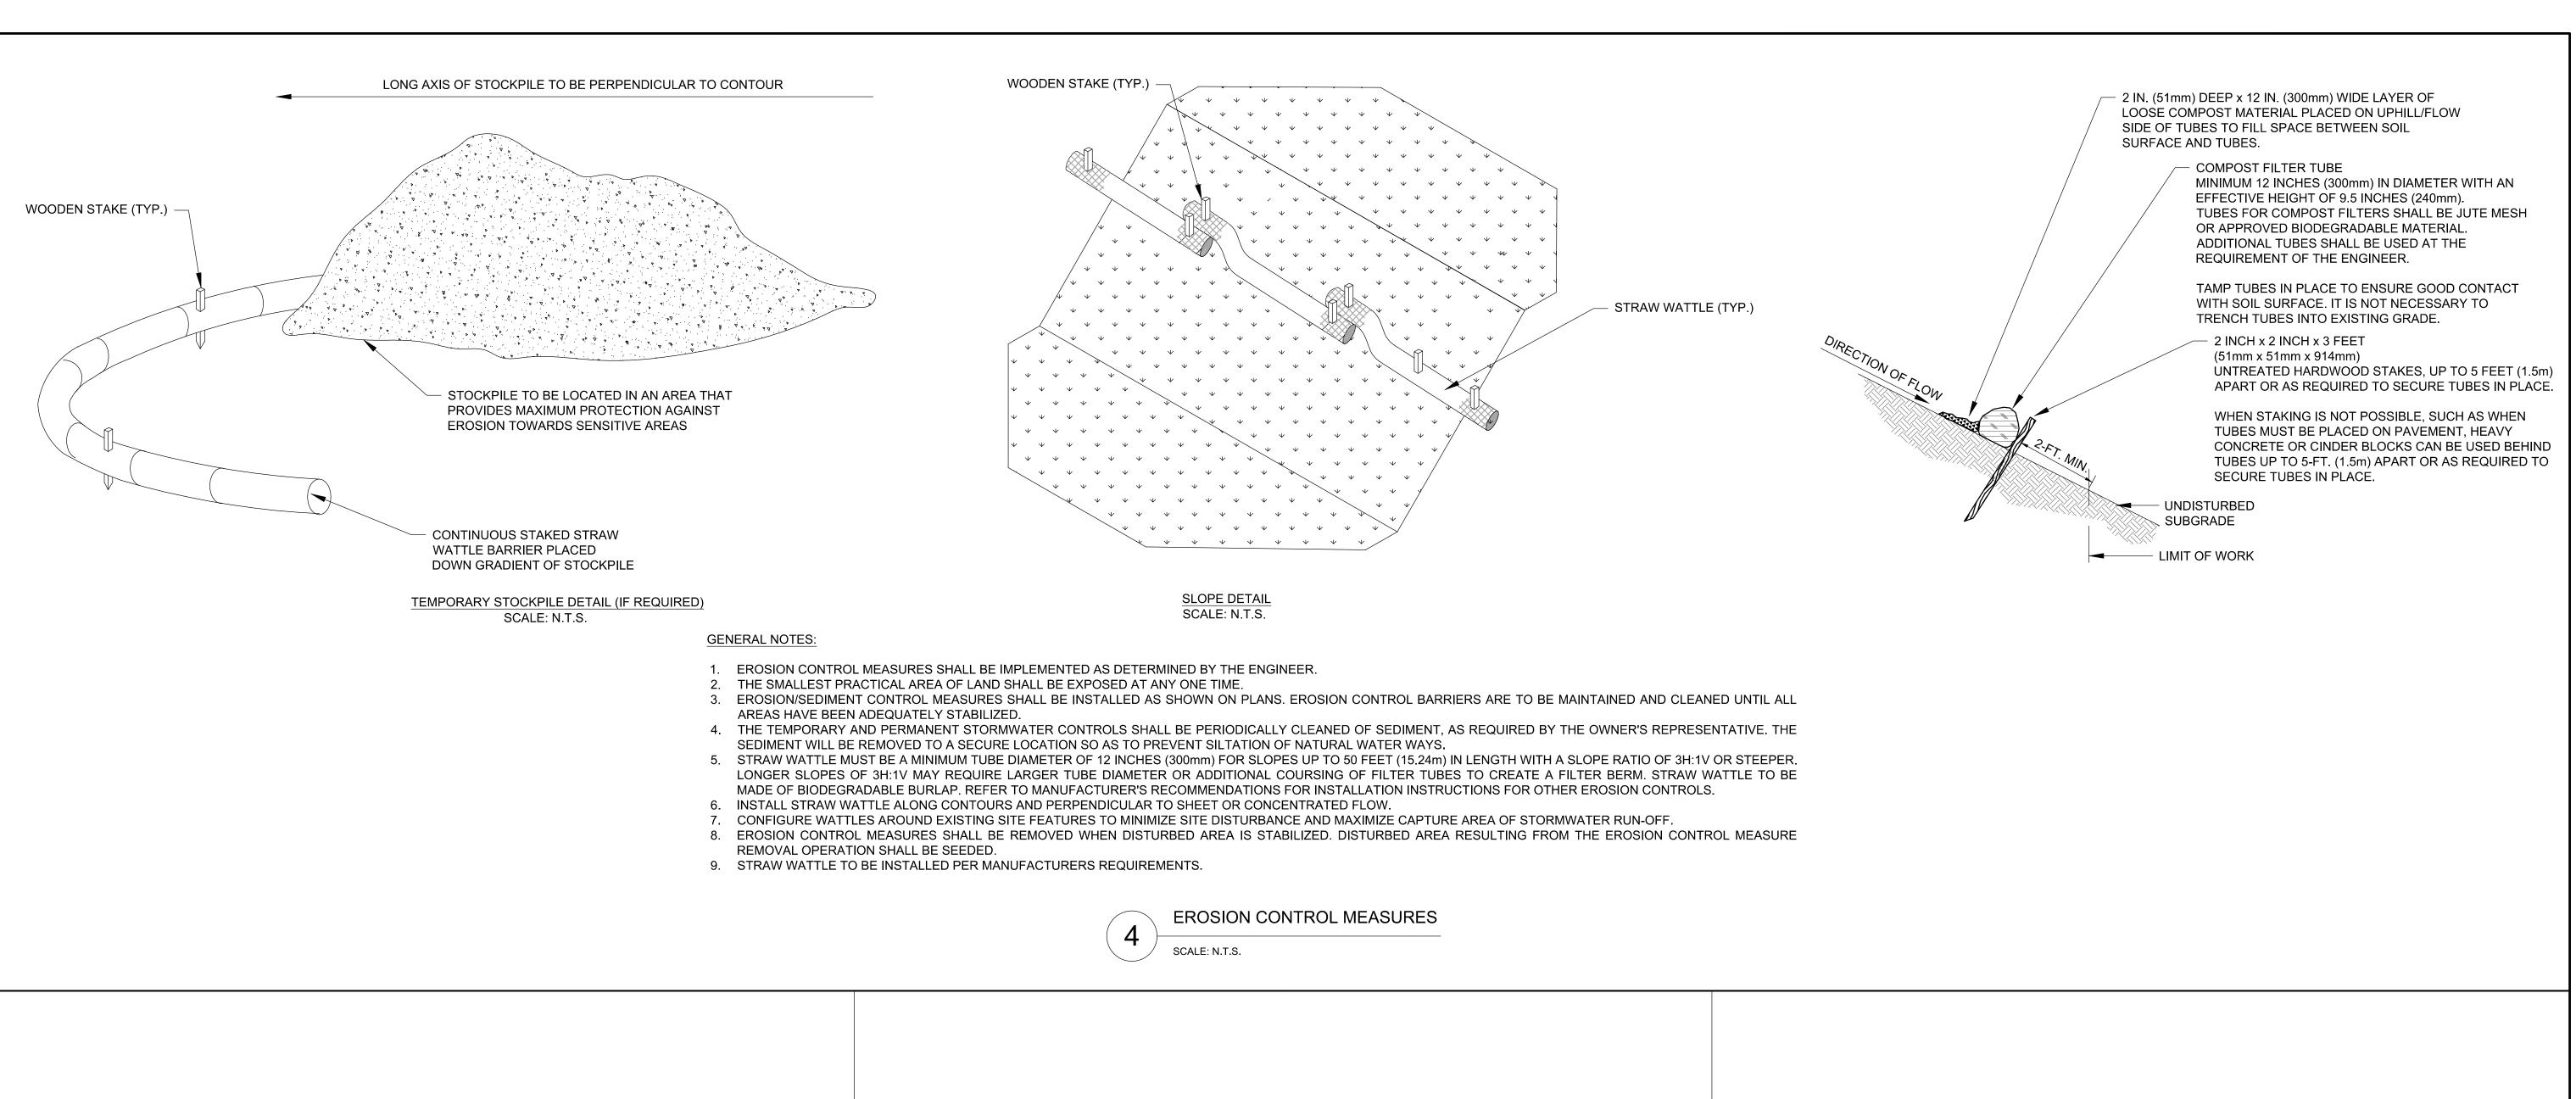Checked By: SP
Approved By: FM

Drawing Title:

DETAILS III

Sheet Number

D-