



WESTWOOD BOARD OF APPEALS
APPLICATION FOR HEARING

1. **Name of Applicant:** _____
2. **Applicant** is (check one): Owner ____ Tenant ____ Abutter ____ Purchaser ____ Other _____
3. **Mailing address of Applicant:** _____
4. **Telephone** - Home: _____ Business: _____
5. **E-Mail Address of Applicant:** _____
6. **Address of Property subject to Hearing:** _____
7. **Owner of Property:** _____
8. **Mailing Address of Property Owner:** _____
9. **Telephone** - Home: _____ Business: _____
10. **Deed** recorded in: Norfolk County Registry of Deeds: Book # _____ Page # _____
or Land Court Registry: Certificate # _____ Book # _____ Page # _____
11. **Property** MAP # _____ LOT # _____ DISTRICT _____
12. Has an appeal/application ever been filed with the ZBA on this property? (Y/N) ____ If yes, when: _____
13. **NATURE of Application** (check one):
_____ Appeal in accordance with MA G.L.Ch. 40A, Sec. 8 as amended
_____ Special Permit in accordance with MA G.L.Ch.40A, Sec. 9 as amended
_____ Variance in accordance with MA G.L. Ch. 40A, Sec. 10 as amended

When applying for a Special Permit under Section 9.3 of the Westwood Zoning Bylaw, please make sure that you and/or your attorney refer to the specific bylaw regarding this section.

STATE the EXACT NATURE of this application including the applicable section number(s) of the Westwood Zoning Bylaw:

I hereby request a hearing before the Westwood Board of Appeals with reference to the subject property.

I am aware that the cost of legal advertising will be billed to me directly as the Applicant, by the newspaper at a later date. I am also aware of the provisions in the Zoning Bylaw with regard to Reimbursement for Consultants, and I agree to reimburse the Board of Appeals and the Town of Westwood for all costs incurred by the Town or its' Boards for all fees, expenses and costs in connection with the review and evaluation of the Application for Special Permit and/or Variance.

I have reviewed the Zoning Board of Appeals Instructions and Information and understand the time requirements.

Signed: [Signature]
APPLICANT'S SIGNATURE (or Agent)

Date: 3/27/17

Signed: _____
PROPERTY OWNER (if different from applicant)

Date: _____

SCHEDULE OF FILING FEES FOR THE BOARD OF APPEALS	
Residential Properties	- \$165.00
Business Properties	- \$330.00
Comprehensive Permits	- \$2530.00

CHECKLIST:

- 6 copies of the Application
- 6 copies of the OPTIONAL Appendices (if completed)
- 6 copies of a Certified Plot Plan – size 11" x 17"
- 6 copies of the Building Plans (interior and/or exterior as applicable) – size 11" x 17"
- 6 copies of the Building Commissioner's denial of a building permit or equivalent

File the six (6) packets in the Town Clerk's office located at 580 High Street making sure to include a check for the filing fee in the correct amount.

Deliver one (1) electronic copy of the Application with attachments to the Office of the Board of Appeals at 50 Carby Street.

Plan on a minimum of three months to complete the process.

OPTIONAL

APPENDIX A – Variance Worksheet

The Variance must be with respect to particular land or structures.

- Parcel of Land: _____
- Structures: _____

There must be circumstances relating to soil conditions, shape, and topography of such land or structures and especially affecting such land or structures, but not affecting generally the zoning district in which it is located.

- Circumstances would be: Finish the existing attic will have less impact than building an addition

Literal enforcement of the provisions of the bylaw would involve substantial hardship, financial or otherwise, to the petitioner or appellant.

- Hardship would be: There would be significant more cost to build an addition than to utilize the existing large attic.

Desirable relief may be granted without detriment to the public good and without nullifying or substantially derogating from the intent or purpose of such bylaw.

- Relief would be: Allow the construction of the shed dormer. The highest point of the proposed dormer is approximately 10ft below the height of the existing roof.

- Detriment would be: _____

- Intent or purpose of Bylaw section? _____

- Would the Variance nullify intent or purpose above?

No. Due to the siting and wetlands, the dormer is essentially not visible from a public way or adjacent homes. In addition, the dormer is small and visually diminutive compared to the existing roof.

- Is there any substantial derogating (lessening) of the intent or purpose and if so, what is it? _____

Denied

DATE ISSUED: _____ FEE PAID: _____ NO.: _____

APPLICATION FOR PERMIT TO BUILD

To the Building Commissioner: _____ Date: _____

The undersigned hereby applies for a permit to Build - Alter - Remodel, etc., according to information indicated in this application and plans and specifications submitted herewith.

PLEASE PRINT CLEARLY

IMPORTANT - Applicant to complete all items in sections I, II, III, IV, AND V

I. LOCATION OF BUILDING

STREET ADDRESS	<u>10 Cardinal Drive</u>	R. SIDE YARD SETBACK	_____
	(NO.) (STREET)	L. SIDE YARD SETBACK	_____
ZONING DISTRICT	LOT FRONTAGE	REAR YARD SETBACK	_____
ASSESSORS MAP #	LOT#	LOT SIZE	FRONT YARD SETBACK _____

II. TYPE AND COST OF BUILDING - All applicants complete Parts A - D.

A. TYPE OF IMPROVEMENT 1 New Building <input checked="" type="checkbox"/> 2 Addition <input checked="" type="checkbox"/> 3 Alteration 4 Repair, replacement 5 Wrecking 6 Moving (relocation) 7 Foundation only 8 Pools, Fences, Towers Tennis Courts, etc.	D. PROPOSED USE - For "Wrecking" most recent use <table style="width: 100%;"> <tr> <td style="width: 50%;">RESIDENTIAL</td> <td style="width: 50%;">NONRESIDENTIAL</td> </tr> <tr> <td><input checked="" type="checkbox"/> 13 One Family</td> <td>19 Amusement, recreational</td> </tr> <tr> <td>14 Two or more family - Enter number of units</td> <td>20 Church, other religious</td> </tr> <tr> <td>15 Transient hotel, motel, or dormitory - Enter number of units</td> <td>21 Industrial</td> </tr> <tr> <td>16 Garage</td> <td>22 Parking garage</td> </tr> <tr> <td>17 Carport</td> <td>23 Service station, repair garage</td> </tr> <tr> <td>18 Other - Specify _____</td> <td>24 Hospital, Institutional</td> </tr> <tr> <td>_____</td> <td>25 Office, bank, professional</td> </tr> <tr> <td>_____</td> <td>26 Public Utility</td> </tr> <tr> <td>_____</td> <td>27 School, library, other educational</td> </tr> <tr> <td></td> <td>28 Stores, mercantile</td> </tr> <tr> <td></td> <td>29 Tanks, towers</td> </tr> <tr> <td></td> <td>30 Other - Specify _____</td> </tr> </table>	RESIDENTIAL	NONRESIDENTIAL	<input checked="" type="checkbox"/> 13 One Family	19 Amusement, recreational	14 Two or more family - Enter number of units	20 Church, other religious	15 Transient hotel, motel, or dormitory - Enter number of units	21 Industrial	16 Garage	22 Parking garage	17 Carport	23 Service station, repair garage	18 Other - Specify _____	24 Hospital, Institutional	_____	25 Office, bank, professional	_____	26 Public Utility	_____	27 School, library, other educational		28 Stores, mercantile		29 Tanks, towers		30 Other - Specify _____
RESIDENTIAL	NONRESIDENTIAL																										
<input checked="" type="checkbox"/> 13 One Family	19 Amusement, recreational																										
14 Two or more family - Enter number of units	20 Church, other religious																										
15 Transient hotel, motel, or dormitory - Enter number of units	21 Industrial																										
16 Garage	22 Parking garage																										
17 Carport	23 Service station, repair garage																										
18 Other - Specify _____	24 Hospital, Institutional																										
_____	25 Office, bank, professional																										
_____	26 Public Utility																										
_____	27 School, library, other educational																										
	28 Stores, mercantile																										
	29 Tanks, towers																										
	30 Other - Specify _____																										
B. OWNERSHIP <input checked="" type="checkbox"/> 9 Private (Individual, Corporation, nonprofit Institution, ect.) 10 Public (Federal, State or Local Government)	<div style="text-align: right; color: red; font-weight: bold;"> RECEIVED FEB 28 2017 TOWN OF WESTWOOD COMMISSIONER OF BUILDING </div>																										

C. COST 11 Cost of Basic Construction To be installed but not included in the above cost a. Electrical b. Plumbing c. Heating, air conditioning d. Other (elevator, etc.) 12 TOTAL COST OF IMPROVEMENT	(Omit cents) \$ <u>185,000</u> \$ <u>10,000</u> <u>10,000</u> <u>15,000</u> \$ <u>220,000</u>	E. TYPE OF OCCUPANCY OR USE; NEW HOME, ETC. Briefly outline scope and nature of work to be done. <u>Add 2 bedrooms & bath to attic per plans</u>
--	--	---

III. SELECTED CHARACTERISTICS OF BUILDING For new buildings and additions, complete Parts E-L; for wrecking, complete only Part J, for all others skip to IV.

F. PRINCIPAL TYPE OF FRAME 31 Masonry 32 Wood frame 33 Structural steel 34 Reinforced concrete 35 Other - Specify _____	H. TYPE OF SEWAGE DISPOSAL <input checked="" type="checkbox"/> 41 Public Sewer 42 Private (septic tank, etc.) I. TYPE OF WATER SUPPLY <input checked="" type="checkbox"/> 43 Public or Private Company 44 Private (well)	K. DIMENSIONS 49 Number of stories _____ 50 Total sq.ft. of floor area, all floors, based on exterior dimensions _____ 51 Total land area, sq.ft. _____ L. NUMBER OF OFF - STREET PARKING SPACES 52 Enclosed _____ 53 Outdoors _____
G. PRINCIPAL TYPE OF HEATING FUEL 36 Gas 38 Electricity 40 Other - Specify _____ 37 Oil 39 Coal	J. TYPE OF MECHANICAL Will there be air conditioning? 45 Yes 46 No Will there be an elevator? 47 Yes 48 No	M. RESIDENTIAL BUILDINGS ONLY 54 No. of bedrooms _____ 55 No. of baths: Full Partial

IV. TO BE COMPLETED BY ALL APPLICANTS

USE N/A IF NOT APPLICABLE

1. Will building be erected on solid or filled land If filled land how long ago filled _____
2. Will foundation be laid on earth, rock, timber, piles _____
3. Foundation material concrete
4. Roof (flat, pitched) 12
5. Roof covering asphalt shingles
6. Will all construction to be performed conform to State and Local Building Codes Yes
7. Has the applicant complied with the Architectural Access Code Yes
8. Does this Building or Structure conform to the Zoning Bylaw Yes
9. Has the applicant complied with the Energy Code Yes
10. Is this property in the FLOOD PLAIN AREA no

THIS IS A TRUE STATEMENT SIGNED UNDER PENALTIES OF PERJURY

V. IDENTIFICATION - To be completed by all applicants - Complete street and mailing addresses

NAME		COMPLETE ADDRESS	HOME & BUS. PHONE
Owner or Lessee	<u>Steven Werth</u>	<u>10 Cardinal Dr</u>	<u>781 492 0813</u>
Builder/ Contractor	<u>Progress Contracting</u>	<u>5 Julie Dawn Dr Franklin MA</u>	<u>617 594 9392</u>
Architect/ Engineer	<u>Gienapp Design</u>	<u>20 Conant St Danvers MA</u>	<u>978 750 9062</u>

I hereby certify that the proposed work is authorized by the owner of record and that I have been authorized by the owner to make this application as his authorized agent.

Signature of Applicant <u>[Signature]</u>	Address <u>5 Julie Dawn Dr</u>	Application Date <u>2/28/17</u>
--	-----------------------------------	------------------------------------

This permit is approved subject to the provisions of all Federal and State Laws, Rules & Regulations and Con. Com. approval.

Sewer Permit No.
Sanitary Permit No. (Title V)
Highway Dept. Permit
Fire Dept. Permit
Water District Permit
CONTRACTOR LICENSING INFORMATION
Construction Supervisor License No. <u>082703</u>
Date of Expiration <u>9/17/18</u>
Home Improvement Contractor No. <u>138181</u>
Date of Expiration <u>3/3/19</u>

COMMENTS - DEPARTMENT USE ONLY

REAR DORMER

BUILDING COMMISSIONER'S DENIAL
REQUIRES VARIANCE
UNDER SECTION 5.4.4.1
EXCEEDS MAX HEIGHT

I have reviewed the applicant's request for a Building Permit and determined that it be forwarded to the Zoning Board of Appeals

[Signature]
 BUILDING COMMISSIONER

A. I hereby certify under penalty of perjury that I carry Workers' Compensation Insurance Coverage.

Signature: _____


Name of Insurance Company: _____

Policy Number: _____ Expiration Date: _____

B. I do not carry Workers' Compensation Coverage as I am an unincorporated sole proprietorship with no employees, using other self-employed sub-contractors for all work.

Signature _____

PLAN BOOK 429, PLAN 203

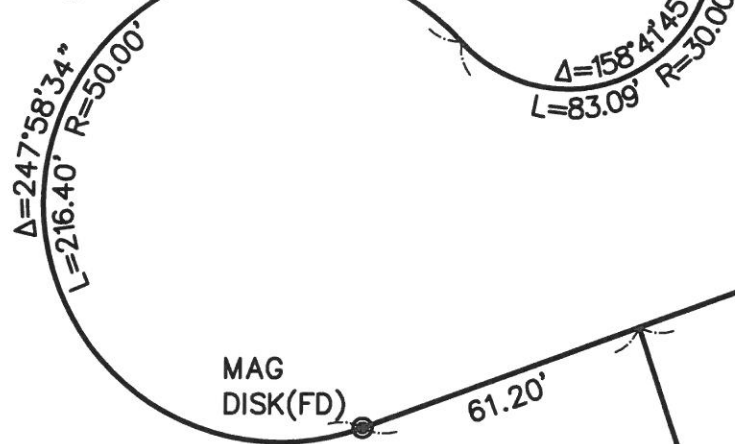

WHIPPOORWILL DRIVE
(VARIABLE WIDTH)

MAG DISK(FD)
I. ROD(FD) (BENT)
Δ=89°15'49" R=30.00'
L=46.74'

CARDINAL DRIVE
(50' WIDE)


N20°05'09"W
50.00'
(TIE LINE)

JAMES H. & SUZANNE NOLAN
VINSON
DEED BOOK 32314, PAGE 269
PLAN BOOK 429, PLAN 203

PETER J. & SUSAN
CWEKA
DEED BOOK 12403, PAGE 51
PLAN BOOK 429, PLAN 203
L.C. PLAN #14334Z

B. KAHN HUMAYON
DEED BOOK 23365, PAGE 9
PLAN BOOK 429, PLAN 203

LOT 26
AREA=25,000±S.F.

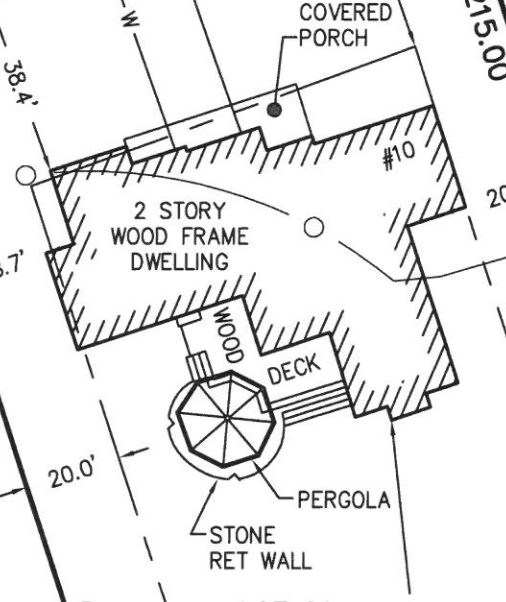


DRAIN EASEMENT
(PLAN BOOK 429, PLAN 203)

ASSESSORS:
MAP 11, LOT 16
ZONING:
SINGLE RESIDENCE E

REFERENCES:
DEED BOOK 33528, PAGE 538
PLAN BOOK 429, PLAN 203

- NOTES:**
- 1) THIS PLAN IS NOT TO BE CONSIDERED AN ALTA/NSPS LAND TITLE SURVEY.
 - 2) BUILDING OFFSETS SHOWN HEREON ARE TO CORNER BOARD.
 - 3) WATER AND SEWER SERVICE SHOWN HEREON WERE PROVIDED BY THE TOWN OF WESTWOOD AND THE DEDHAM-WESTWOOD WATER DISTRICT AND ARE APPROXIMATE ONLY.
 - 4) WETLAND SHOWN HEREON WAS COMPILED FROM A PLAN PROVIDED BY THE TOWN OF WESTWOOD ENTITLED "CONSERVATION AS-BUILT PLAN 10 CARDINAL DRIVE WESTWOOD, MA" BY UNITED CONSULTANTS, INC. DATED JAN. 5, 2007.

I CERTIFY THAT THE DWELLING SHOWN
HEREON IS LOCATED ON THE GROUND AS
SHOWN.

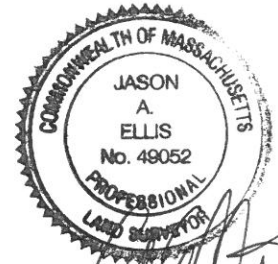

Jason A. Ellis
3/28/17
PROFESSIONAL LAND SURVEYOR

PLOT PLAN
OF LAND IN
WESTWOOD, MA
PREPARED FOR: GIENAPP DESIGN ASSOCIATES, LLC
HANCOCK
Survey Associates, Inc.
185 CENTRE STREET, DANVERS, MA. 01923
VOICE (978) 777-3050, FAX (978) 774-7816

SCALE: 1" = 40'
0 20 40 80

F:\Civil 3D Projects\20468 - Giennapp - Westwood\DWG\ 20468cpp.dwg Mar 28, 2017 - 4:16 pm

CHK. BY:
JMS
DATE:
3/28/17
JOB NO.
20468

Project Summary

This project is a renovation of an existing residence in Westwood, MA consisting of adding finish space on the Attic floor level into two bedrooms with closets, a sitting area, and a bathroom. This includes mechanical, plumbing, electrical, and structural work.


BIDDING INFORMATION

This is an invitation to provide a quote for the Renovation of the Attic for the Werth Residence located at 10 Cardinal Drive, Westwood, MA.


Proposals are due to Gienapp Design by **Tuesday, January 31, 2017 at 2:00pm**. Proposals may be submitted by fax to 978-750-9063 or by email to jbrauer@gienappdesign.com. (If additional time is needed, please contact Jackie Brauer at 978-750-9062 x.115 or at jbrauer@gienappdesign.com.) For technical questions, please contact Dale Gienapp at 978-750-9062 x.112 or at dgienapp@gienappdesign.com.

To schedule a visit the site, please contact Jackie Brauer to set up a meeting with the Owner. A pre-bid walkthrough is scheduled for 10am on Tuesday, January 17, 2017.

AERIAL PLAN

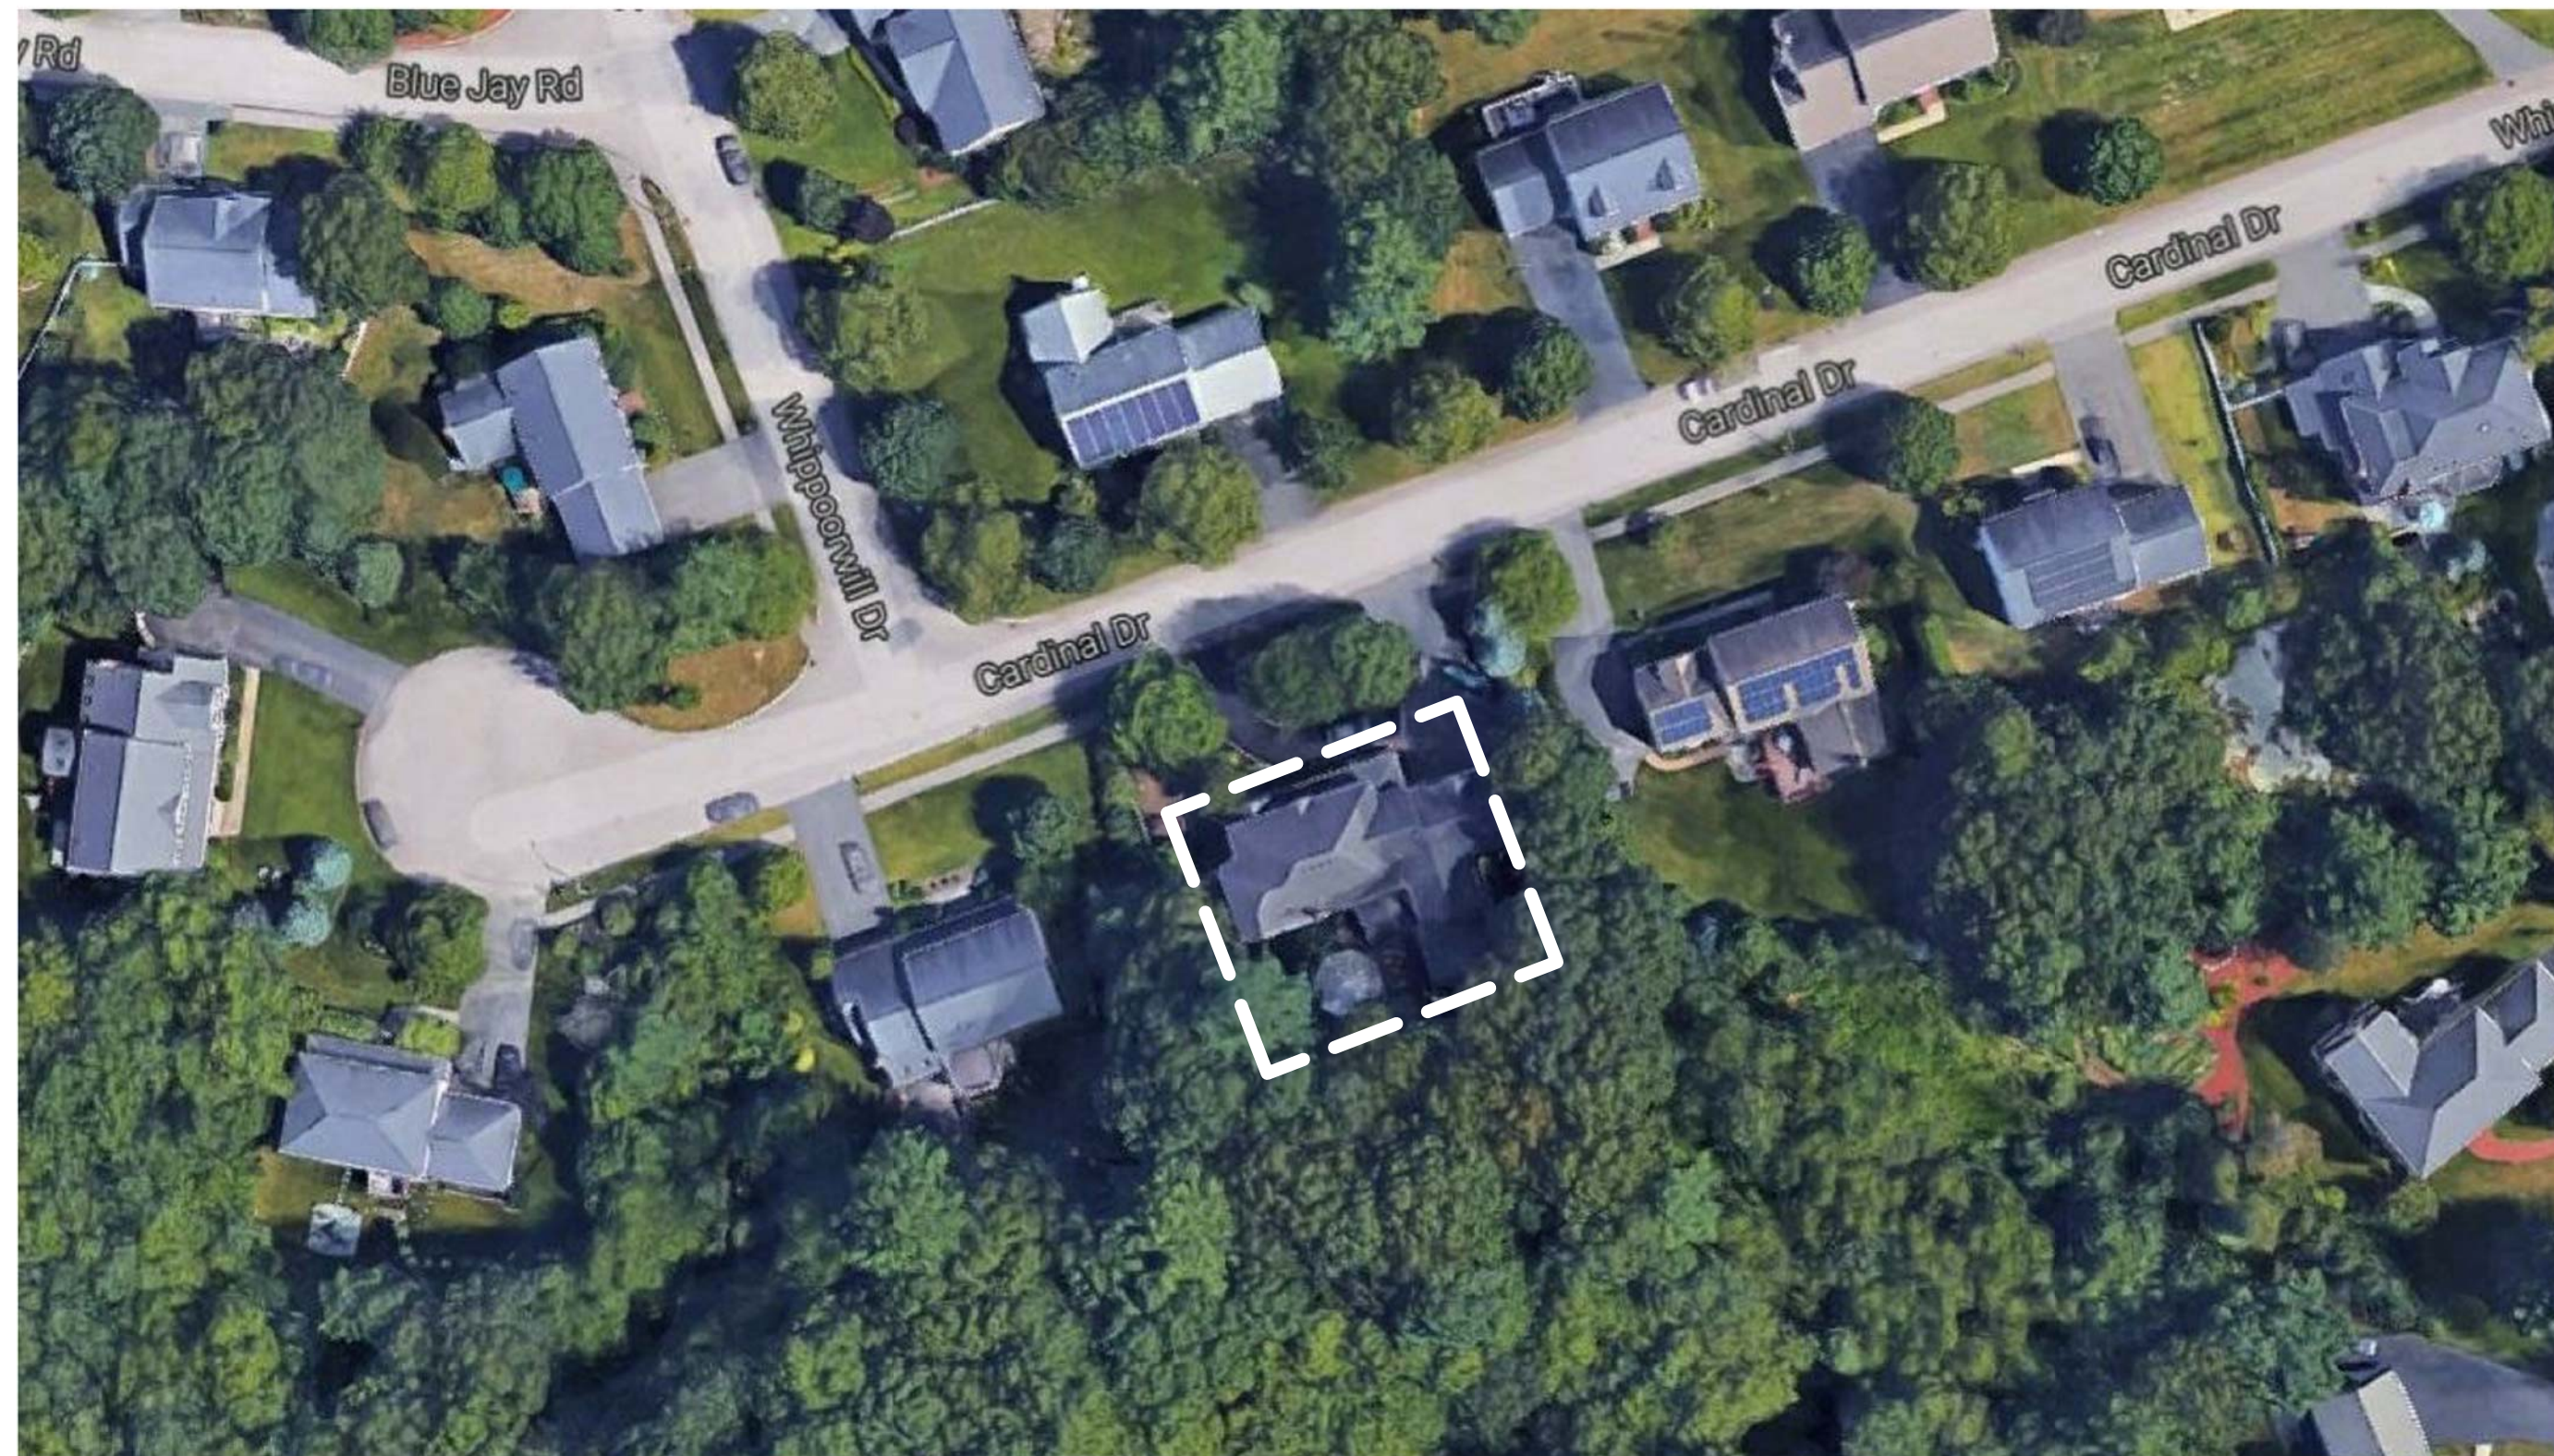

LOCUS PLAN

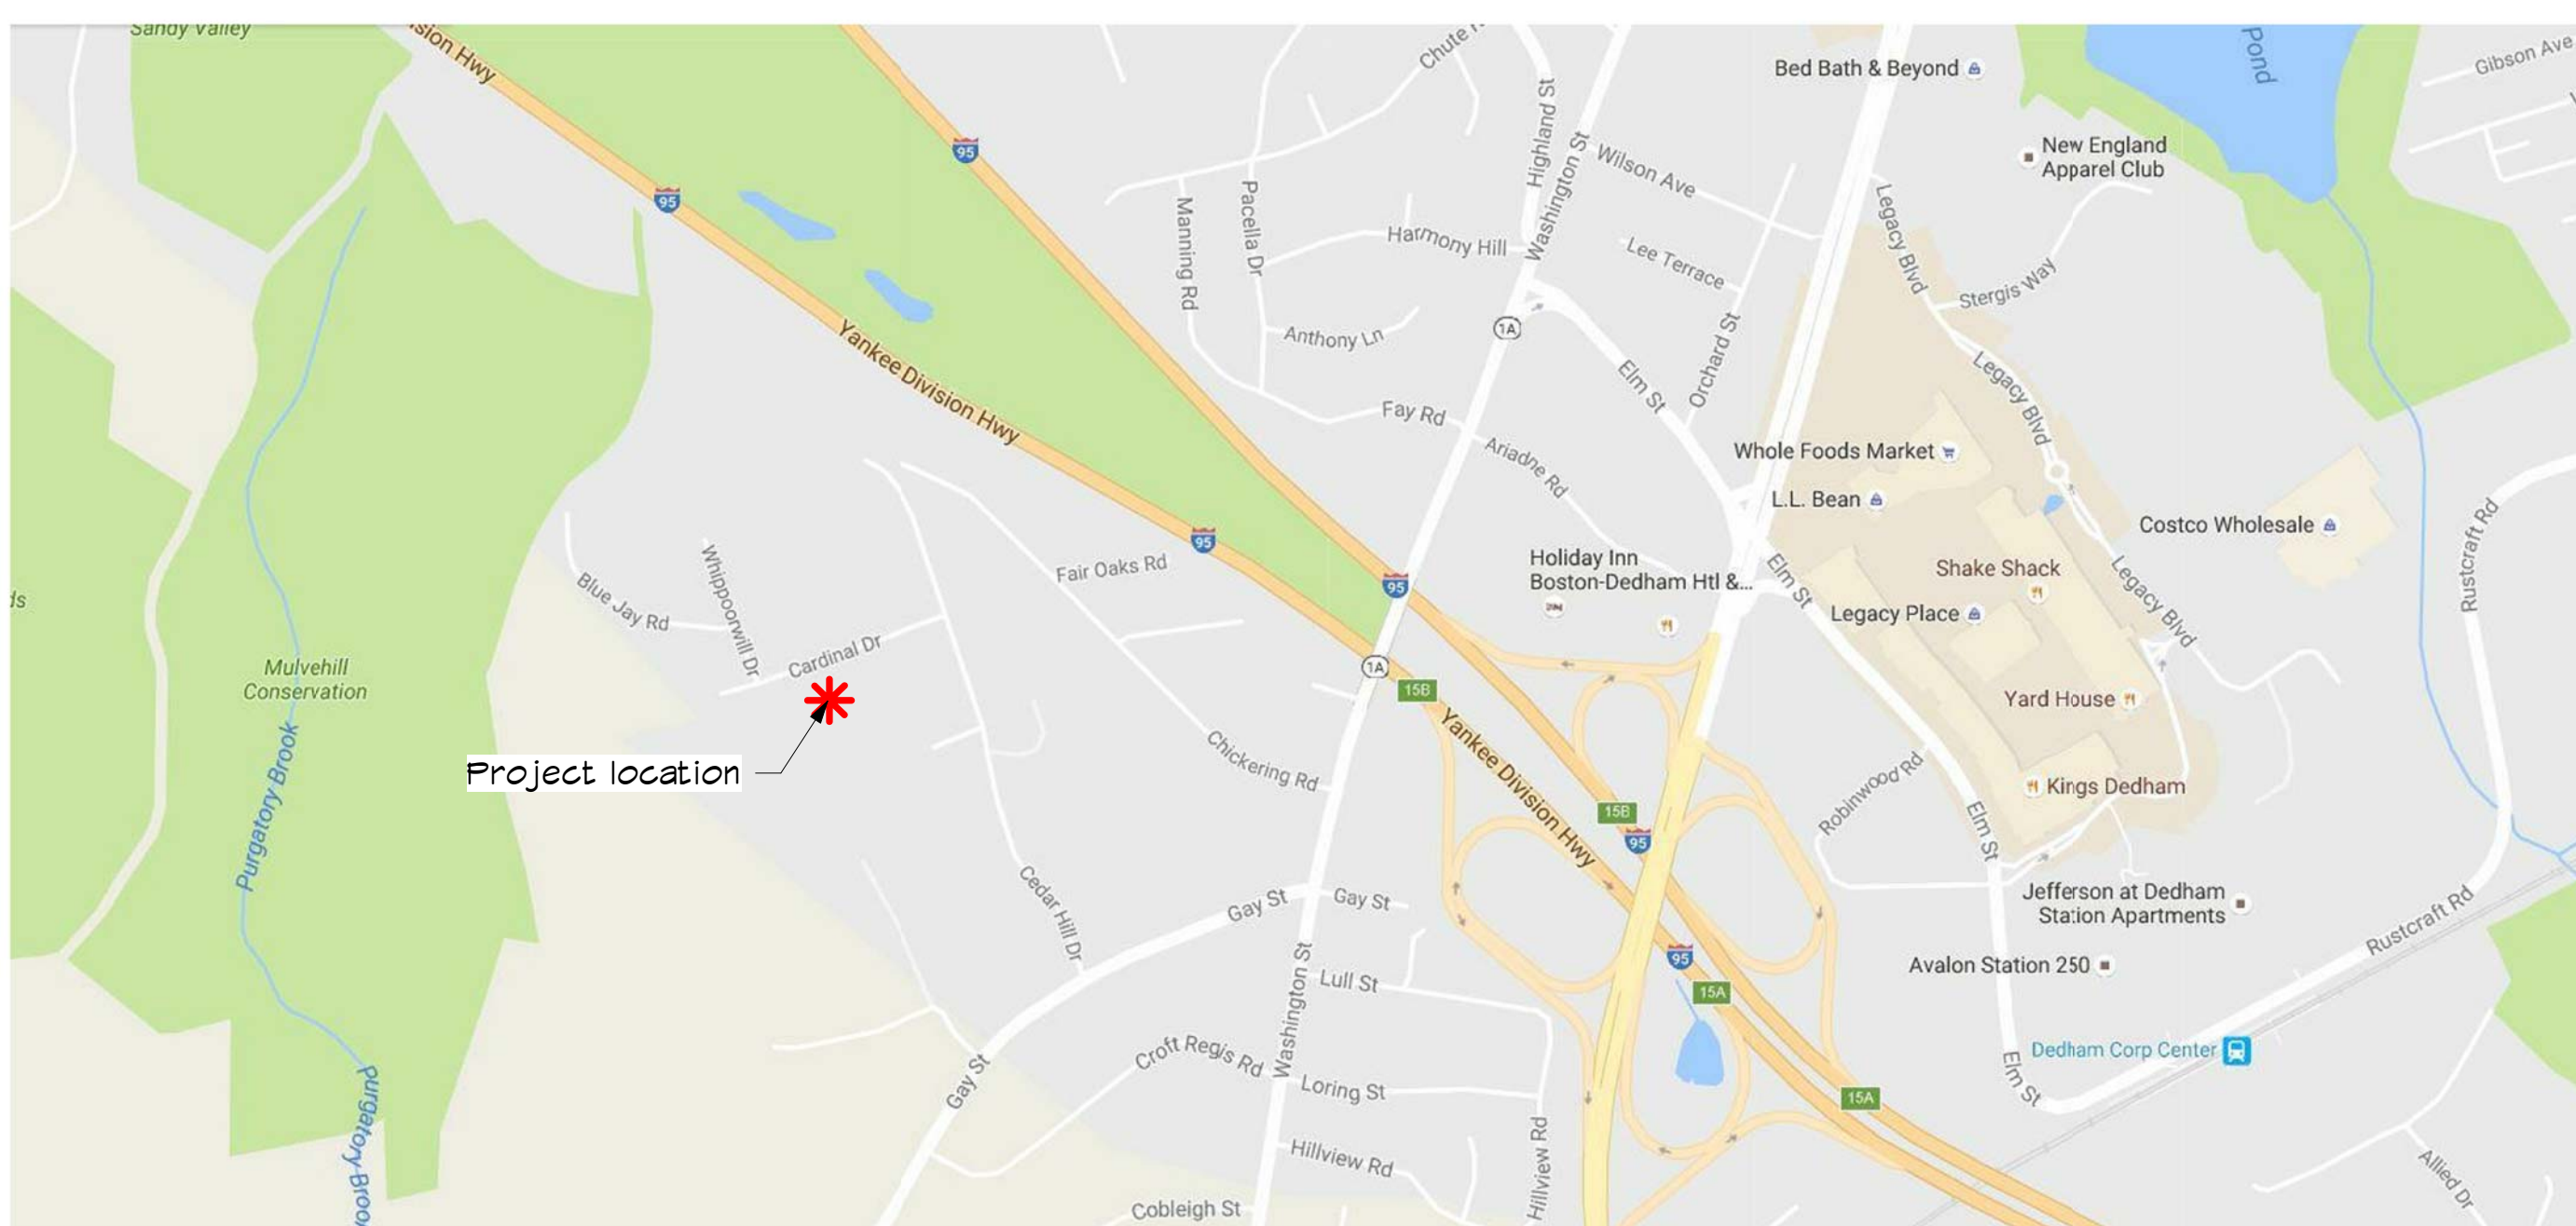

Werth Residence

10 Cardinal Drive, Westwood, MA

01/13/17 BID SET

DRAWING LIST

Project Information

- T-1 Title Sheet
- T-2 Specifications

Demolition

- Ex-1 Existing Floor Plans
- Ex-2 Roof Demolition

Architecture

- A-1 Proposed Attic Floor Plan
- A-3 Attic Bedroom Detail Floor Plan
- A-4 Toilet Room Details
- A-5 Building Section
- A-6 Stair Sections
- A-7 Partition Schedule and Finish Plan
- A-8 Window and Door Schedules
- A-9 Proposed Mechanical Above Attic Space

Structural


- S-1.0 Structural Notes
- S-2.0 Second Floor Framing Plan
- S-3.0 Attic Framing Plan
- S-4.0 Roof Framing Plan
- S-5.0 Roof Framing Plan

Mechanical

- M1.1 2nd Floor & Attic Mechanical Demo Plans
- M1.2 Basement & 1st Floor New Work Mechanical Plans
- M1.3 2nd, 3rd & Attic New Work Mechanical Plans

Electrical

- E-1 Electrical Legend, Notes and Plans
- E-2 Electrical Parts Plan

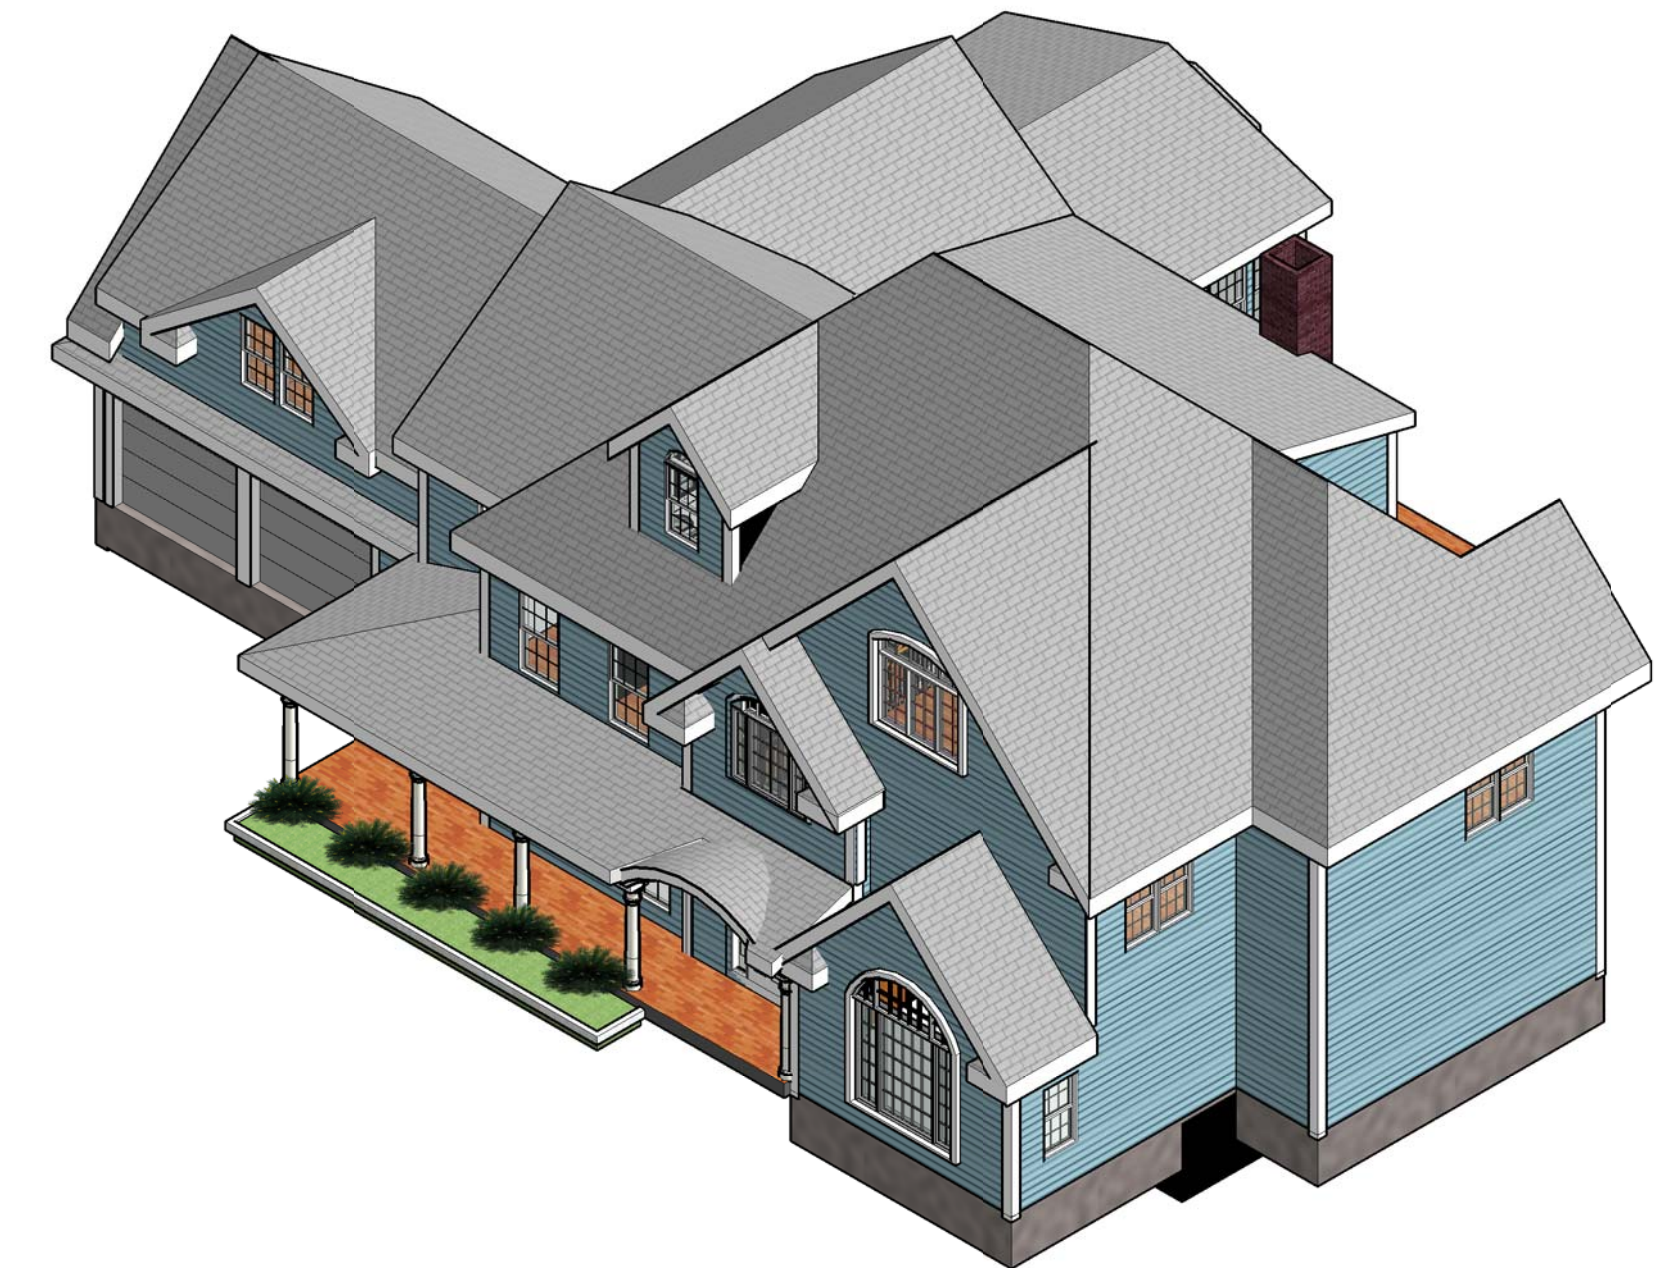

OWNER/CLIENT

Stephen & Robbie Werth

10 Cardinal Drive,
Westwood, MA

ARCHITECT



20 Conant Street | 978.750.9062
Danvers, MA 01923 | gienappdesign.com

STRUCTURAL

TLH Consulting

505 Middlesex Turnpike, Unit 14
Billerica, MA 01821
T: (978) 362-1804

MECHANICAL/PLUMBING

JRW Engineering

40 Town Farm Road
Brookfield MA 01506
T: (978) 857-0305

ELECTRICAL

Nangle Engineering Inc.

32 Prince Street
Danvers, MA 01923
T: (978) 777-7650



**GIENAPP
DESIGN**
ARCHITECTURE

20 Conant Street
Danvers, MA 01923
978.750.9062
gienappdesign.com

Werth Residence
 Renovation
 10 Cardinal Drive, Westwood, MA

Plot Date: 1/16/2017 10:05:54 AM

© 2017 Gienapp Design Associates, LLC
ALL RIGHTS RESERVED. ALL IDEAS, DESIGNS, PLANS
AND SPECIFICATIONS ARE THE PROPERTY OF
GIENAPP DESIGN ASSOCIATES. RIGHTS OF USE ARE
CONDITIONAL AND ARE LIMITED TO A ONE-TIME USE
TO CONSTRUCT A SINGLE PROJECT ON THE SITE SO
INDICATED. USE OF THE WORK AND ANY DERIVATIVE
WORK COVERED UNDER THIS COPYRIGHT FOR
OTHER PROJECTS IS PROHIBITED. THE USE OR
REPRODUCTION OF THESE PLANS FOR ANY OTHER
CONSTRUCTION OR PERMIT APPLICATION IS STRICTLY
PROHIBITED WITHOUT PRIOR WRITTEN PERMISSION
OF GIENAPP DESIGN ASSOCIATES AND THE
ARCHITECT WHOSE SIGNATURE AND SEAL MAY BE
AFFIXED TO THESE DRAWINGS.

Revisions	Date

Project: 622.1
 Drawn by: JB
 Check by: IB
 Date: 01/13/17
 Scale:

Specifications

T-2

08 14 33 WOOD DOORS & WINDOWS

- A. Windows: Basis-of-Design: Marvin Aluminum Clad Wood Window
- B. Doors: Veneer faced stile and rail wood door with painted finish
 1. Performance Grade: Heavy duty
 2. Grade: Premium, with Grade AA faces
 3. Species: Maple
 4. Cut: Plain sliced
 5. Finish: Exterior: to match existing interior: prime for paint
 6. Core: solid-core doors: either glued wood stave or structural composite lumber

08 71 00 FINISH HARDWARE

- A. Provide special wrenches and tools applicable to each different or special hardware component. Provide maintenance tools and accessories supplied by hardware component manufacturer.
- B. Lever style to be selected by architect. It is the intent to match existing style and finish.
- C. Equal products by other manufacturers are acceptable with prior approval by the Architect.
- D. A hardware schedule is located on drawing A-8.

09 29 00 GYPSUM WALL BOARD ASSEMBLIES

- A. Provide Gypsum Wall Board Assemblies: Interior partitions and ceilings for tape and joint compound finish.
- B. Gypsum Wall Board: ASTM C 1396, tapered edges
 1. Typical Condition: 5/8" core
 2. At wet locations (i.e. Toilet Room): Moisture-Resistant Gypsum Board, 5/8" core, Type X
 3. At tile installation locations: cement board
- C. Insulation within Gypsum Wall Board Assemblies: See 07 21 00.
- D. Trim Accessories:
 1. Material: Metal or plastic
 2. Types: Cornerbead, edge trim, and control joints

E. Studs and Runners: Wood

1. Minimum Base Thickness:
2. Depth: As indicated on drawings.

F. Slip-Type Head Joints: Where indicated, provide the following:

1. Single Long-Leg Runner System: Top runner with 2" deep flanges in thickness not less than indicated for studs.

09 30 13 TILE FLOORING

- A. The tile flooring is indicated as "T1" and "T2" on the drawings.
- B. Basis-of-design:
 1. (T1): Basis of Design: Dal-tile finish to be selected by Architect.
 2. (T2): Basis of Design: Dal-tile finish to be selected by Architect.
- C. Grout Material: Non-sanded
- D. Grout color: Architect will select color

09 50 00 CEILINGS

- A. It is the intent to provide a gypboard ceiling with a smooth, white finish.
- B. The ceiling types are as follows:
 - Type A: Gypsum Wall Board Ceiling, see 09 29 00 Gypsum Wall Board Assemblies

09 64 00 WOOD FLOORING

- A. Prior to new flooring installation, prep level sub-floor.
 1. Level depressed spots with a levelastic floor compound and allow to fully cure prior to flooring installation.
 2. If applicable, grind high spots.

09 68 00 CARPET

- A. Carpet is indicated as "CP" on the drawings and is only used for a runner at the new stair. (continuous on thread and riser).
- B. Basis-of-design: Shaw Floors: Luxury at Best
- C. Color: 00101 Soft Fleece or Architect approved equal.
- D. Type: Cut-Pile

09 90 00 PAINTING

- A. Provide painting and surface preparation for all new and existing partitions in the work area unless noted otherwise.
 - a. Walls on lower levels affected by this work shall be painted in entirety from room corner to room corner.
- B. See 06 20 00 Finish Carpentry and 06 41 00 Wood Casework for millwork and wood trim finish.
- C. Basis of design: Benjamin Moore
- D. Colors: Assume up to 6 colors will be used identified as P1-P6 and one ceiling color, one trim color and exterior paint color for the siding if Hardie does not have a color to match existing house.
 - a. Where existing walls are being repainted, match existing color.

10 28 00 TOILET ACCESSORIES

- A. The General Contractor is responsible for furnishing and installing all toilet accessories.
- B. Toilet Paper Dispenser (TP): Residential Essentials Bradford Polished Chrome Surface Mount Toilet Paper Holder (Polished Chrome)
- C. Mirror (MR):
- D. Coat Hook (CH): Selected by Owner (Provide blocking in wall cavity where indicated)
- E. Towel Rod:

For MEP/FP information, see to MEP/FP drawings.
 For Electrical information, see to Electrical drawings.

01 50 00 TEMPORARY FACILITIES AND CONTROLS

- A. The following conditions are responsibilities of the Contractor:
 - a. Temporary Electrical:
 - The existing power source in the building, may be utilized by the Contractor at no charge.
 - Provide adequate lighting to facilitate the work.
 - b. Temporary Heating:
 - This project involves removing existing roofing during the winter months. The Contractor is responsible for keeping the project weather-tight and providing heating to maintain a temperature of no less than 68 degrees in these exposed areas of the house.
 - c. Temporary Toilets
 - Contractor and workers are not allowed to use the residence is bathrooms. Contractor must provide a temporary toilet (ie Port-o-potty).

02 41 00 DEMOLITION

- A. Remove all old and abandoned materials. Cap all unused pipes.
- B. Do not allow demolished materials to accumulate on-site.
- C. Remove and transport debris in a manner that will prevent spillage on adjacent surfaces and areas.
- D. Transport demolished materials off Owner's property and legally dispose of them.
- E. Removed and reinstalled items: protect items from damage during transport and storage. Comply with installation requirements for new materials and equipment. Provide connections, supports, and miscellaneous materials necessary to make item functional for use indicated.
- F. Coordinate with Owner and utilities to arrange utility shut offs.
- G. Provide temporary barricades and other protection required to prevent injury to people and limit damage to adjacent existing elements.

06 10 00 ROUGH CARPENTRY

- A. Provide minimum 3/4" plywood blocking at all wall mounted fixtures and cabinets per industry standard, manufacturer's instruction, and as shown unless otherwise instructed for installation.
- B. Provide plywood substrate on floor joists at flooring locations.

06 20 00 FINISH CARPENTRY

- A. Install all finish carpentry per the highest standards of craftsmanship, ready for finishes as specified.
- B. Interior Trim
 - a. Grade: 1, plain sliced Maple (Acer Saccharinum) for solid lumber and AA, rotary sliced Maple for veneer.
 - b. Filler: No paste wood filler
 - c. Finish: three (3) coats urethane and stain as required to match factory finish doors.
- C. Exterior Trim
 - Material Basis of Design: Azek, primed for field paint unless pre-finished is available that matches existing trim.

06 41 00 WOOD CASEWORK - CABINETS/CLOSETS

- A. The General Contractor is responsible for finishing and installing cabinets and built-in shelving/storage and all other cabinets not specifically identified as by a separate vendor or contractor.
 - a. Owner to select bathroom base cabinet and medicine cabinets.
 - b. Bathroom Sink Counter and Backsplash: Granite. Selected by Owner.

07 21 00 THERMAL INSULATION

- A. Requirements:
 - a. The roof requires a minimum rating of R-49.
 - b. The attic walls require a minimum of R-13.
 - c. Roof insulation is to be closed cell spray foam insulation equal to an R-value of R49. Closed cell spray foam is typically R6.5 per inch. To get an R-value of R49, provide 7-1/2" or greater.
 - d. Insulation at interior walls between bedrooms and around bathroom walls is to be noise canceling, unfaced, fiberglass batt insulation: QuietZone with PureFiber Technology by Owens Corning.

07 30 00 ROOFING ASPHALT SHINGLES

- A. The asphalt shingles are to match the existing shingles on the rest of the house.
 1. Basis-fo-Design: CertainTeed, XT Extra Tough 25 Traditional Shingles

07 46 46 FIBER-CEMENT SIDING

- A. The clapboard siding is to match the existing on the rest of the house.
 1. Basis-fo-Design: HardiePlank Lap Siding, Cedarmill with ColorPlus Technology. Painting may be required to match the existing house siding.

07 61 00 METAL FLASHING

- A. The flashing is to match the existing material used. It appears that the existing flashing is aluminum. V.I.F.

07 92 00 SEALANTS

- A. Typical Interior Sealant:
 1. Latex Joint Sealant: Acrylic latex or siliconized acrylic latex, ASTM C 834, Type OP, Grade NF.
 2. Pecora Corporation; AC-20+ or Architect approved equal.
- B. Acoustical Sealant
 1. Manufacturer's standard nonsag, paintable, nonstaining latex sealant complying with ASTM C 834. Product effectively reduces airborne sound transmission through perimeter joints and openings in building construction as demonstrated by testing representative assemblies according to ASTM E90.
 2. Pecora Corporation; AIS-919 or Architect approved equal.
 3. For sealing interior joints at countertops, vanities, tubs, plumbing fixtures, and other locations subject to moisture use Mildew-Resistant, Single-Component, Nonsag, Neutral-Curing Silicone Joint Sealant: ASTM C 920, Type S, Grade NS, Class 25, for Use NT.

08 00 00 GENERAL DOORS AND HARDWARE

- A. Provide proper rough openings for all doors.
- B. Provide and install all doors and hardware and their accessories as shown and according to the manufacturer's recommendations for complete and proper installation.

00 00 00 GENERAL CONDITIONS

- A. Only the highest quality of workmanship shall be considered acceptable and shall be firmly secured and relative to elevations and dimensions as shown in the drawings; true to plumb, level, square, and line.
- B. All work shall conform with all applicable codes and ordinances and with accepted local standards of the trades.
- C. Individual prints or partial sets of prints shall be considered part of the whole set of these drawings and specifications for this project. The recipient of individual prints or partial sets shall be responsible for information and intent not represented on the individual sheets or partial sets but found elsewhere in these drawings and specifications.
- D. The General Contractor shall be responsible for coordinating all aspects of the Work and shall inform the Owner of his work schedule and any anticipated changes that may occur in it. Place orders for all materials included in the Work by General Contractor or Subcontractors in time to prevent any delays in the Construction schedule or completion of the Work, unless otherwise noted.
- E. The General Contractor shall not proceed with any work which he believes to be contrary to his knowledge of good construction standards and practices and shall not use any substandard materials.
- F. The General Contractor shall be expected to inspect the site for conditions affecting work and for anticipating the effects of those conditions upon his work.
- G. Minor details not usually shown or specified but necessary for the proper installation or conformance with codes or standards listed herein shall be included in the work.
- H. All work and material or equipment shall be guaranteed for a minimum of one year from date of substantial completion. This includes work by Subcontractors.
- I. Items noted "Not In Contract", "N.I.C.", "By [Separate] Vendor", "By [Separate] Contractor", or "By Owner" are to be neither furnished nor installed under this contract unless noted otherwise, but are shown for informational purposes only. It is the responsibility of the Contractor to coordinate with separate vendors and contractors to complete the work of this project.
- J. The General Contractor will report any and all discrepancies or omissions found in the Drawings and Specifications to Architect/Designer. The Work affected shall not proceed until any clarification or revision has been completed or permission to continue.
- K. The Contract Documents represent the finished structure and do not indicate the methods of construction. The General Contractor shall supervise and direct the Work and shall be solely responsible for construction means, methods, techniques, sequences, and procedures.
- L. Each trade shall coordinate its work as is practical and will interfere as little as possible with the work of other trades and persons. It will be assumed that each trade has accepted the quality of the work of others upon which his work must be applied.
- M. During progress of Work maintain premises free of unnecessary accumulation of tools, equipment, surplus materials, and debris. Each Subcontractor shall be responsible for cleaning up after their respective work, as well as maintaining a clean and orderly site.
- N. Store and handle materials and equipment so as to prevent damage affecting appearances, performance of material, equipment or finished work. In the event of damage, promptly make repairs or replacements and be responsible for costs incurred and time required for repairs or replacements at no additional cost to the Owner.
- O. All subcontractors shall remove and redo defective work as determined by the General Contractor or the Designer at no additional cost to the General Contractor or Owner.
- P. There is no designated storage space on site. The Contractor may use the work area for storage.
- Q. Sound isolation is a major concern of the space. Stagger electrical boxes in partitions. If possible locate electrical boxes in separate stud cavities. Provide firestopping at any floor or partition penetrations.
- R. **For all items, provide shop drawings and product data for approval from Architect prior to ordering materials.**

00 10 00 INSURANCE REQUIREMENTS

- A. The Contractor shall provide a complete insurance package including:
 - Worker's Compensation \$1,000,000
 - Commercial General Liability \$2,000,000
 - Builder's Risk \$1,000,000
 - Excess Umbrella Liability \$2,000,000

01 10 00 WORK RESTRICTIONS











- A. On-site work may occur between 8am to 9pm Monday through Friday and on weekends.
- B. Existing exterior windows may not be removed for demolition or transport of material.
- C. When moving materials or equipment through common areas, the Contractor is responsible for protecting those areas from damage including providing carpet protection and wall protection.
- D. For access to the house, the Contractor must coordinate with the Owner for keys or access while the Owner is at the property only.
- E. It is the responsibility of the Contractor to coordinate with the Owner for dumpster locations.

01 10 00 DIMENSIONS, MEASUREMENTS, AND LAYOUT


- A. Dimensions shall take precedence over graphic representations. Scaling of the drawings for dimensions or locations of materials or equipment is considered unacceptable.
- B. Larger scale drawings take precedence over smaller scale drawings.
- C. Notes and details on Drawings shall take precedence over these General Notes and Typical Details. Written Specifications take precedence over graphic representation of materials and items as well as their locations.
- D. **All dimensions to finish materials unless noted otherwise.**
- E. Dimensions to side or center of doors or windows are to finish openings unless noted otherwise.
- F. The General Contractor shall be responsible for locating and laying out the Work (including elevations). The General Contractor will exercise proper precaution to verify figures shown on the Drawings while laying out the Work, and be responsible for all errors resulting from failure to exercise such precaution.

IF THIS SHEET IS NOT 24 X 36 IT IS A REDUCED SCALE PRINT - SCALE ACCORDINGLY
 SCALE 3"=1'-0"
 SCALE 1-1/2"=1'-0"
 SCALE 1"=1'-0"
 SCALE 1/2"=1'-0"
 SCALE 1/4"=1'-0"
 SCALE 20' 1/8"=1'-0"
 SCALE 10'
 SCALE 5'
 SCALE 0'

IF THIS SHEET IS NOT 24 X 36 IT IS A REDUCED SCALE PRINT - SCALE ACCORDINGLY

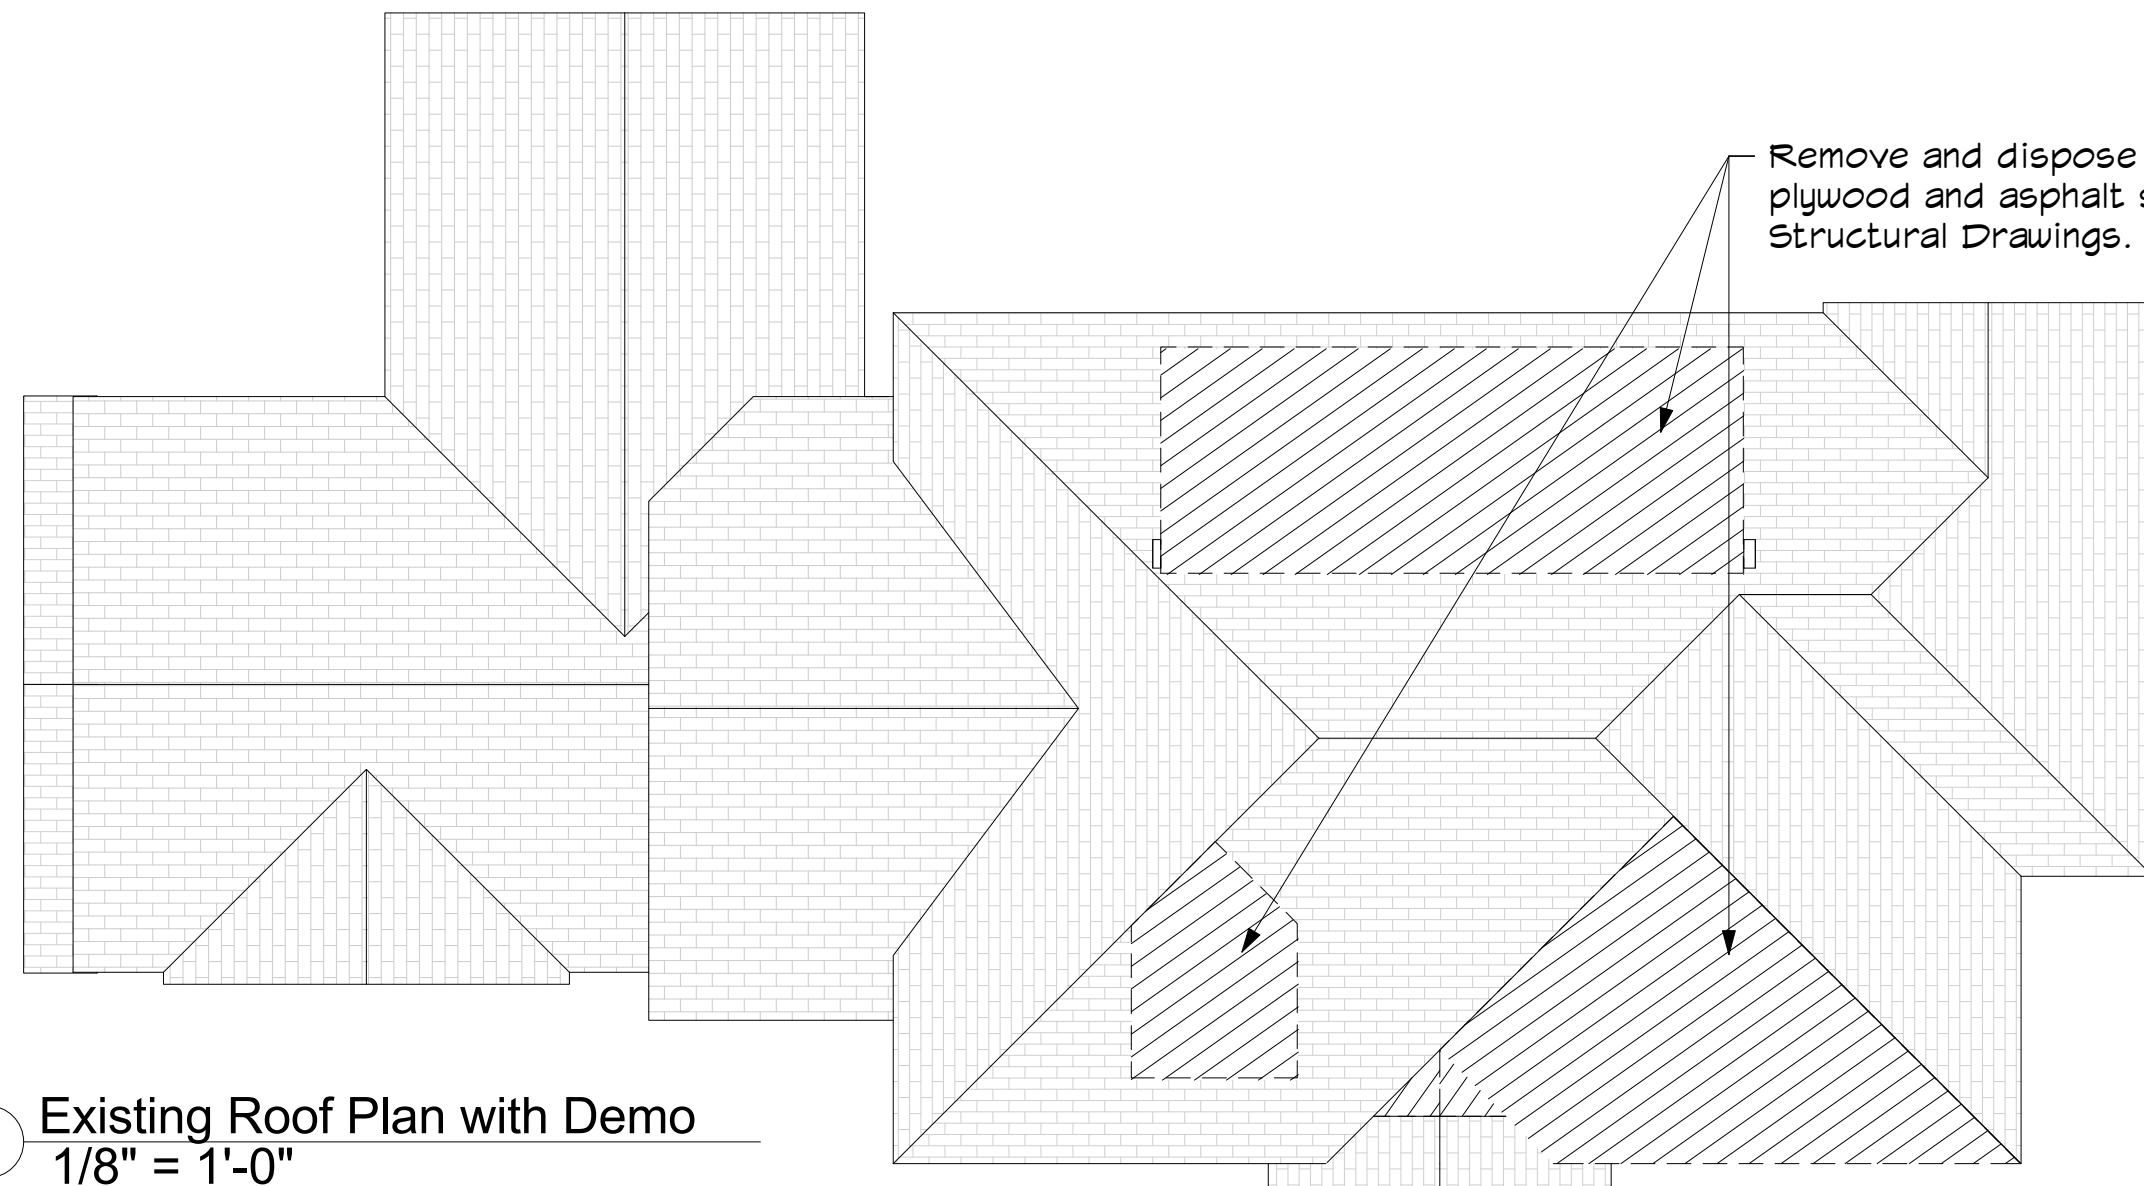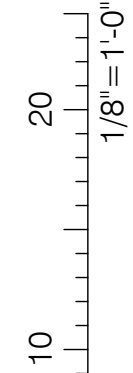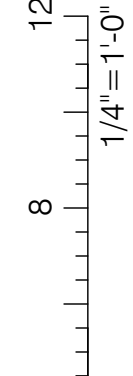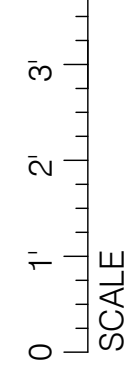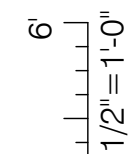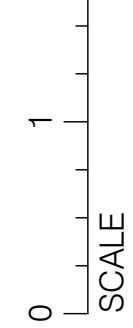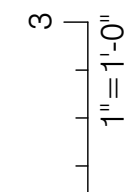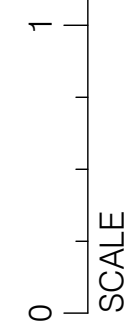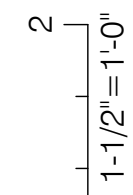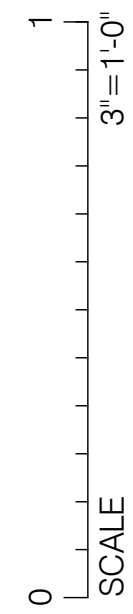


4 Existing Roof Plan with Demo
1/8" = 1'-0"

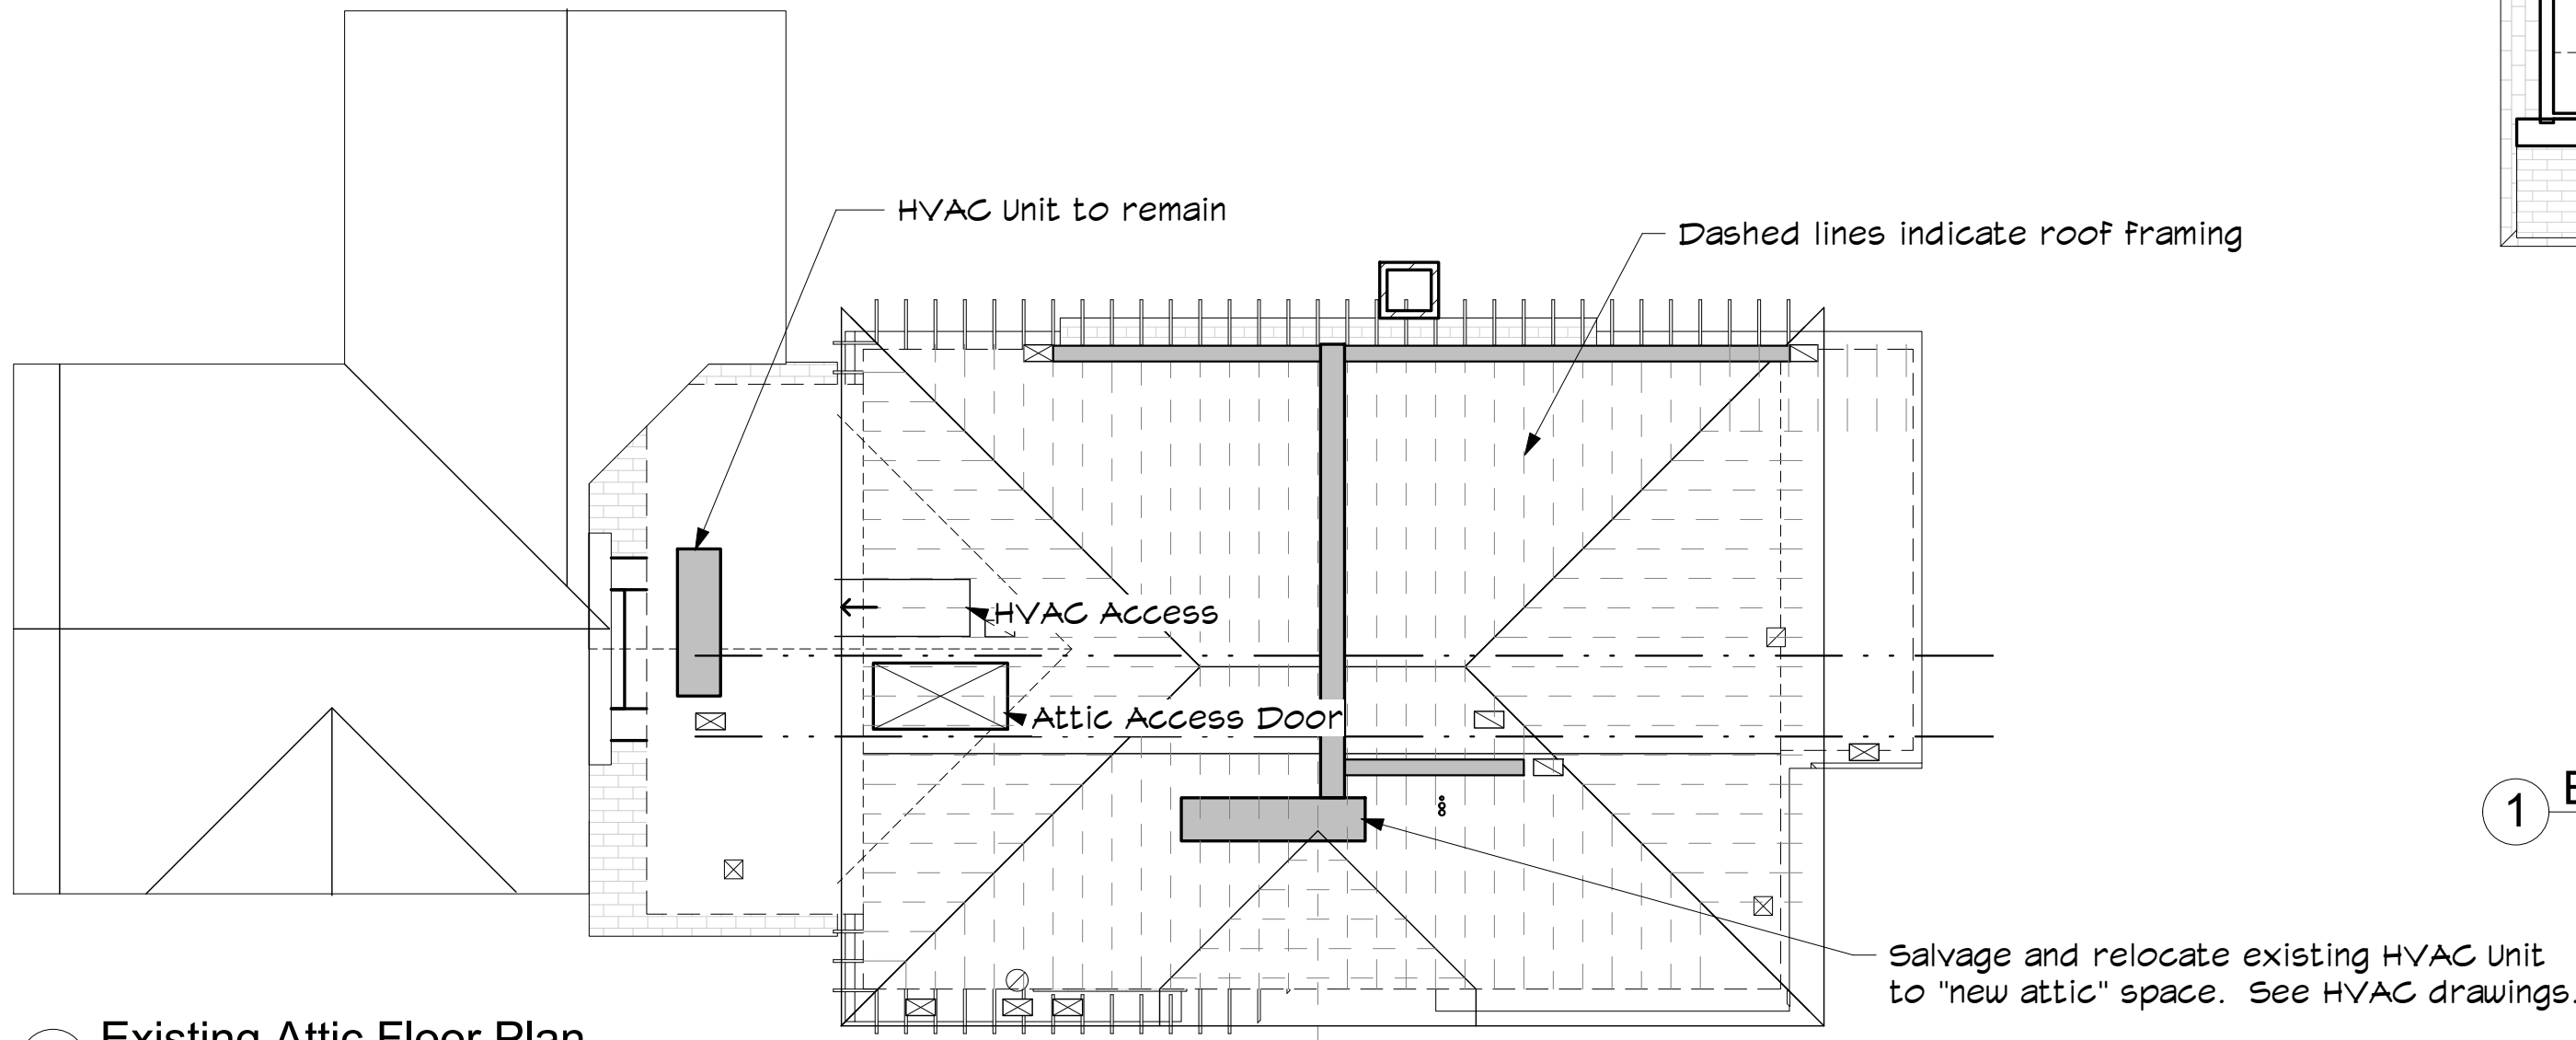

3 Existing Attic Floor Plan
1/8" = 1'-0"




6 Front Elevation
1/8" = 1'-0"

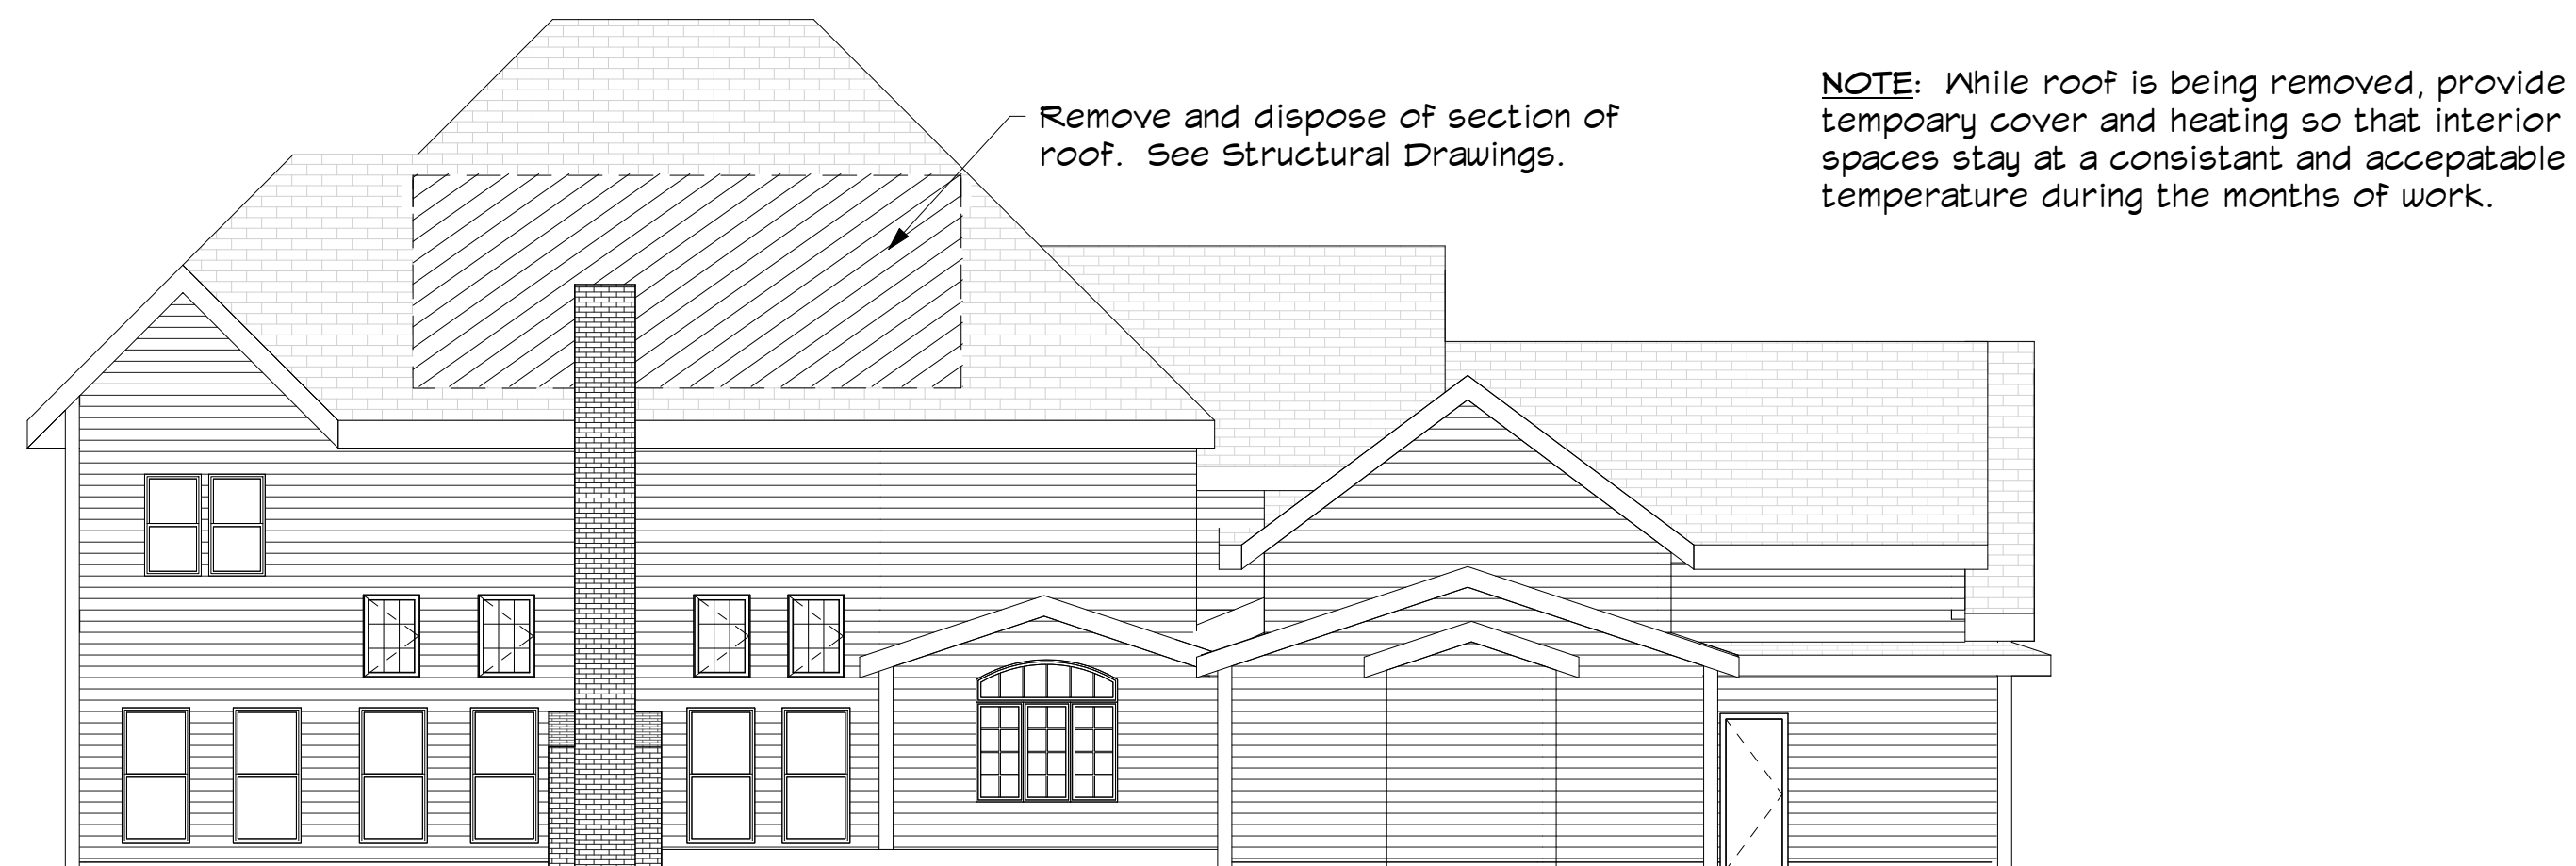


5 Existing North Elevation
1/8" = 1'-0"

NOTES:

- Where a corridor wall needs to be opened, open from the corridor side.
- Where note says to relocate supply and return registers, see HVAC drawings. Confirm locations on site with existing framing.

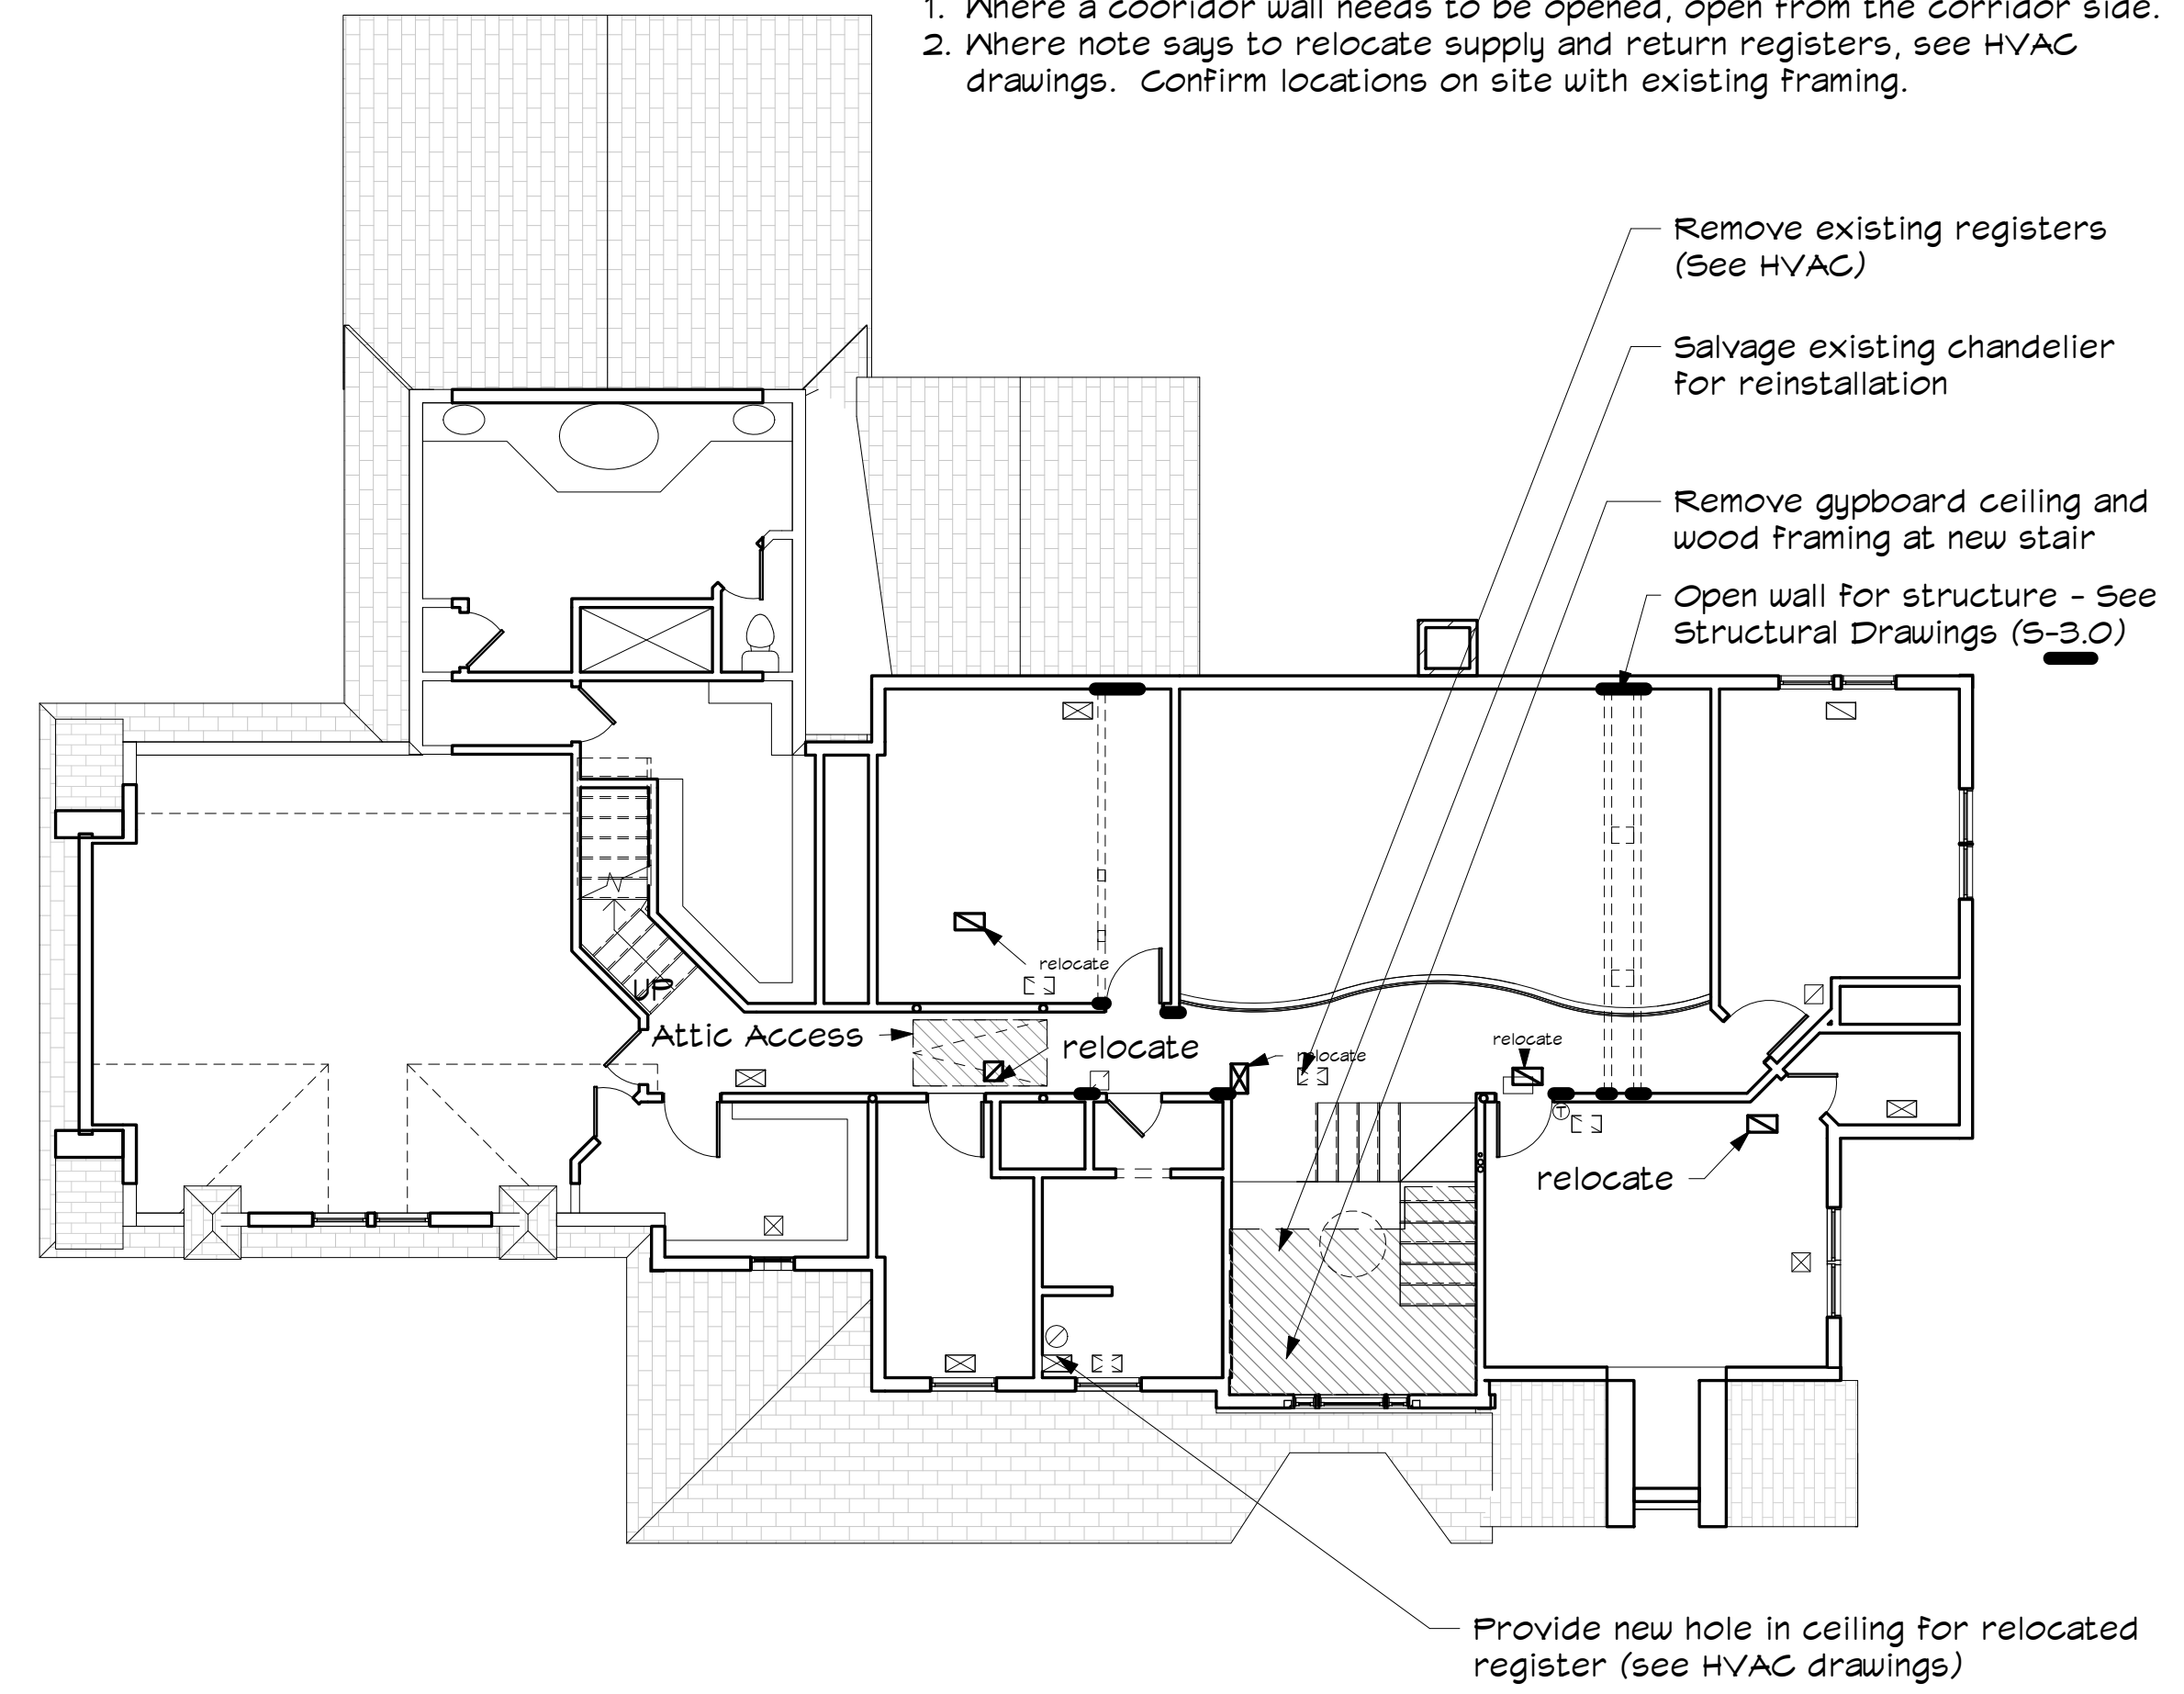

1 Existing Second Floor Plan with Demo
1/8" = 1'-0"

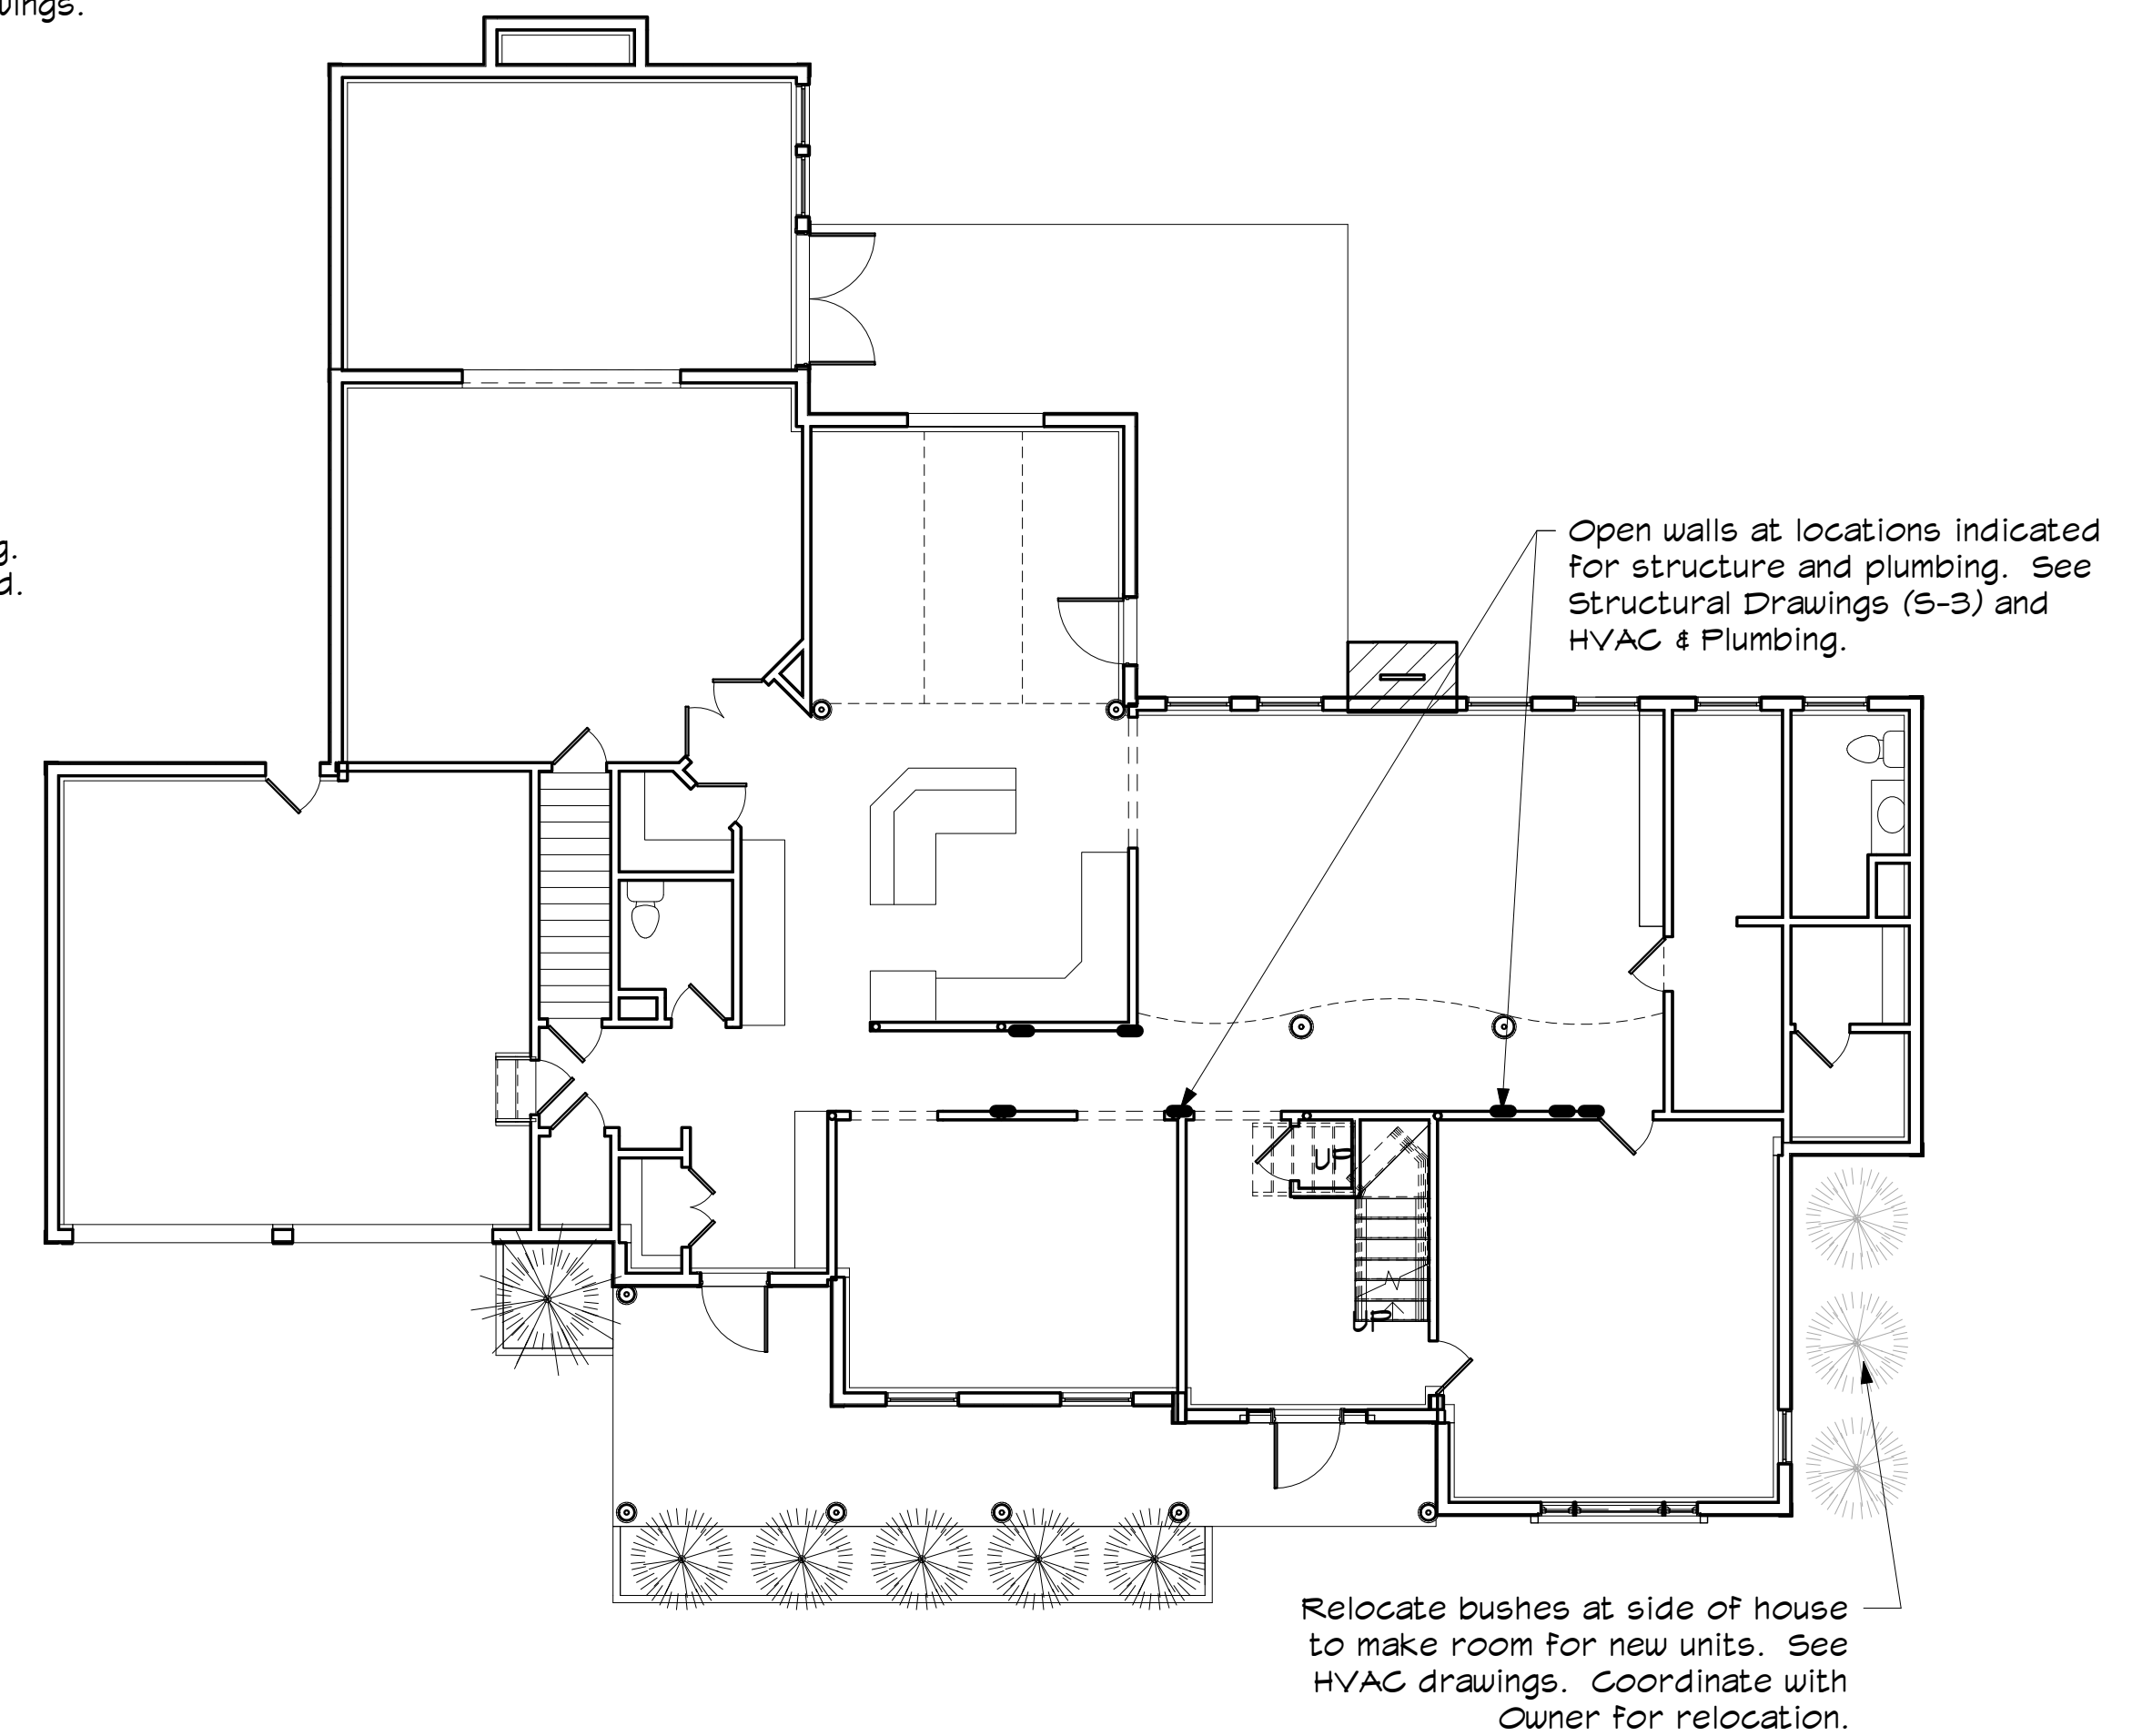

2 Existing First Floor Plan with Demo
1/8" = 1'-0"



**GIENAPP
DESIGN**
ARCHITECTURE

20 Conant Street
Danvers, MA 01923
978.750.9062
gienappdesign.com

Werth Residence
Renovation
10 Cardinal Drive, Westwood, MA

© 2017 Gienapp Design Associates, LLC
ALL RIGHTS RESERVED. ALL IDEAS, DESIGNS, PLANS AND SPECIFICATIONS ARE THE PROPERTY OF GIENAPP DESIGN ASSOCIATES. RIGHTS OF USE ARE CONDITIONAL AND ARE LIMITED TO A ONE-TIME USE TO CONSTRUCT A SINGLE PROJECT ON THE SITE SO INDICATED. USE OF THE WORK AND ANY DERIVATIVE WORK COVERED UNDER THIS COPYRIGHT FOR OTHER PROJECTS IS PROHIBITED. THE USE OR REPRODUCTION OF THESE PLANS FOR ANY OTHER CONSTRUCTION OR PERMIT APPLICATION IS STRICTLY PROHIBITED WITHOUT PRIOR WRITTEN PERMISSION OF GIENAPP DESIGN ASSOCIATES AND THE ARCHITECT WHOSE SIGNATURE AND SEAL MAY BE AFFIXED TO THESE DRAWINGS.

Revisions	Date

Project: 622.1
Drawn by: JB
Check by: IB
Date: 01/13/17
Scale: 1/8" = 1'-0"

Existing Floor Plans

Ex-1



**GIENAPP
DESIGN**
ARCHITECTURE

20 Conant Street
Danvers, MA 01923
978.750.9062
gienappdesign.com

Werth Residence
Renovation
10 Cardinal Drive, Westwood, MA

Plot Date: 1/16/2017 10:05:48 AM


© 2017 Gienapp Design Associates, LLC
ALL RIGHTS RESERVED. ALL IDEAS, DESIGNS, PLANS
AND SPECIFICATIONS ARE THE PROPERTY OF
GIENAPP DESIGN ASSOCIATES. RIGHTS OF USE ARE
CONDITIONAL AND ARE LIMITED TO A ONE-TIME USE
TO CONSTRUCT A SINGLE PROJECT ON THE SITE SO
INDICATED. USE OF THE WORK AND ANY DERIVATIVE
WORK COVERED UNDER THIS COPYRIGHT FOR
OTHER PROJECTS IS PROHIBITED. THE USE OR
REPRODUCTION OF THESE PLANS FOR ANY OTHER
CONSTRUCTION OR PERMIT APPLICATION IS STRICTLY
PROHIBITED WITHOUT PRIOR WRITTEN PERMISSION
OF GIENAPP DESIGN ASSOCIATES AND THE
ARCHITECT WHOSE SIGNATURE AND SEAL MAY BE
AFFIXED TO THESE DRAWINGS.

Revisions	Date

Project: 622.1
Drawn by: JB
Check by: JB
Date: 01/13/17
Scale:

**Roof
Demolition**

Ex-2

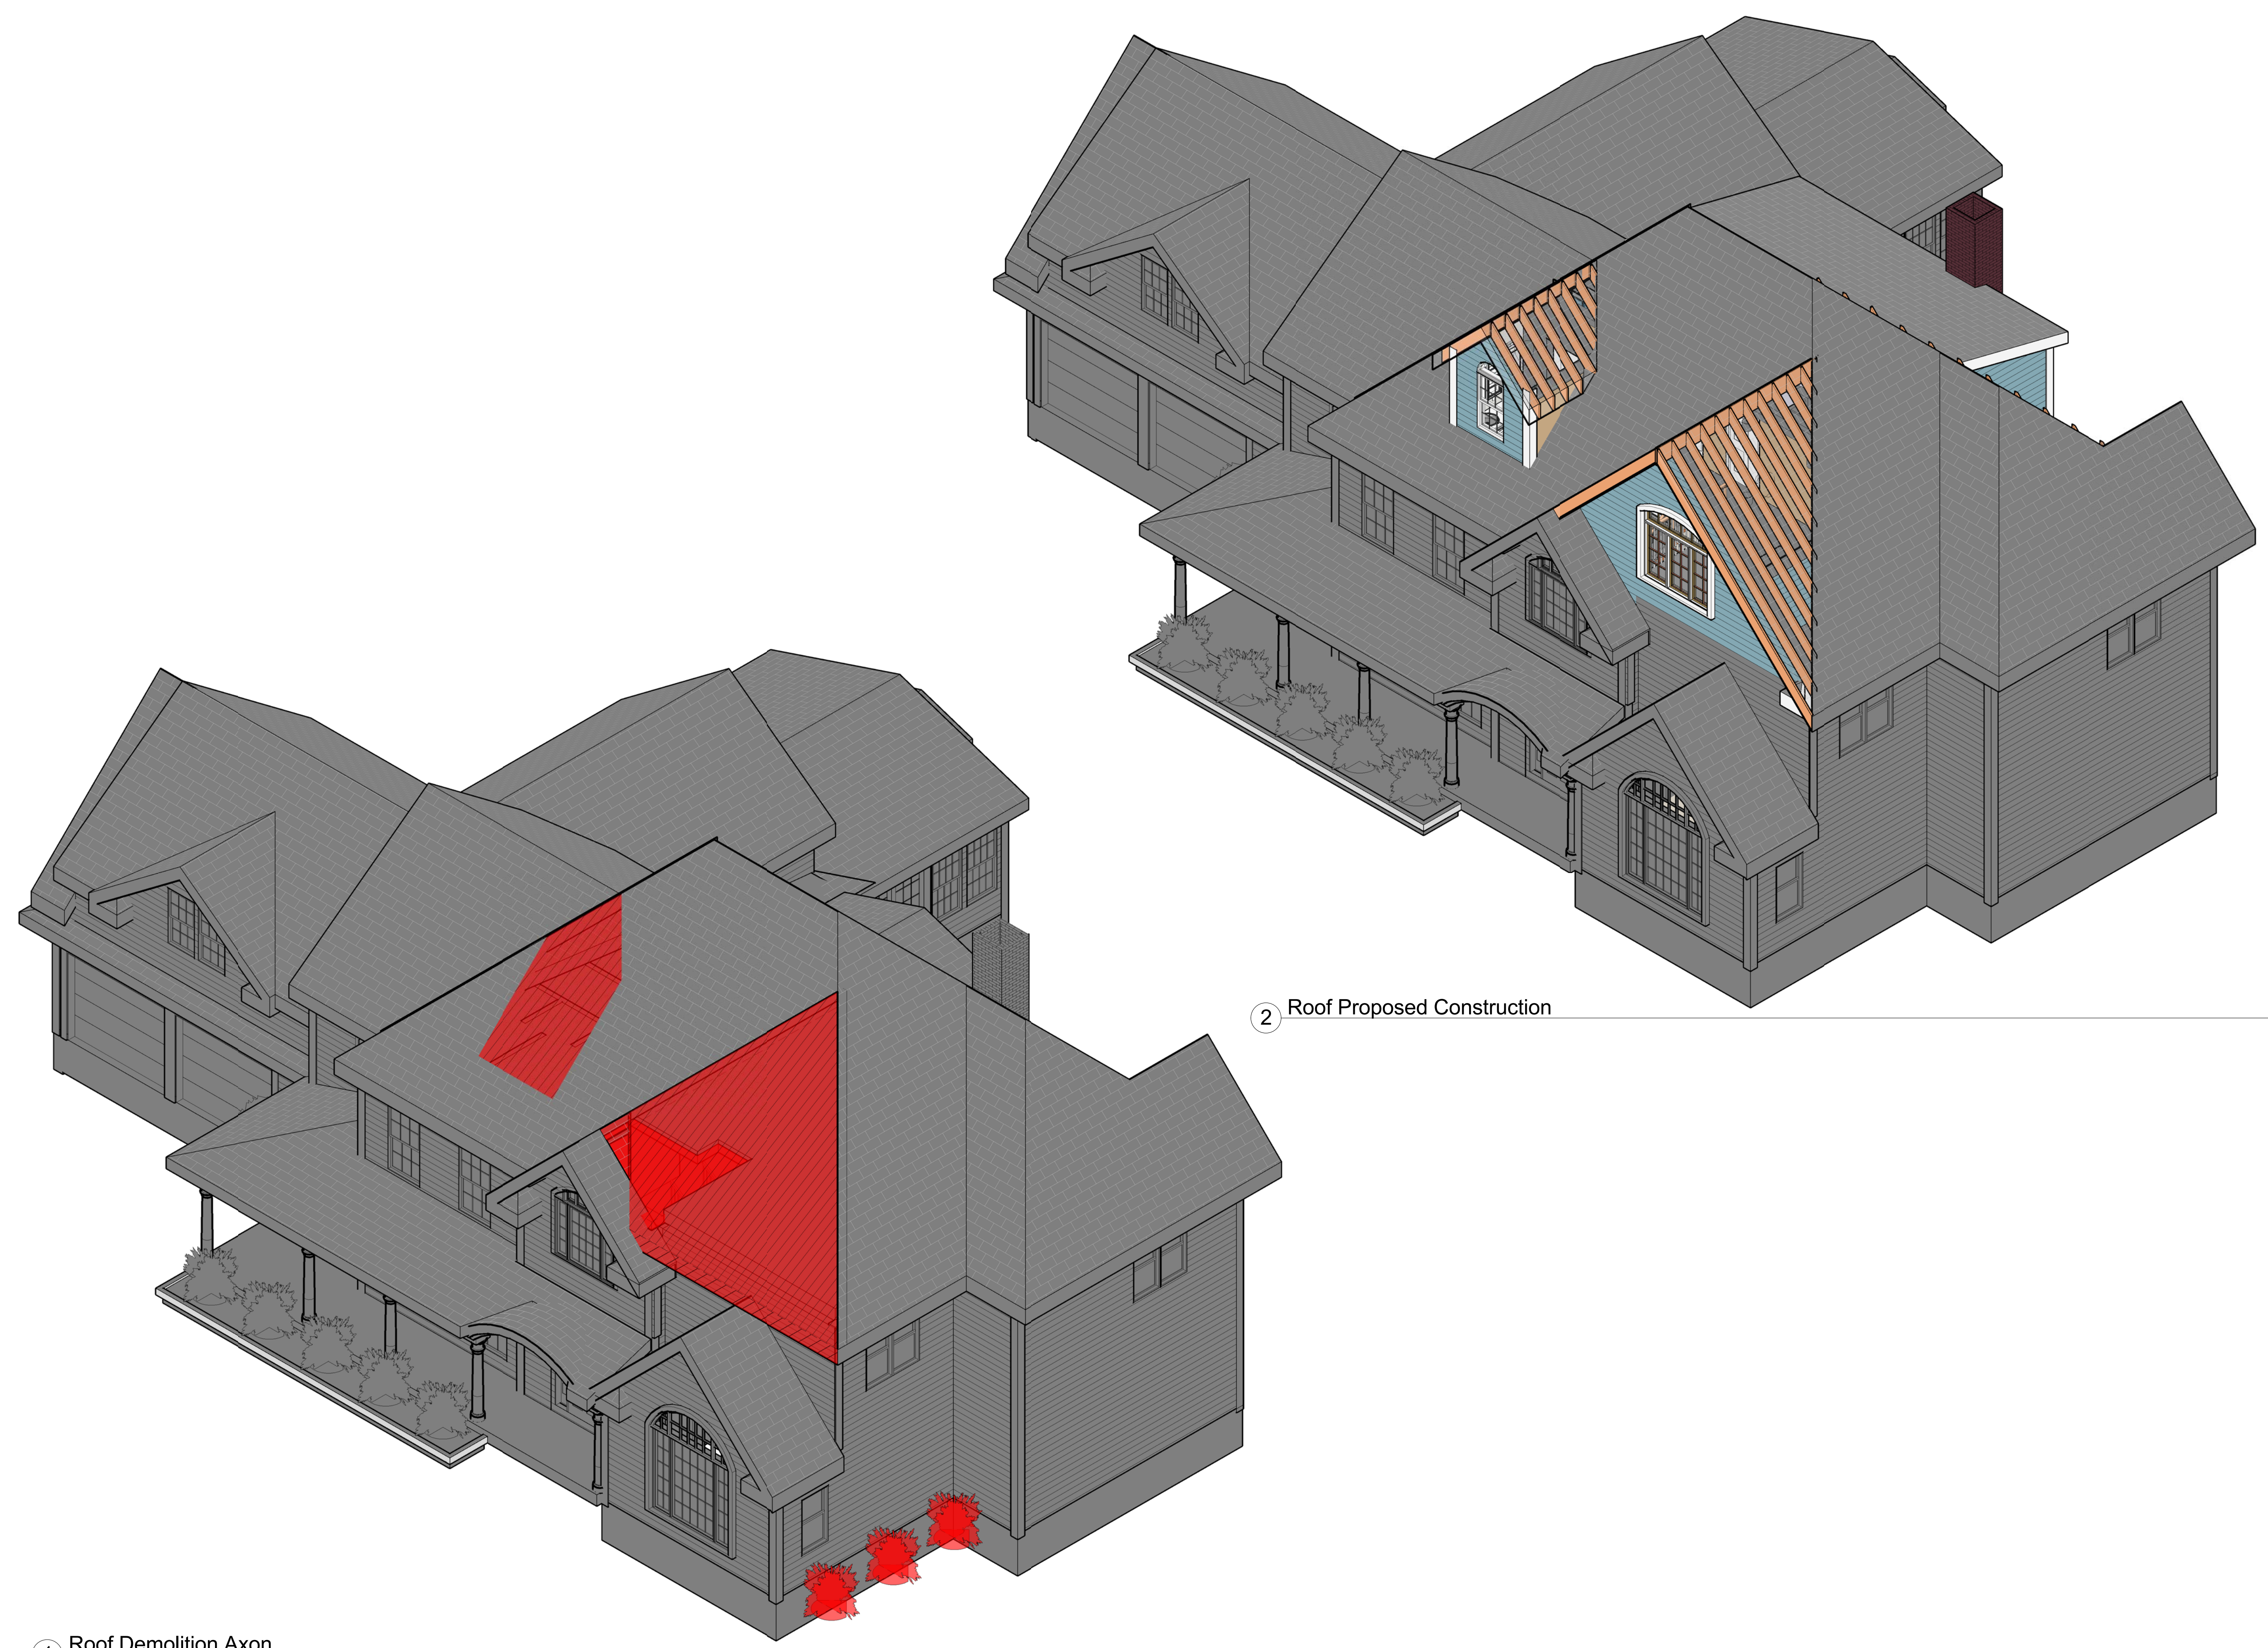

1 Roof Demolition Axon

2 Roof Proposed Construction

NOTE: These drawings are for reference and clarity. Refer to other sheets for information.

IF THIS SHEET IS NOT 24 X 36 IT IS A REDUCED SCALE PRINT - SCALE ACCORDINGLY

SCALE 1"=1'-0"

SCALE 1/2"=1'-0"

SCALE 1/4"=1'-0"

SCALE 1/8"=1'-0"

F:\01 62221 Werth Residence\Rev\Rev02 1 DRAWINGS AND SPECIFICATIONS\02 1 Working Set\02 1 Werth Residence_011317.rvt



**GIENAPP
DESIGN**
ARCHITECTURE

20 Conant Street
Danvers, MA 01923
978.750.9062
gienappdesign.com

Werth Residence
Renovation
10 Cardinal Drive, Westwood, MA

Plot Date: 11/16/2017 10:05:20 AM

© 2017 Gienapp Design Associates, LLC
ALL RIGHTS RESERVED. ALL IDEAS, DESIGNS, PLANS
AND SPECIFICATIONS ARE THE PROPERTY OF
GIENAPP DESIGN ASSOCIATES. RIGHTS OF USE ARE
CONDITIONAL AND ARE LIMITED TO A ONE-TIME USE
TO CONSTRUCT A SINGLE PROJECT ON THE SITE SO
INDICATED. USE OF THE WORK AND ANY DERIVATIVE
WORK COVERED UNDER THIS COPYRIGHT FOR
OTHER PROJECTS IS PROHIBITED. THE USE OR
REPRODUCTION OF THESE PLANS FOR ANY OTHER
CONSTRUCTION OR PERMIT APPLICATION IS STRICTLY
PROHIBITED WITHOUT PRIOR WRITTEN PERMISSION
OF GIENAPP DESIGN ASSOCIATES AND THE
ARCHITECT WHOSE SIGNATURE AND SEAL MAY BE
AFFIXED TO THESE DRAWINGS.


Revisions	Date

Project: 622.1
Drawn by: JB
Check by: IB/DG
Date: 01/13/17
Scale: 1/8" = 1'-0"


**Proposed Attic
Floor Plan**

A-1


IF THIS SHEET IS NOT 24 X 36 IT IS A REDUCED SCALE PRINT - SCALE ACCORDINGLY

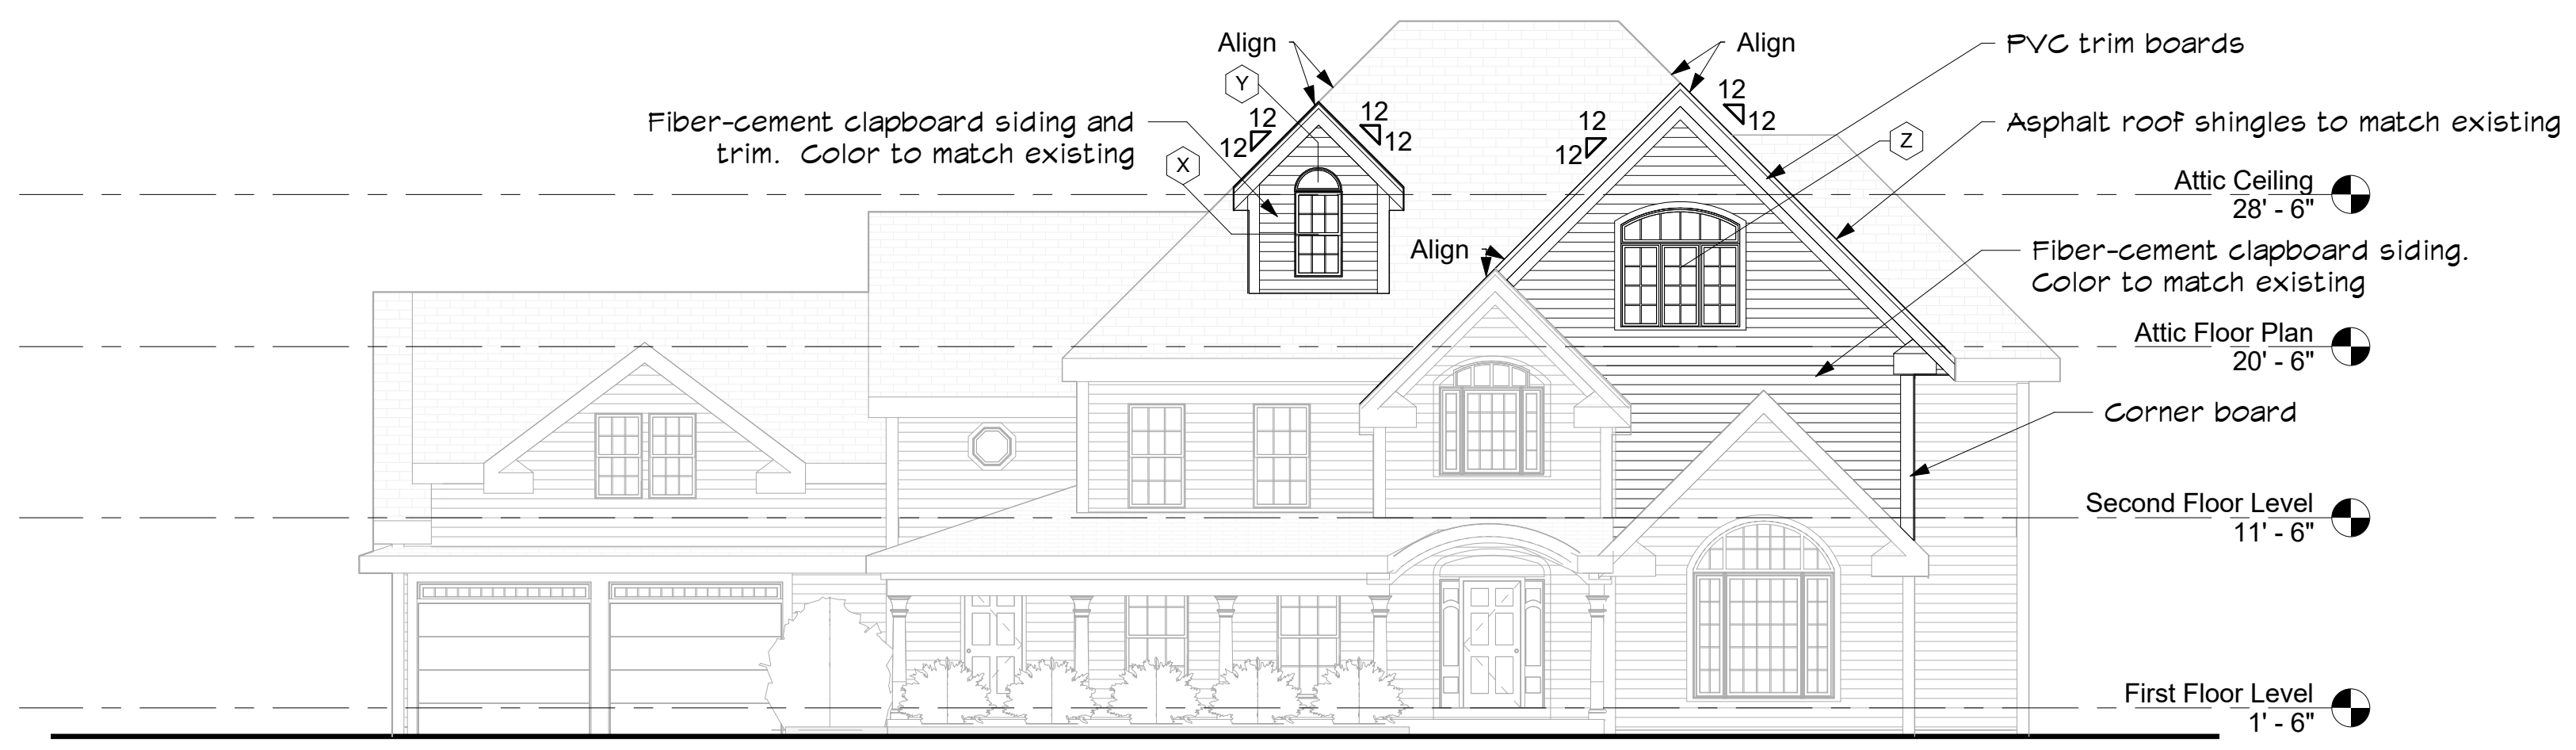


5 Front Elevation
1/8" = 1'-0"

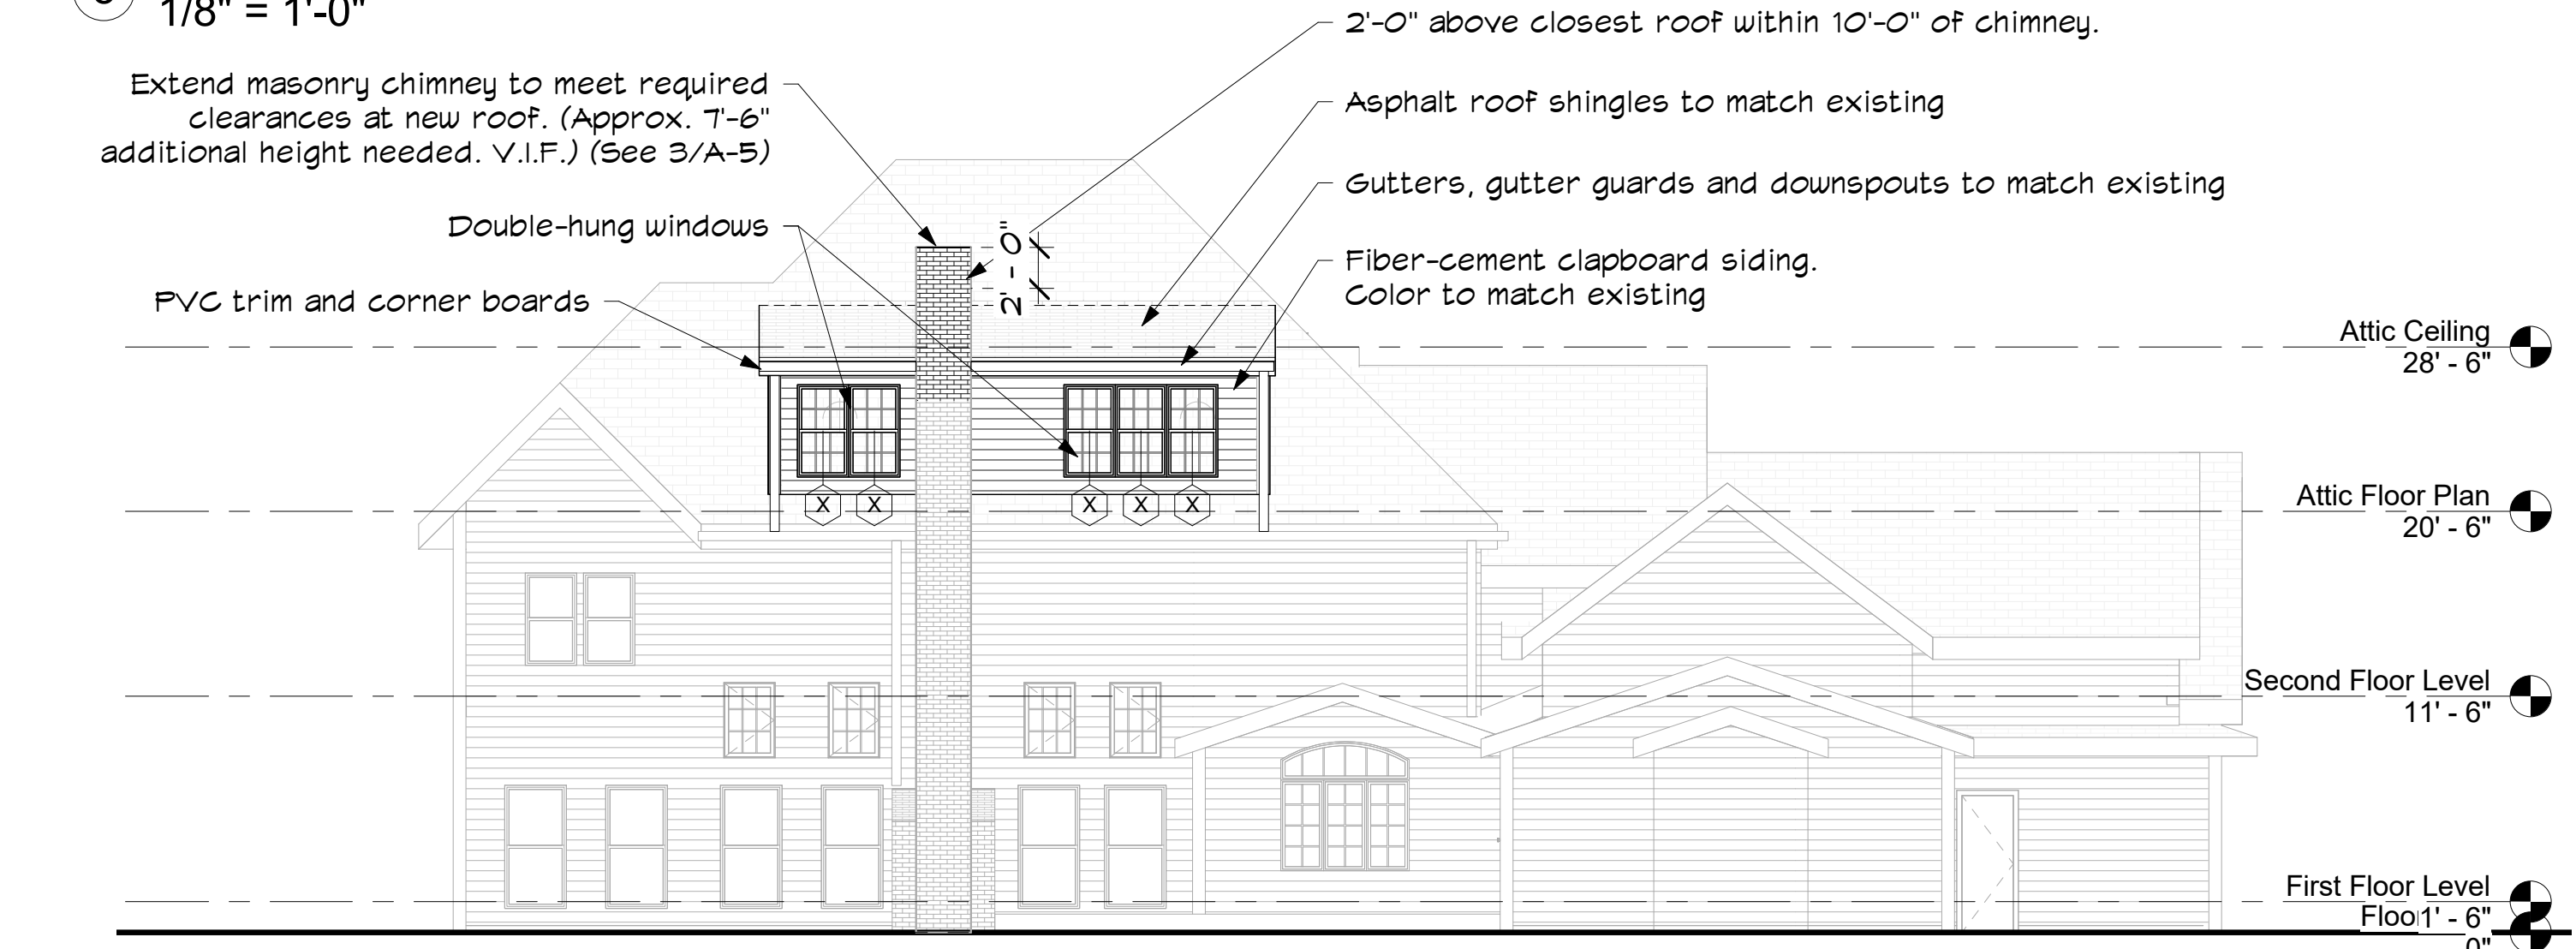


6 Rear Elevation
1/8" = 1'-0"

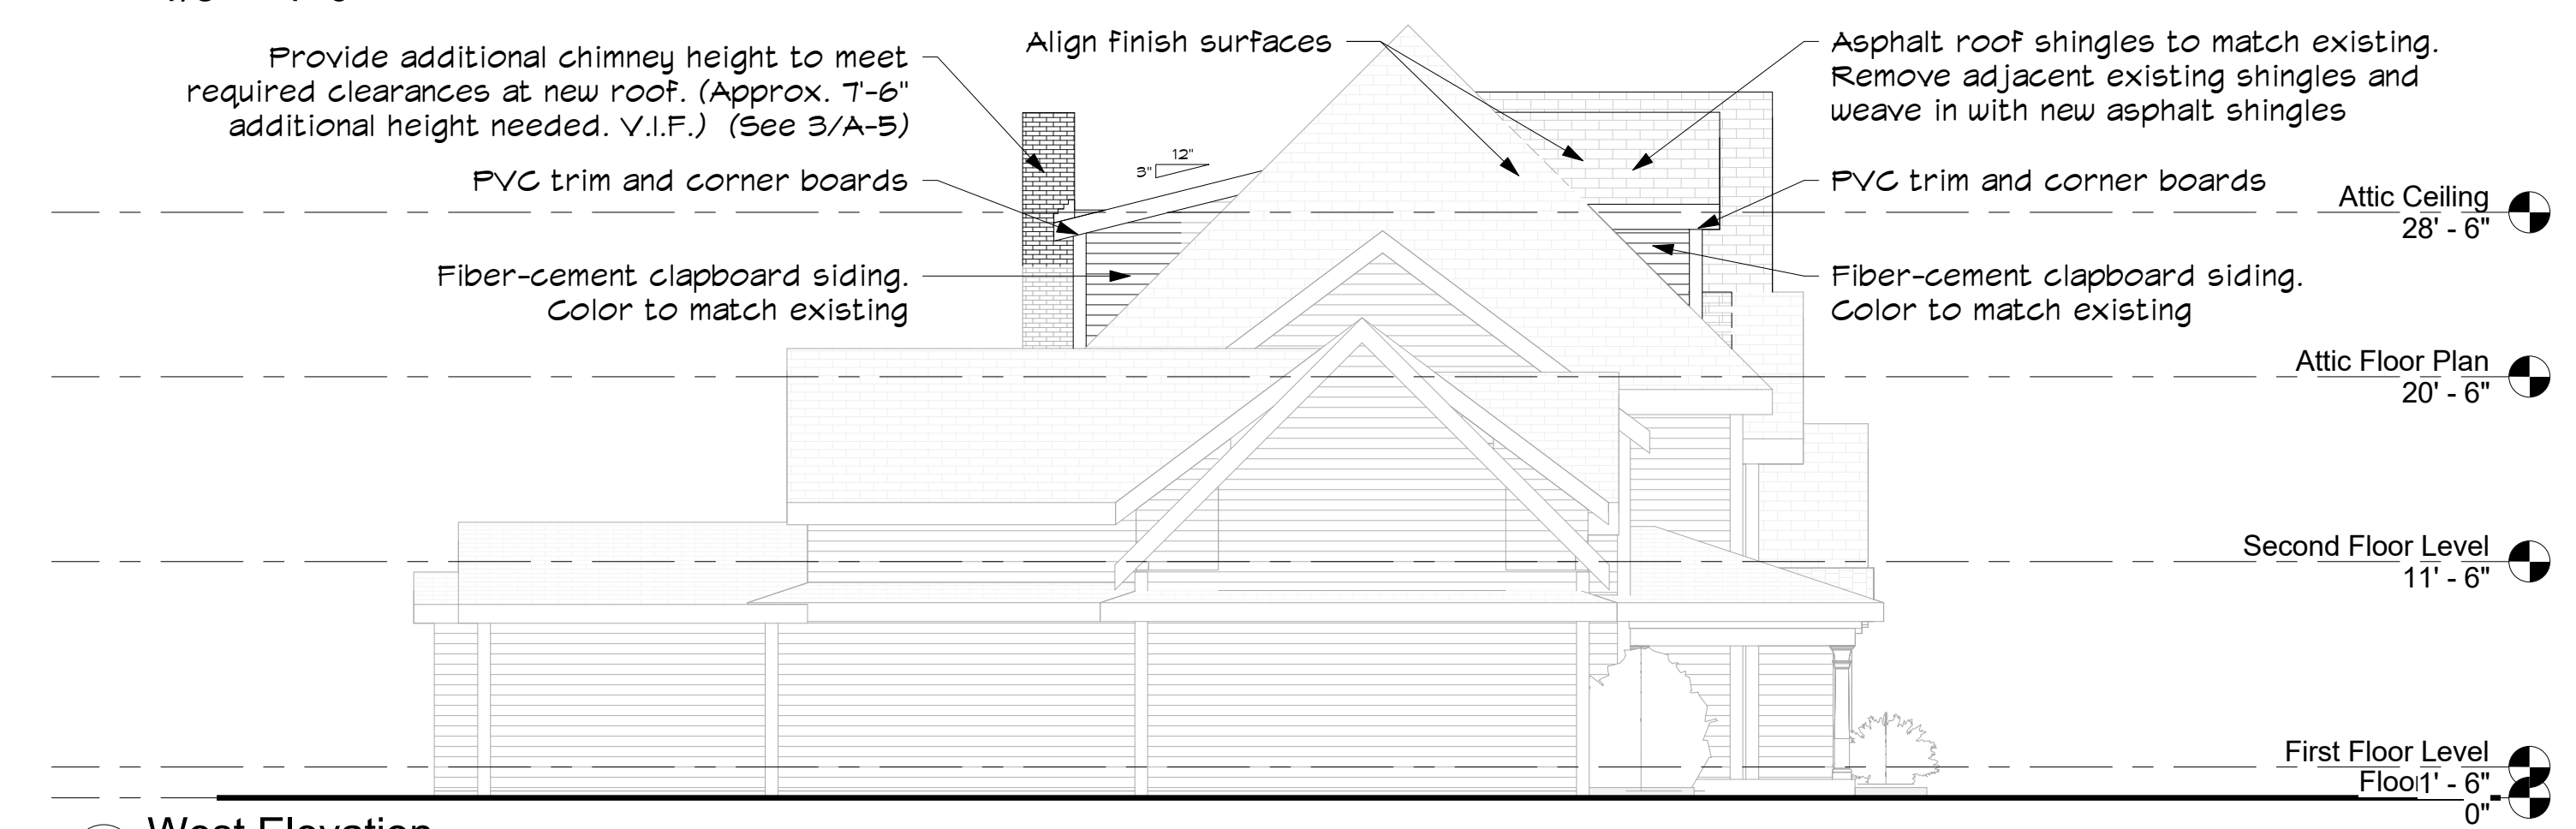

2 West Elevation
1/8" = 1'-0"

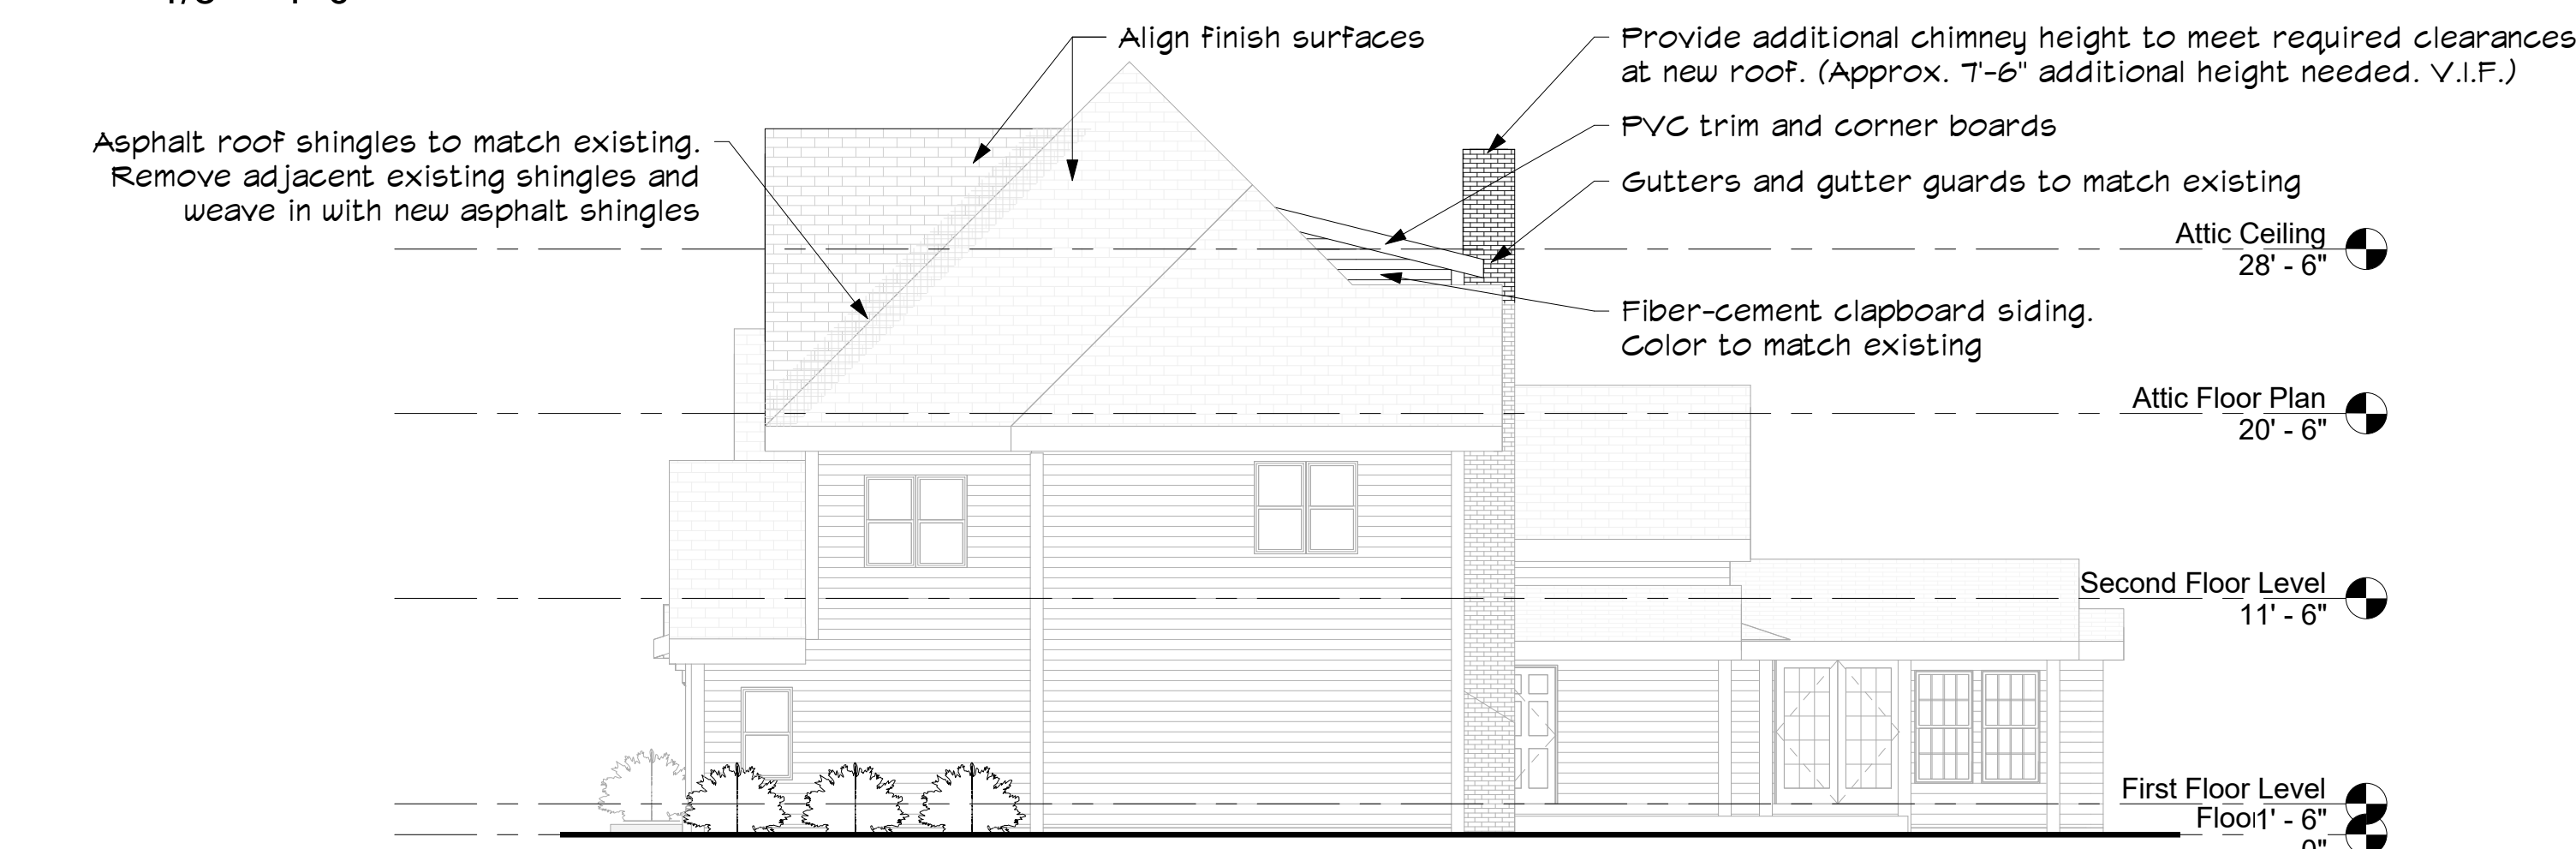


7 East Elevation
1/8" = 1'-0"

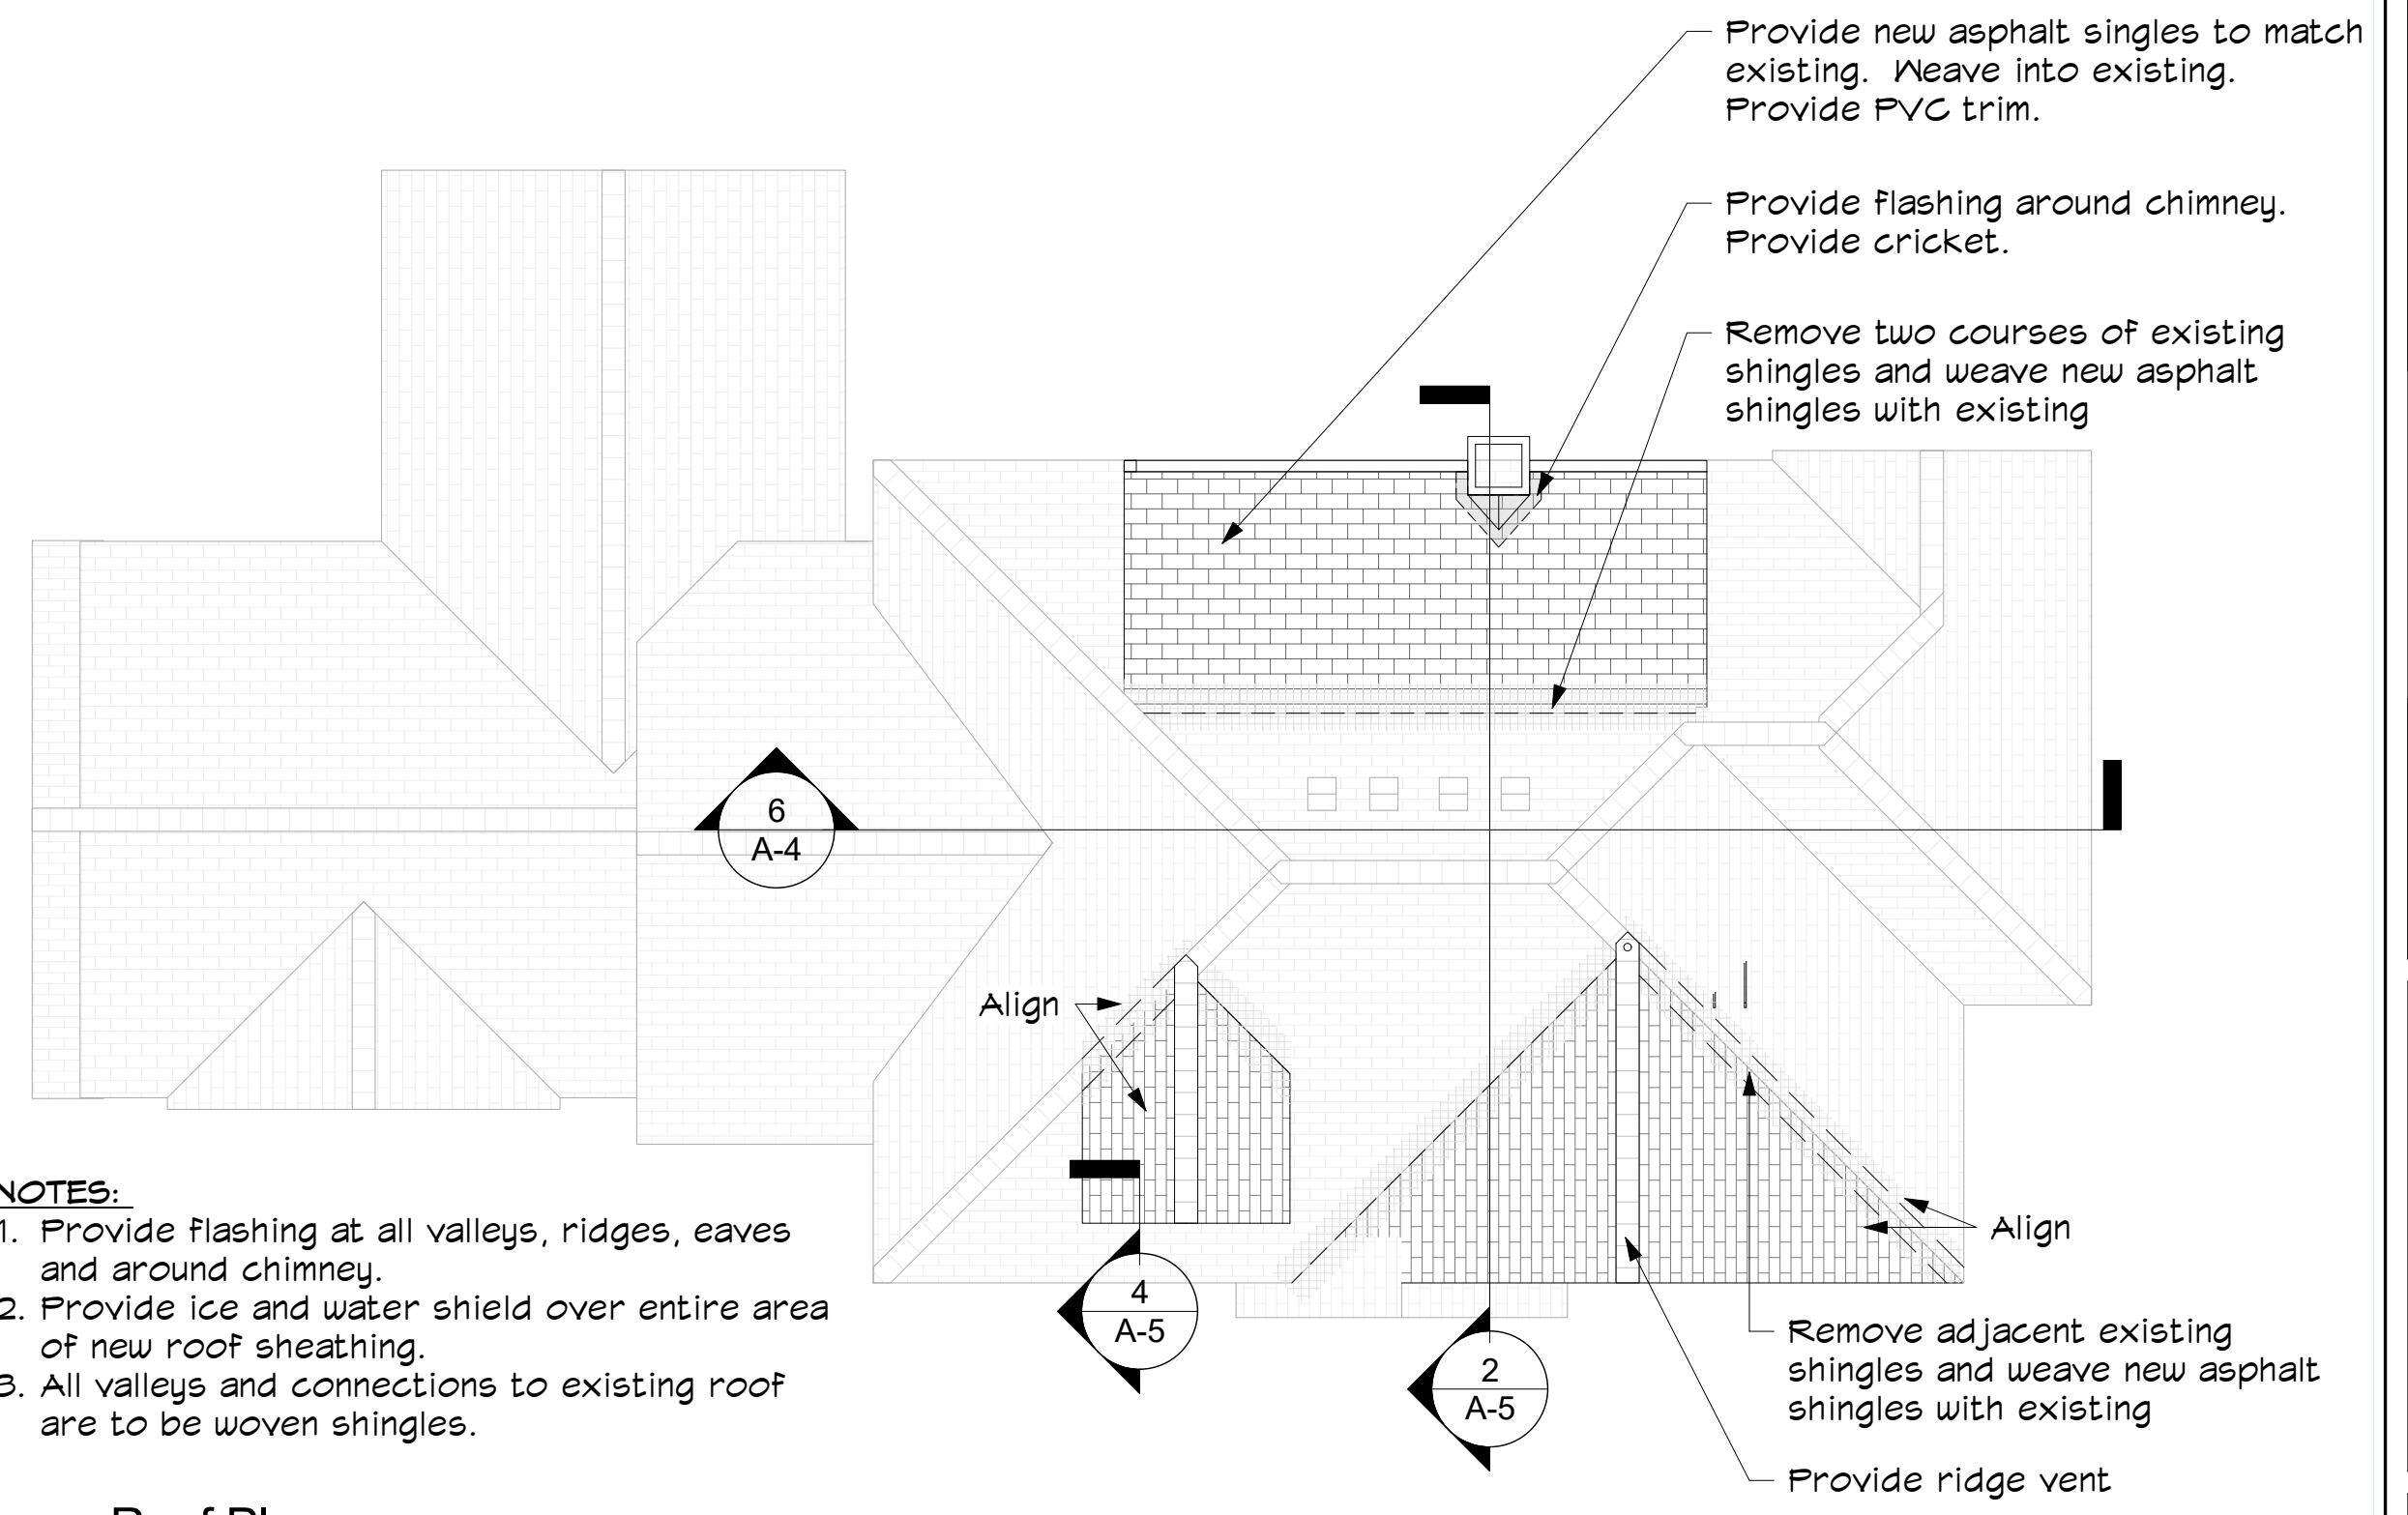


- NOTES:**
1. Provide flashing at all valleys, ridges, eaves and around chimney.
 2. Provide ice and water shield over entire area of new roof sheathing.
 3. All valleys and connections to existing roof are to be woven shingles.

3 Roof Plan
1/8" = 1'-0"

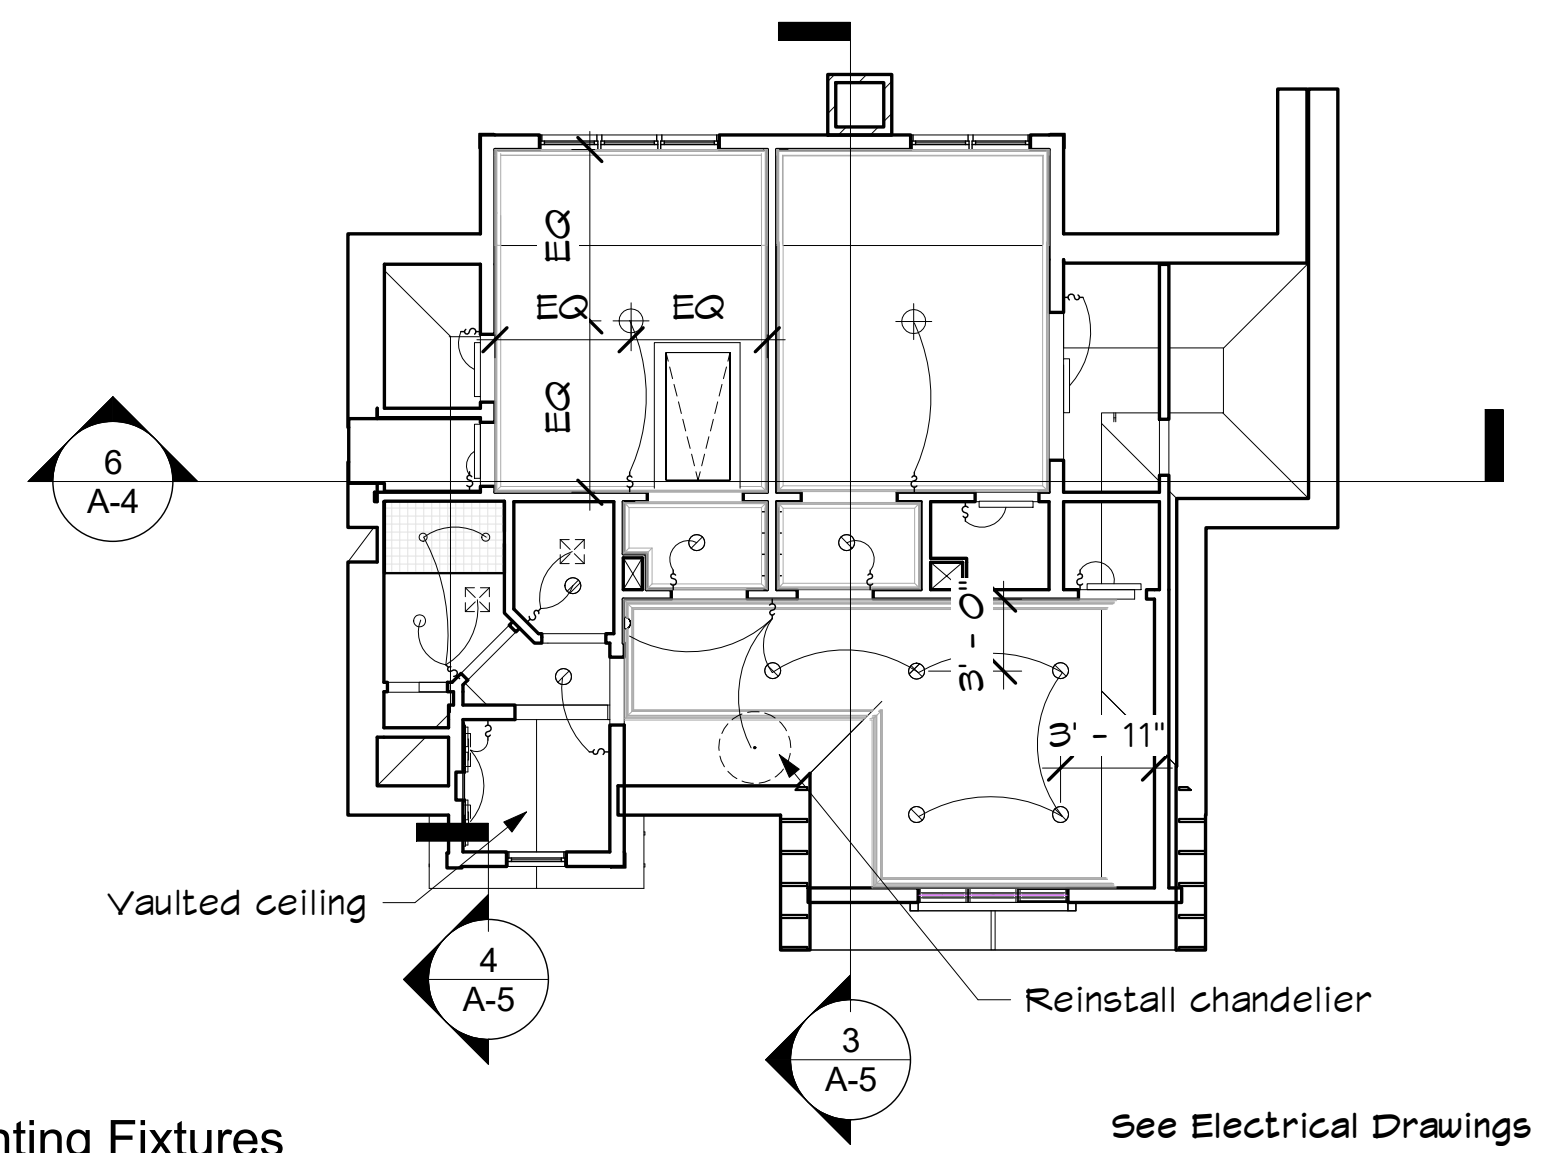

4 Attic Ceiling Plan with Lighting Fixtures
1/8" = 1'-0"

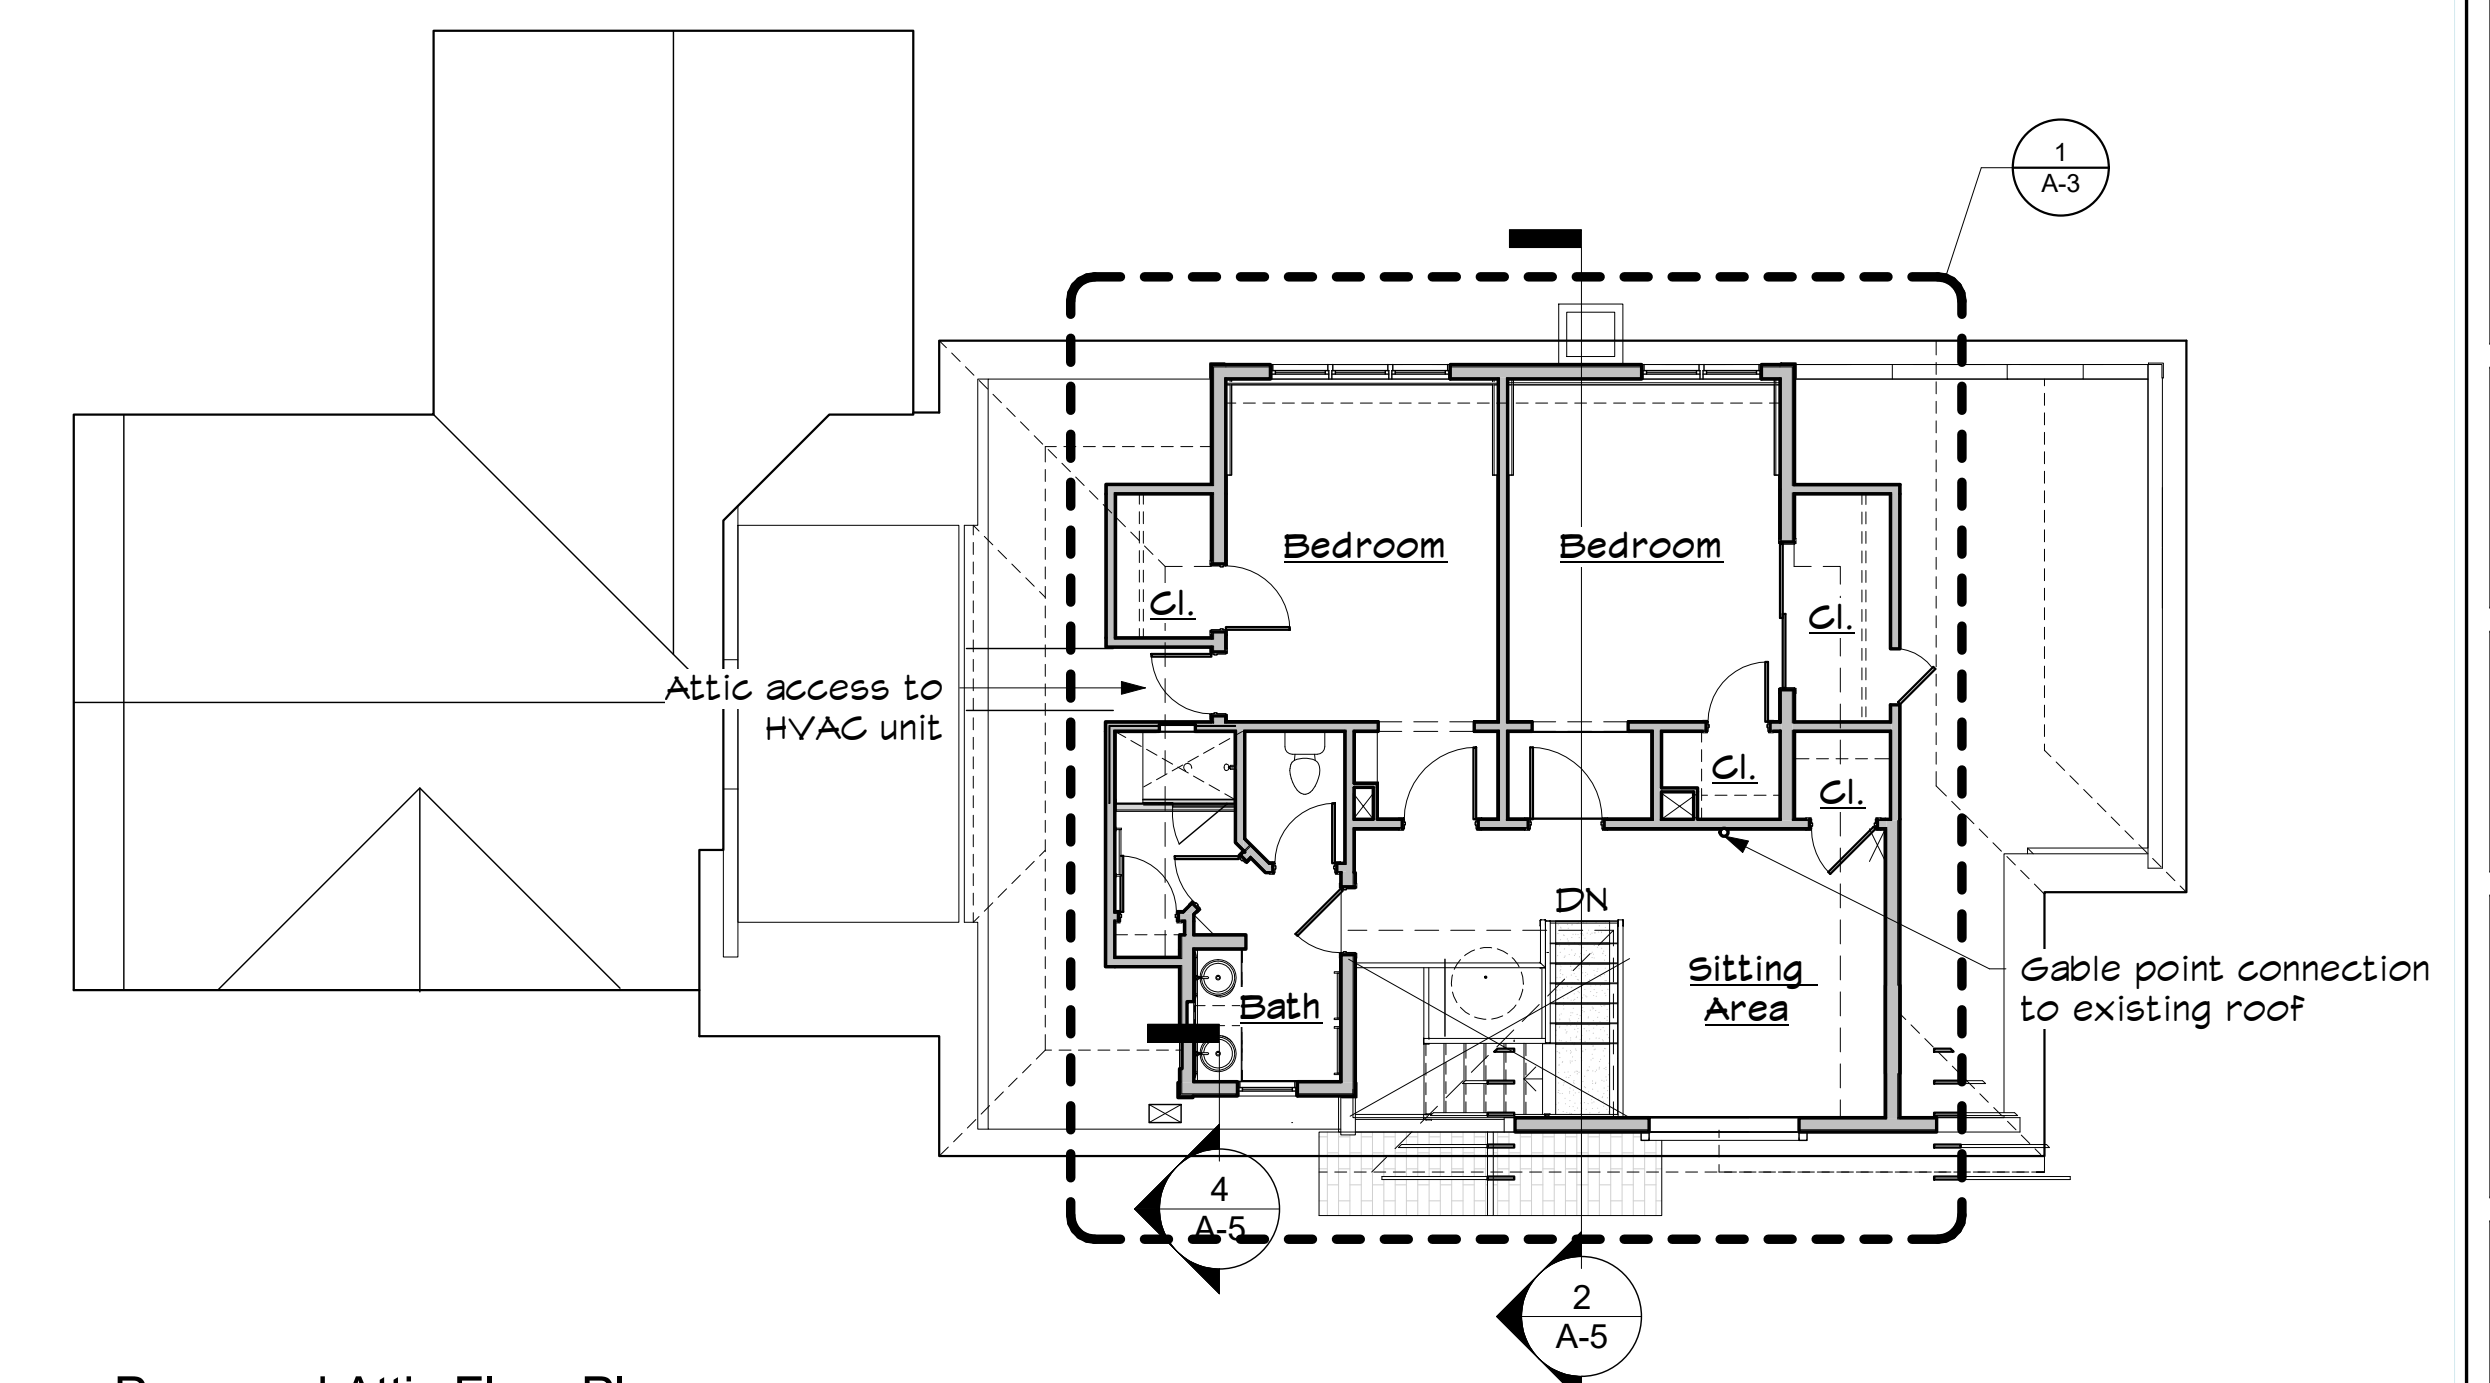

1 Proposed Attic Floor Plan
1/8" = 1'-0"

P:\01\609021\Westwood\Werth Residence\Attic Floor\021_DRAWINGS_AND_SPECIFICATIONS\021_Werth Residence_011317.rvt



**GIENAPP
DESIGN**
ARCHITECTURE

20 Conant Street
Danvers, MA 01923
978.750.9062
gienappdesign.com

Werth Residence
Renovation
10 Cardinal Drive, Westwood, MA

Plot Date: 11/16/2017 10:05:22 AM
© 2017 Gienapp Design Associates, LLC
ALL RIGHTS RESERVED. ALL IDEAS, DESIGNS, PLANS
AND SPECIFICATIONS ARE THE PROPERTY OF
GIENAPP DESIGN ASSOCIATES. RIGHTS OF USE ARE
CONDITIONAL AND ARE LIMITED TO A ONE-TIME USE
TO CONSTRUCT A SINGLE PROJECT ON THE SITE SO
INDICATED. USE OF THE WORK AND ANY DERIVATIVE
WORK COVERED UNDER THIS COPYRIGHT FOR
OTHER PROJECTS IS PROHIBITED. THE USE OR
REPRODUCTION OF THESE PLANS FOR ANY OTHER
CONSTRUCTION OR PERMIT APPLICATION IS STRICTLY
PROHIBITED WITHOUT PRIOR WRITTEN PERMISSION
OF GIENAPP DESIGN ASSOCIATES AND THE ARCHITECT
WHOSE SIGNATURE AND SEAL MAY BE
AFFIXED TO THESE DRAWINGS.

Revisions	Date

Project: 622.1
Drawn by: JB
Check by: IB
Date: 01/13/17
Scale: As indicated

**Attic Bedroom
Detail Floor
Plan**

A-3

IF THIS SHEET IS NOT 24 X 36 IT IS A REDUCED SCALE PRINT - SCALE ACCORDINGLY

SCALE 3"=1'-0"


SCALE 1'-1/2"=1'-0"

SCALE 1"=1'-0"

SCALE 1/2"=1'-0"


SCALE 1/4"=1'-0"

SCALE 1/8"=1'-0"

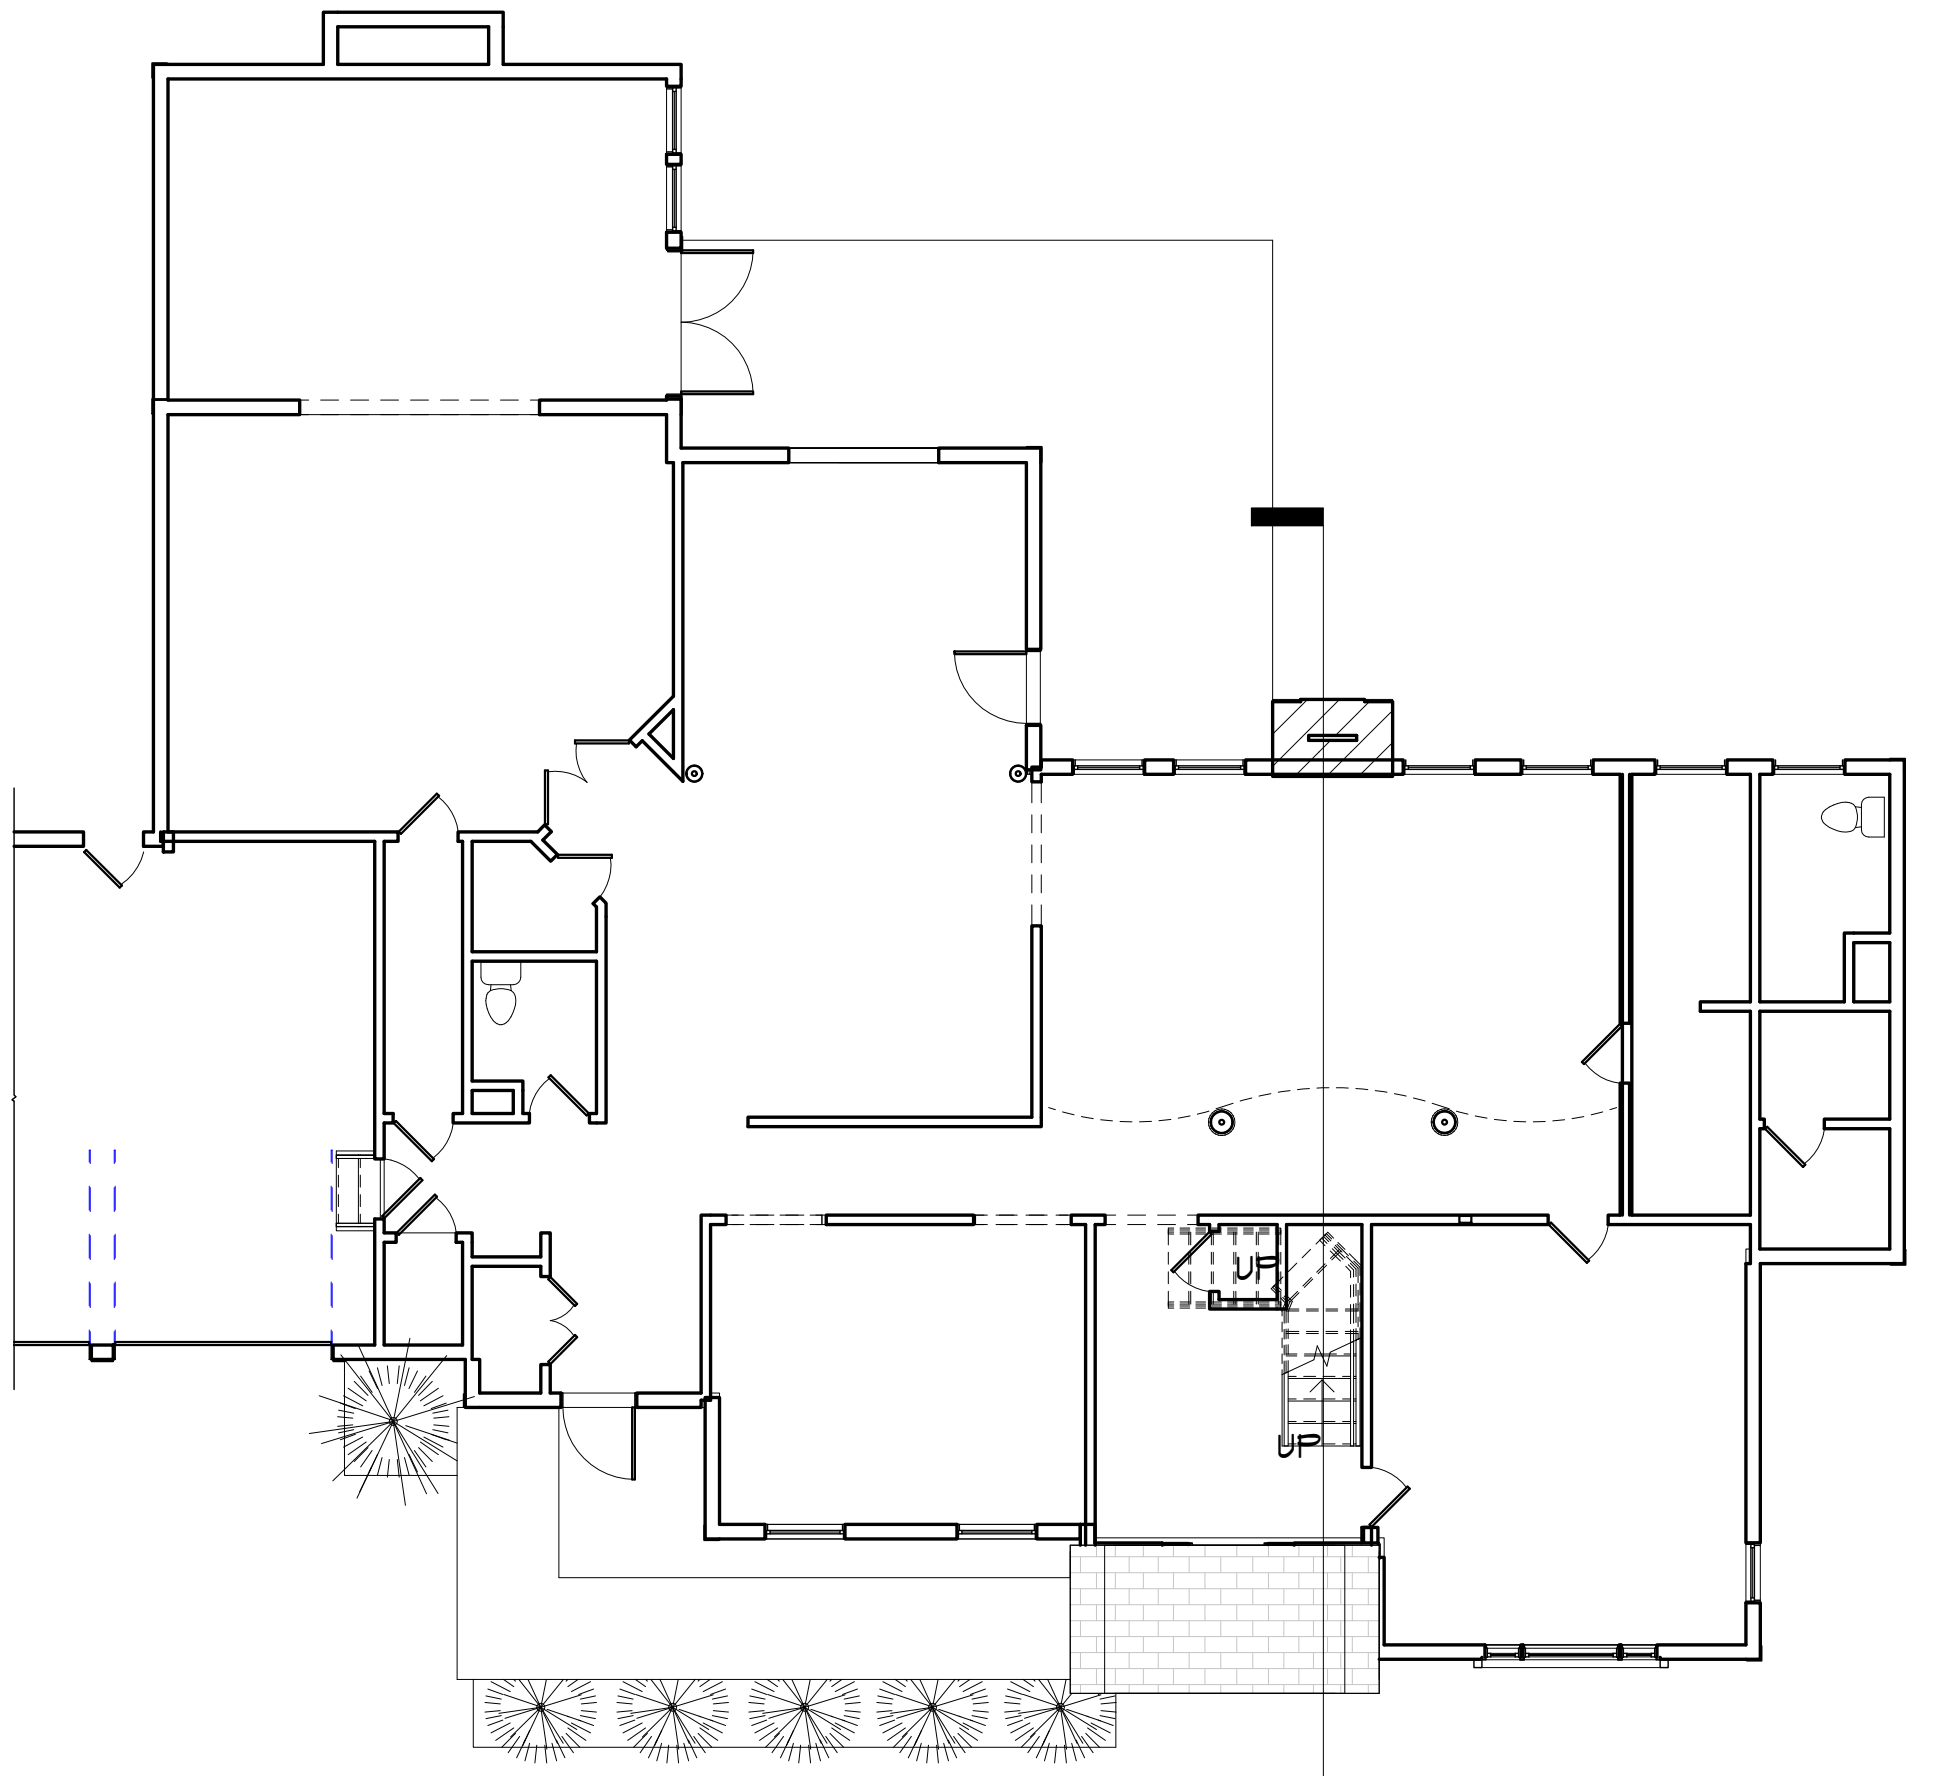


2 Proposed First Floor Plan
1/8" = 1'-0"

NOTE: See Structural and Mechanical drawings to verify locations of patching where access was required for new pipes, beams or ductwork.

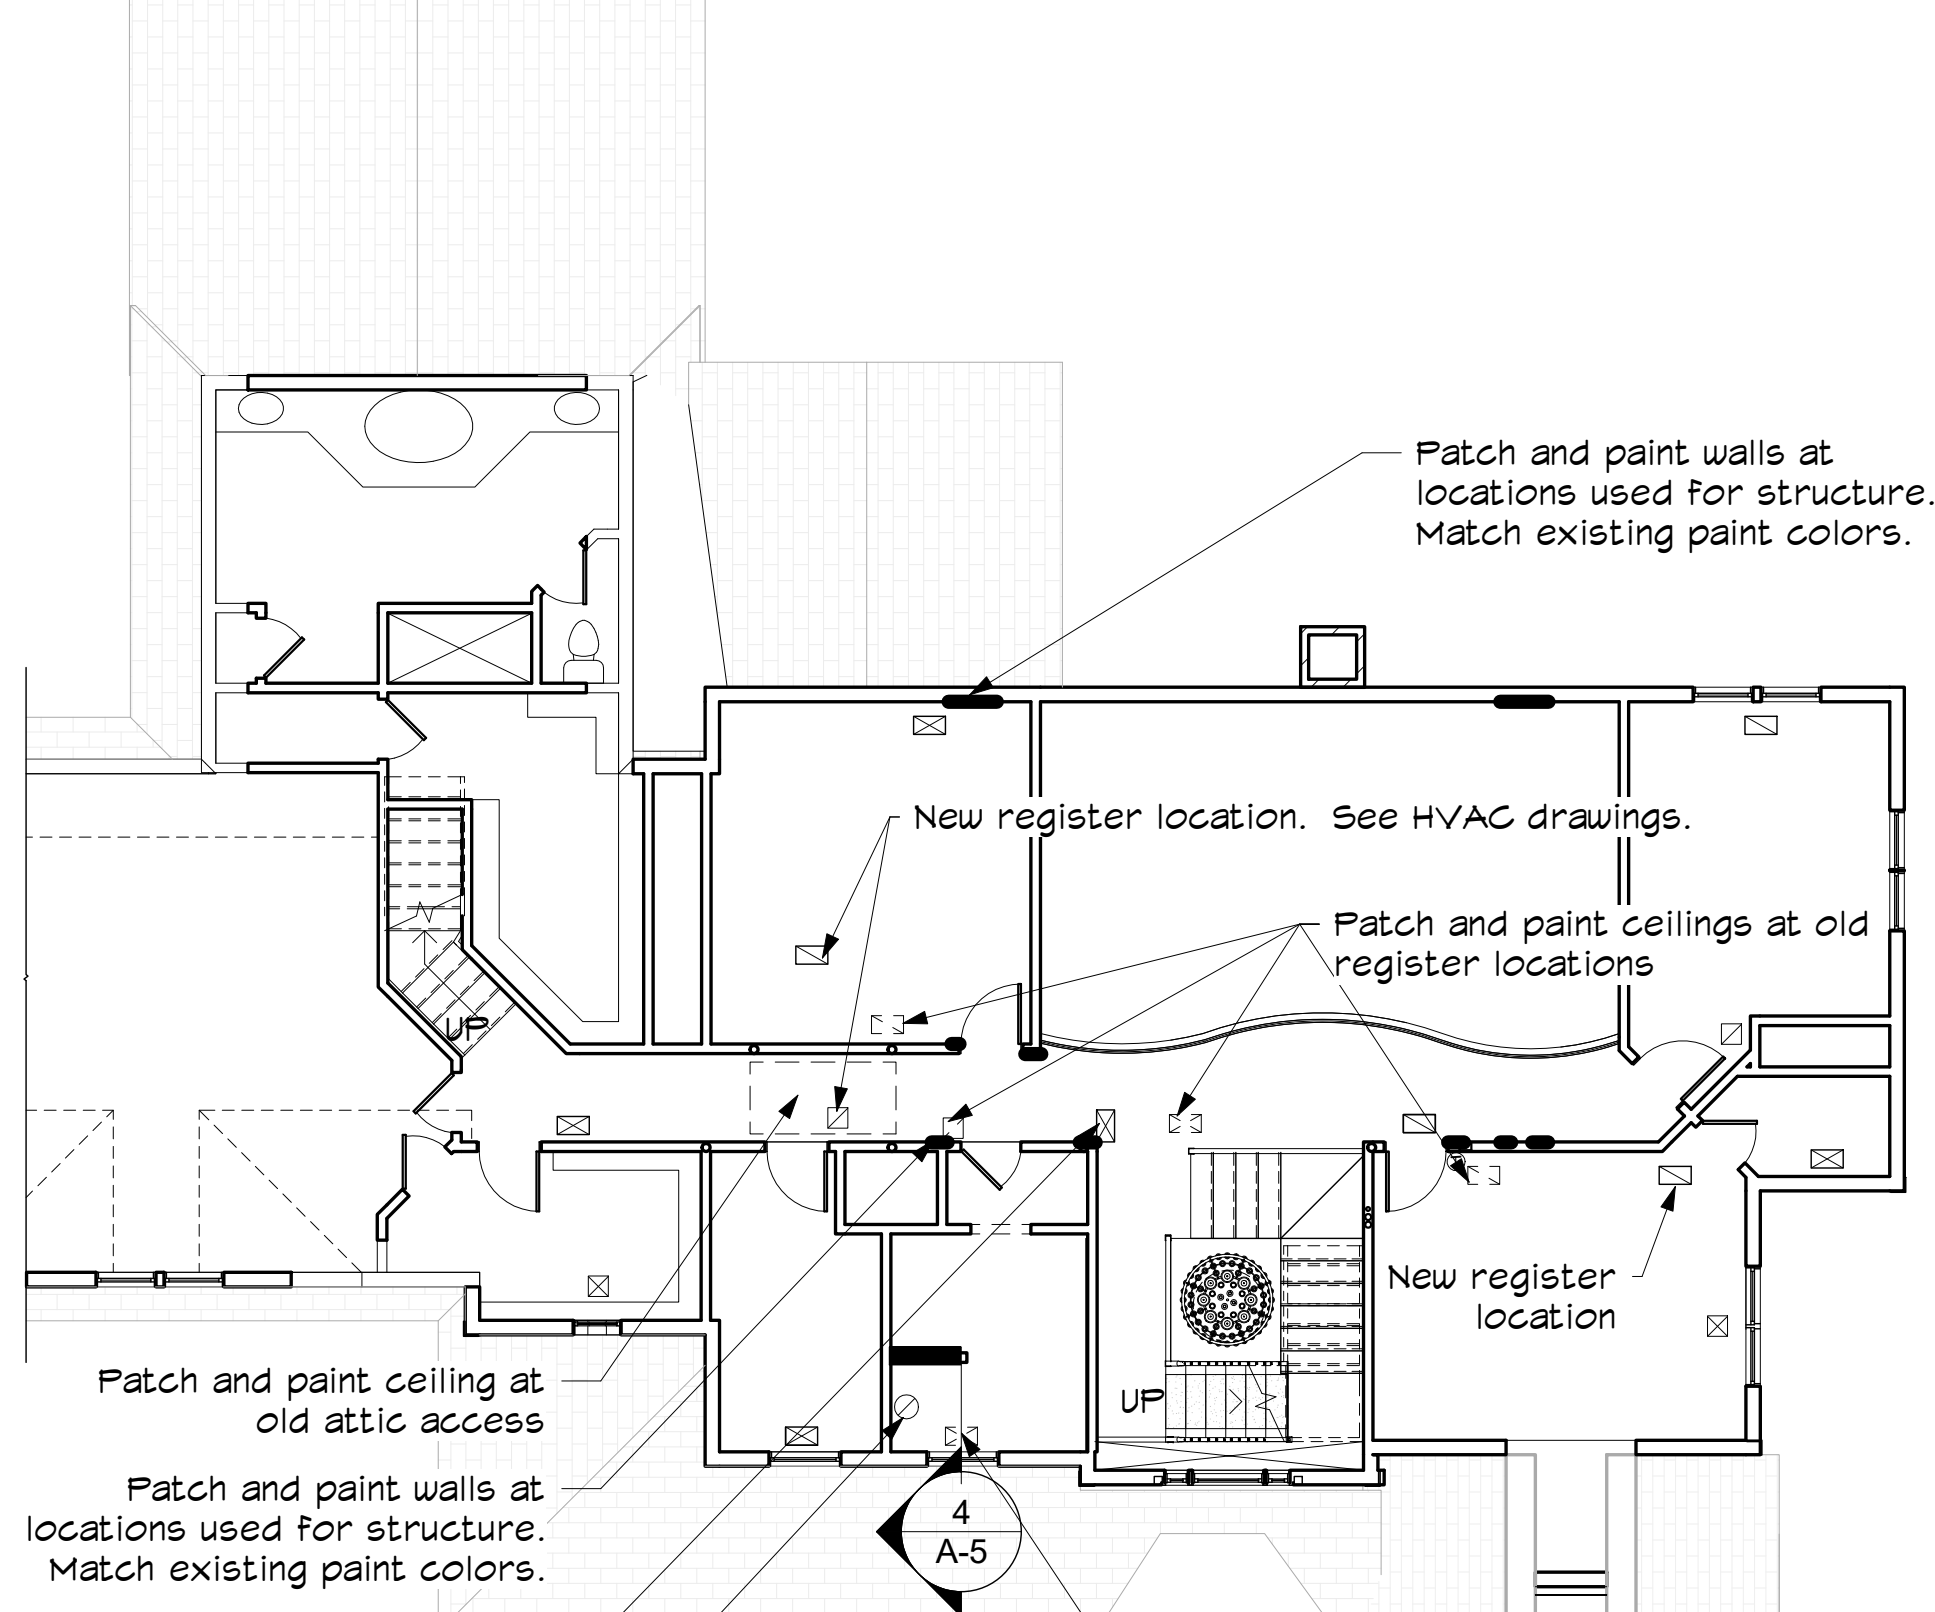

3 Proposed Second Floor Plan
1/8" = 1'-0"

NOTE: See Mechanical drawings to verify relocated registers. Exact locations may depend on joist locations.

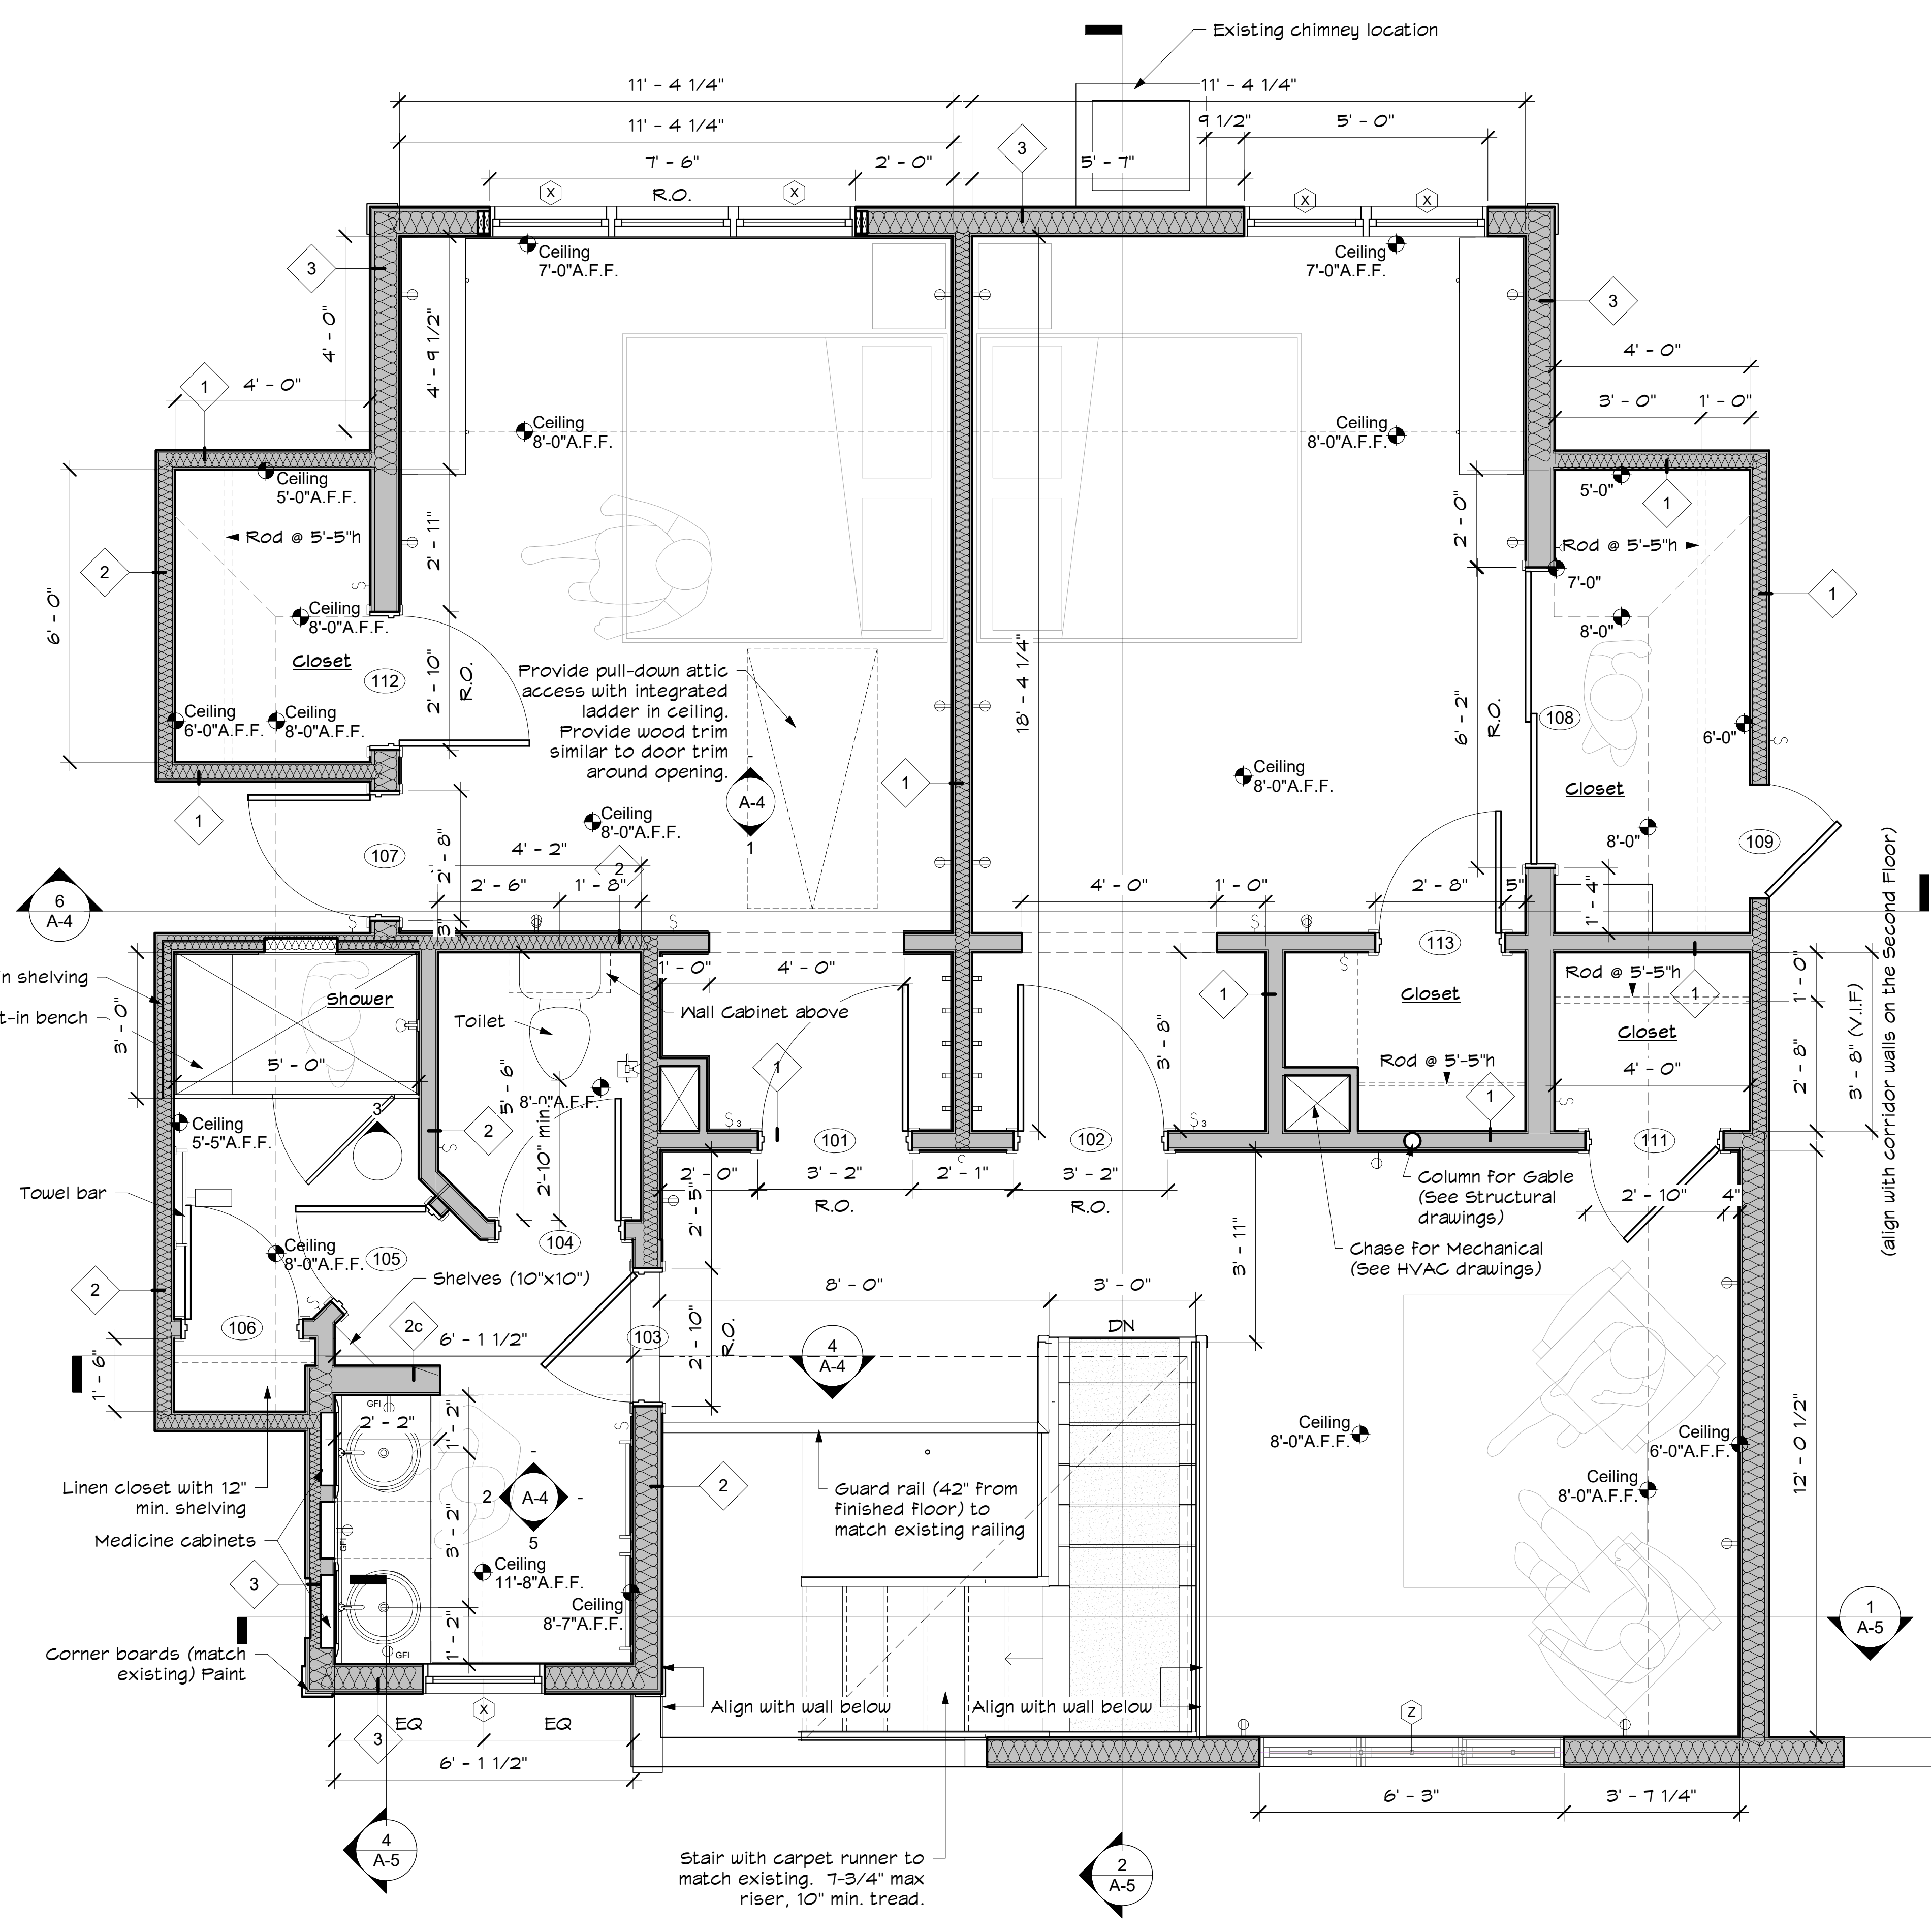

1 Proposed Attic Bedroom Detail Plan
1/2" = 1'-0"

Stair with carpet runner to match existing. 7-3/4" max riser, 10" min. tread.

(align with corridor walls on the Second Floor)



**GIENAPP
DESIGN**
ARCHITECTURE

20 Conant Street
Danvers, MA 01923
978.750.9062
gienappdesign.com

Werth Residence
Renovation
10 Cardinal Drive, Westwood, MA

Plot Date: 1/16/2017 10:05:23 AM

© 2017 Gienapp Design Associates, LLC
ALL RIGHTS RESERVED. ALL IDEAS, DESIGNS, PLANS
AND SPECIFICATIONS ARE THE PROPERTY OF
GIENAPP DESIGN ASSOCIATES. RIGHTS OF USE ARE
CONDITIONAL AND ARE LIMITED TO A ONE-TIME USE
TO CONSTRUCT A SINGLE PROJECT ON THE SITE SO
INDICATED. USE OF THE WORK AND ANY DERIVATIVE
WORK COVERED UNDER THIS COPYRIGHT FOR
OTHER PROJECTS IS PROHIBITED. THE USE OR
REPRODUCTION OF THESE PLANS FOR ANY OTHER
CONSTRUCTION OR PERMIT APPLICATION IS STRICTLY
PROHIBITED WITHOUT PRIOR WRITTEN PERMISSION
OF GIENAPP DESIGN ASSOCIATES AND THE
ARCHITECT WHOSE SIGNATURE AND SEAL MAY BE
AFFIXED TO THESE DRAWINGS.


Revisions	Date

Project: 622.1
Drawn by: JB
Check by: IB
Date: 01/13/17
Scale: As indicated



**Toilet Room
Details**

A-4


NOTE: All new, finished walls to be painted unless noted otherwise.

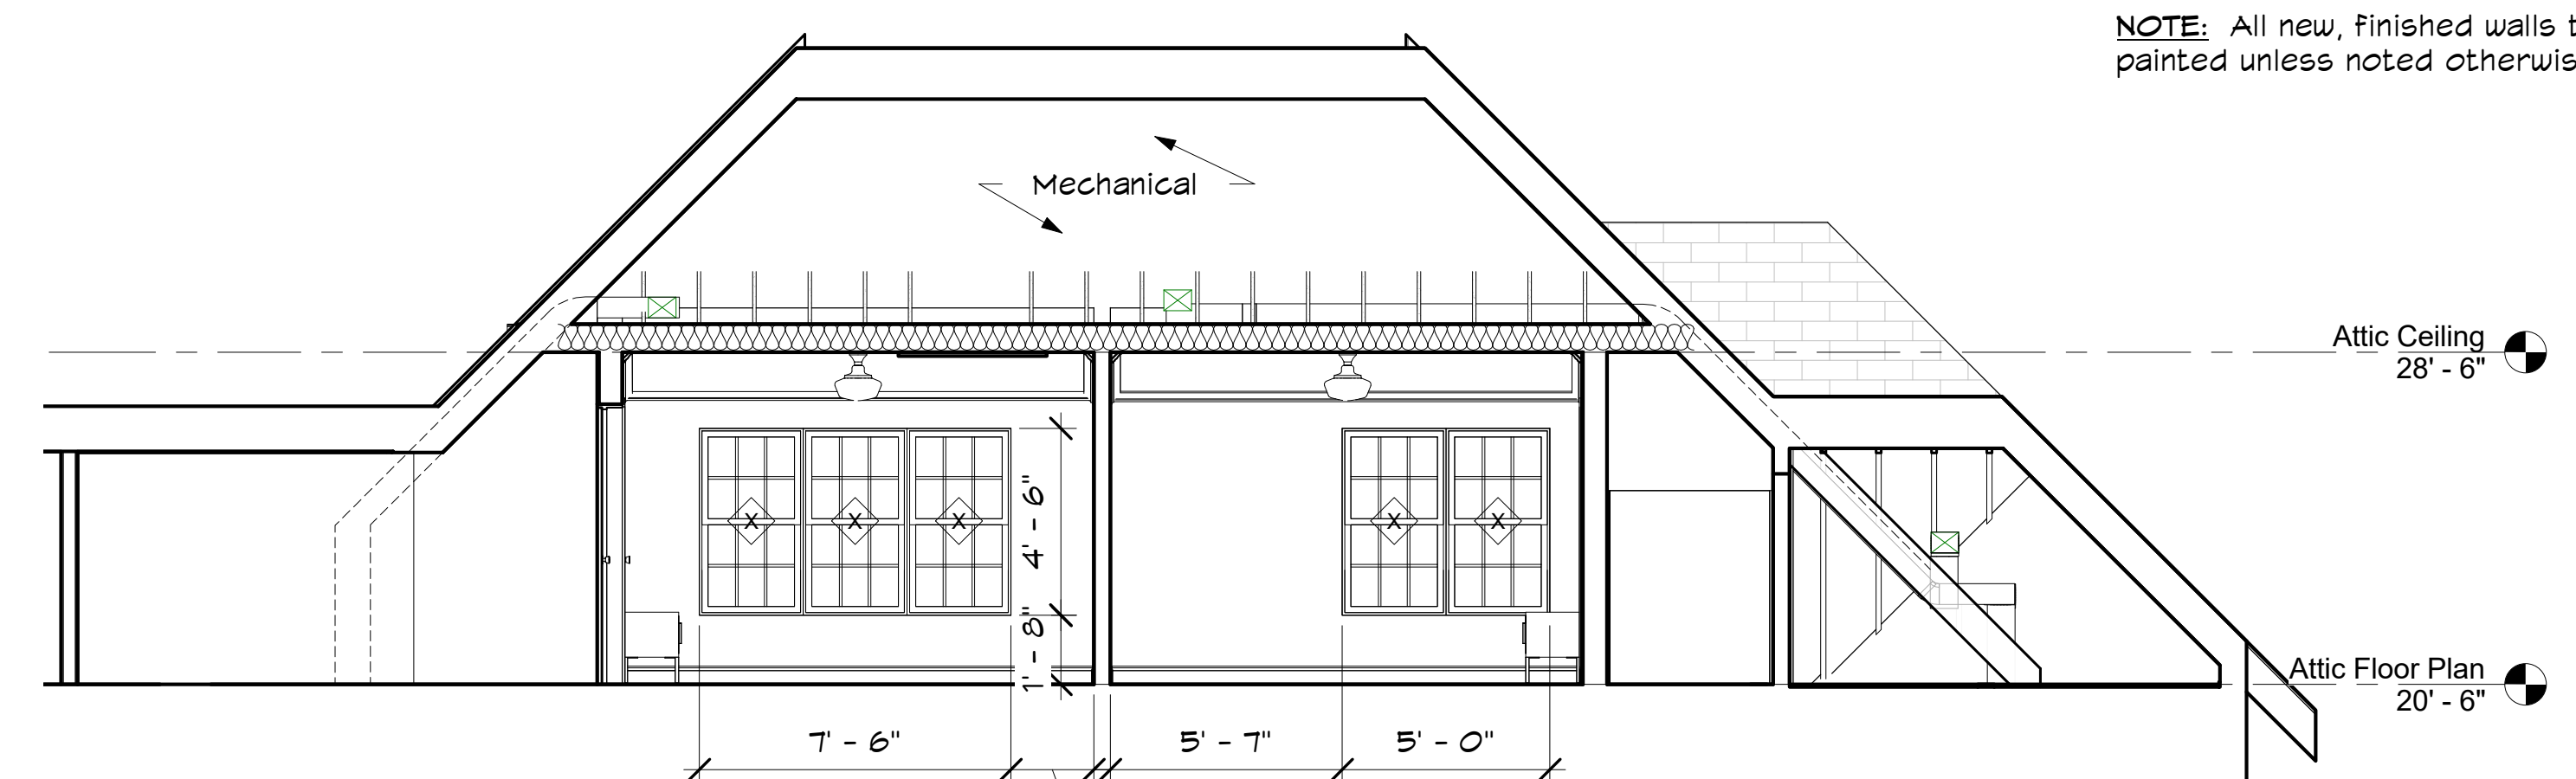


6 Bedroom Window Wall Elevation
1/4" = 1'-0"

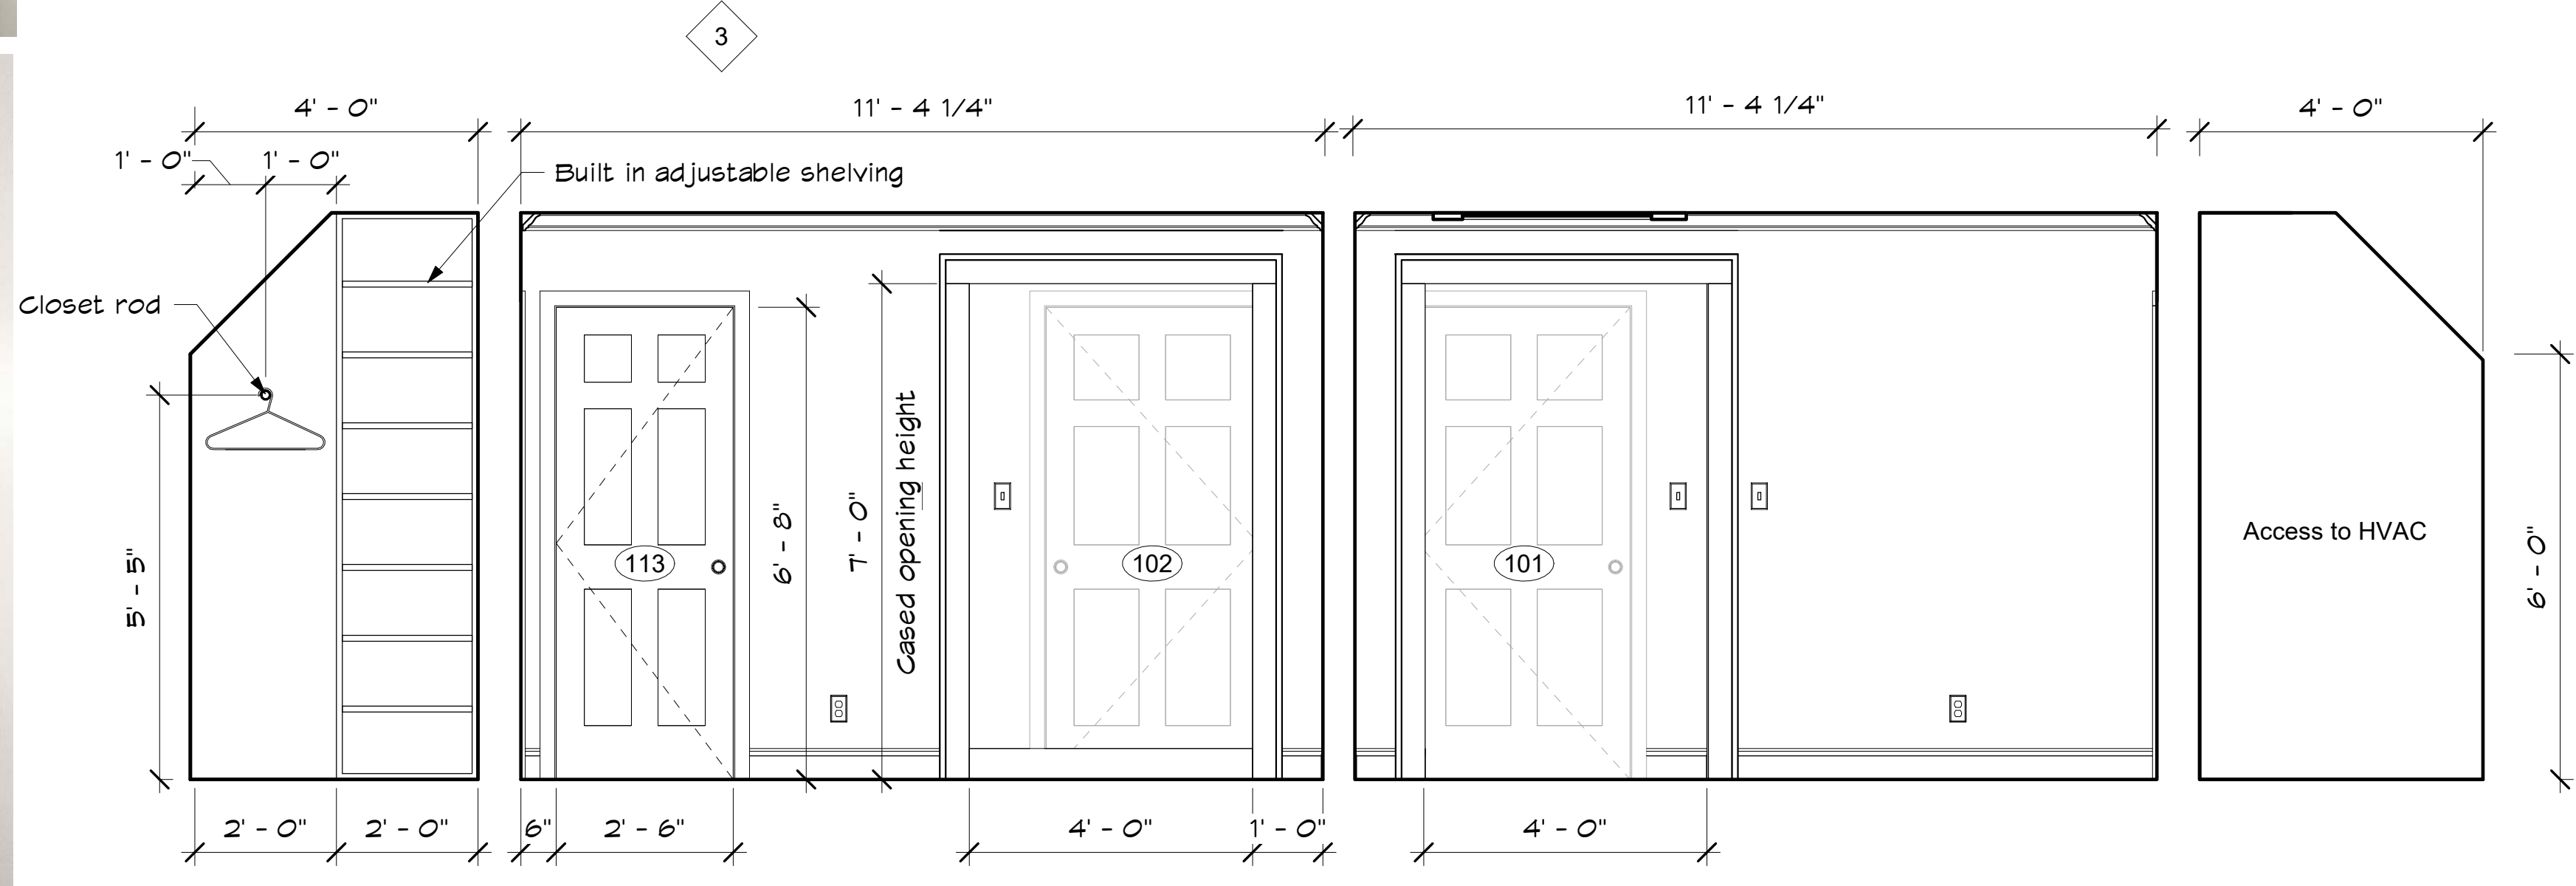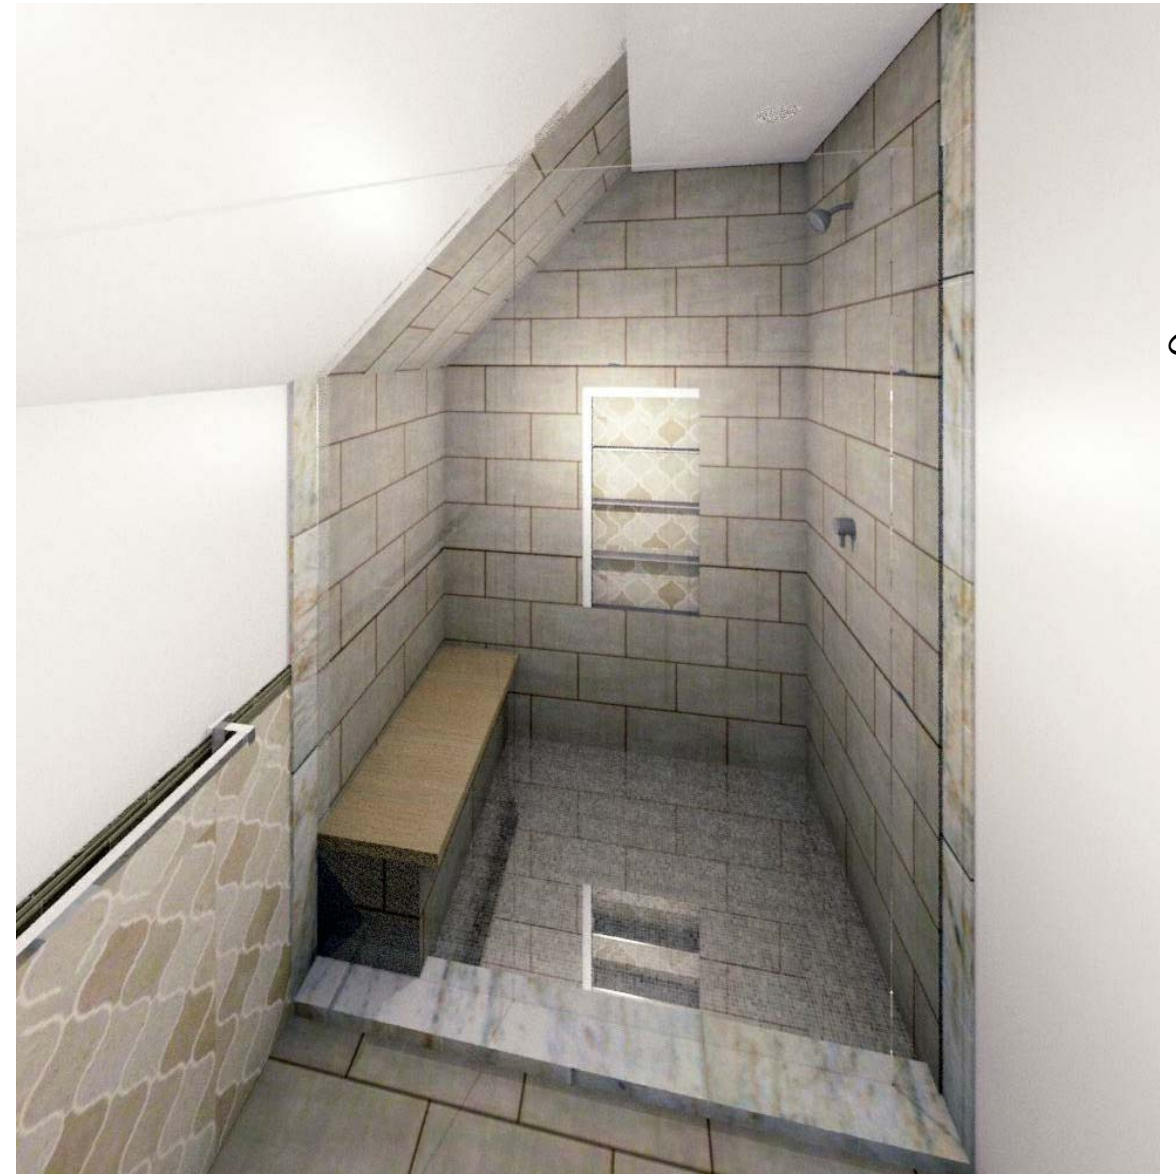


1 Bedroom Elevation
1/2" = 1'-0"

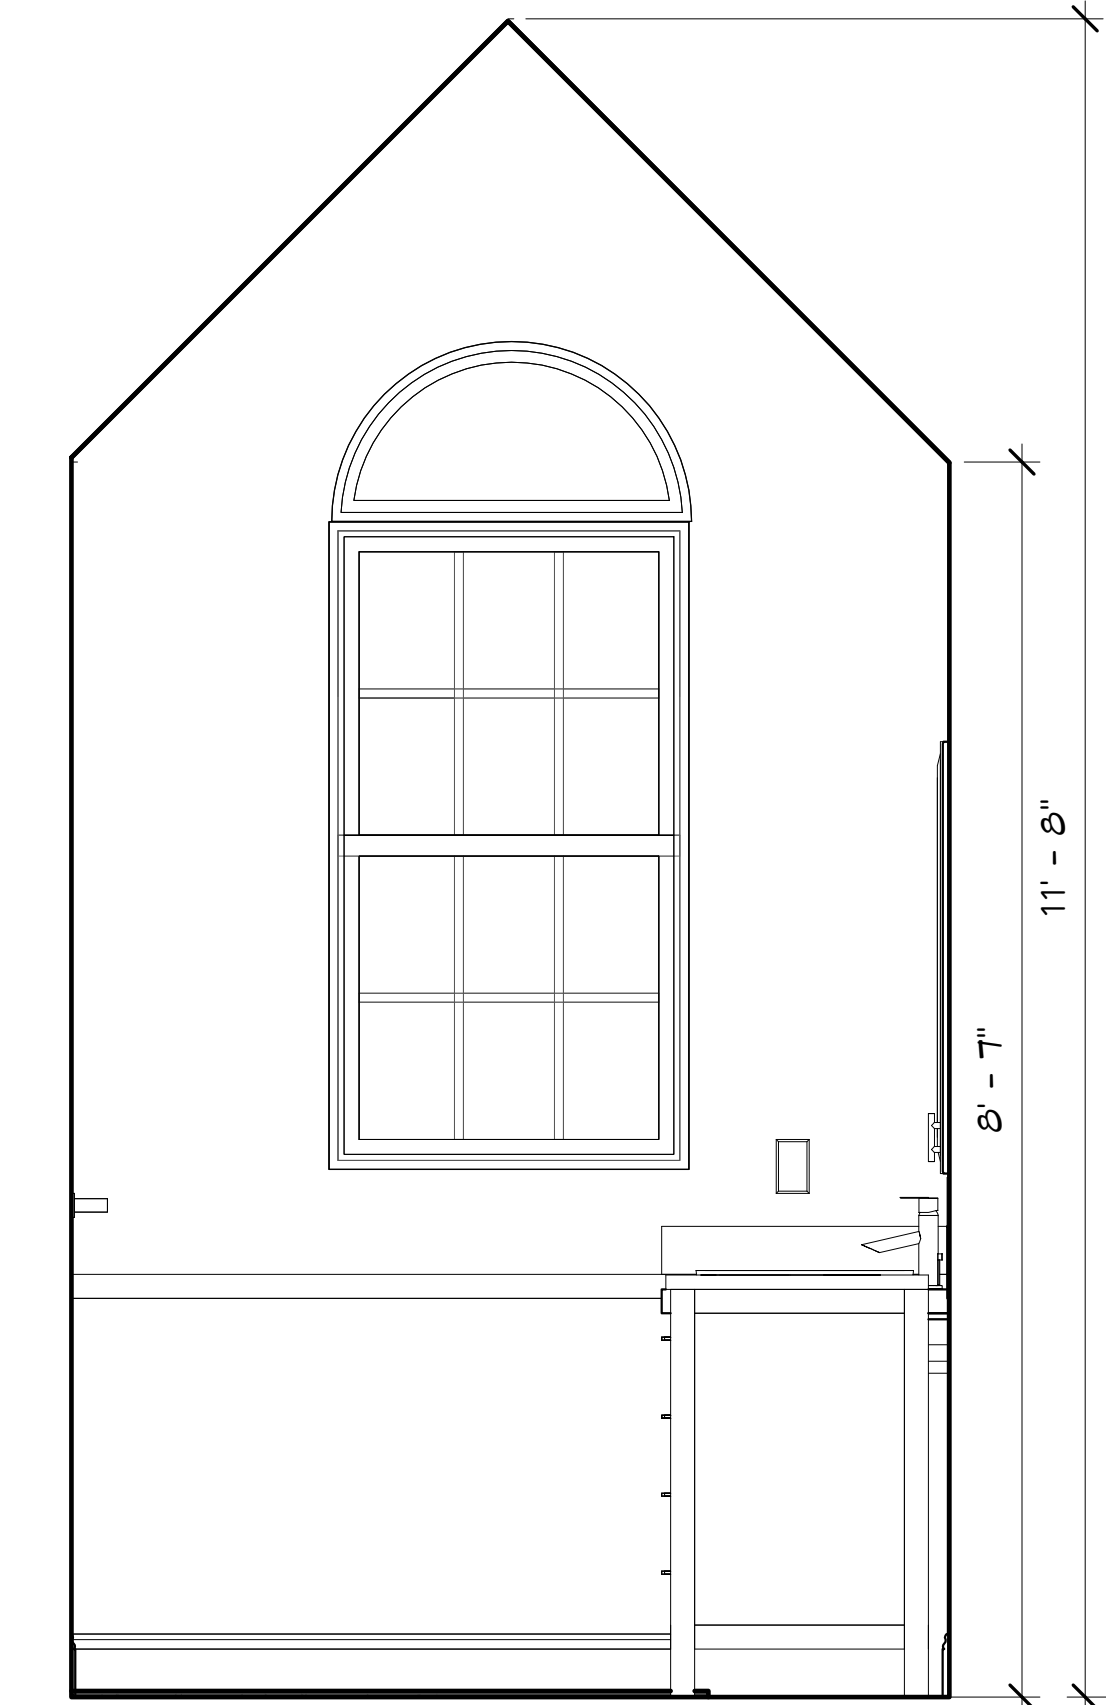


5 Bathroom Window Wall Elevation
3/4" = 1'-0"

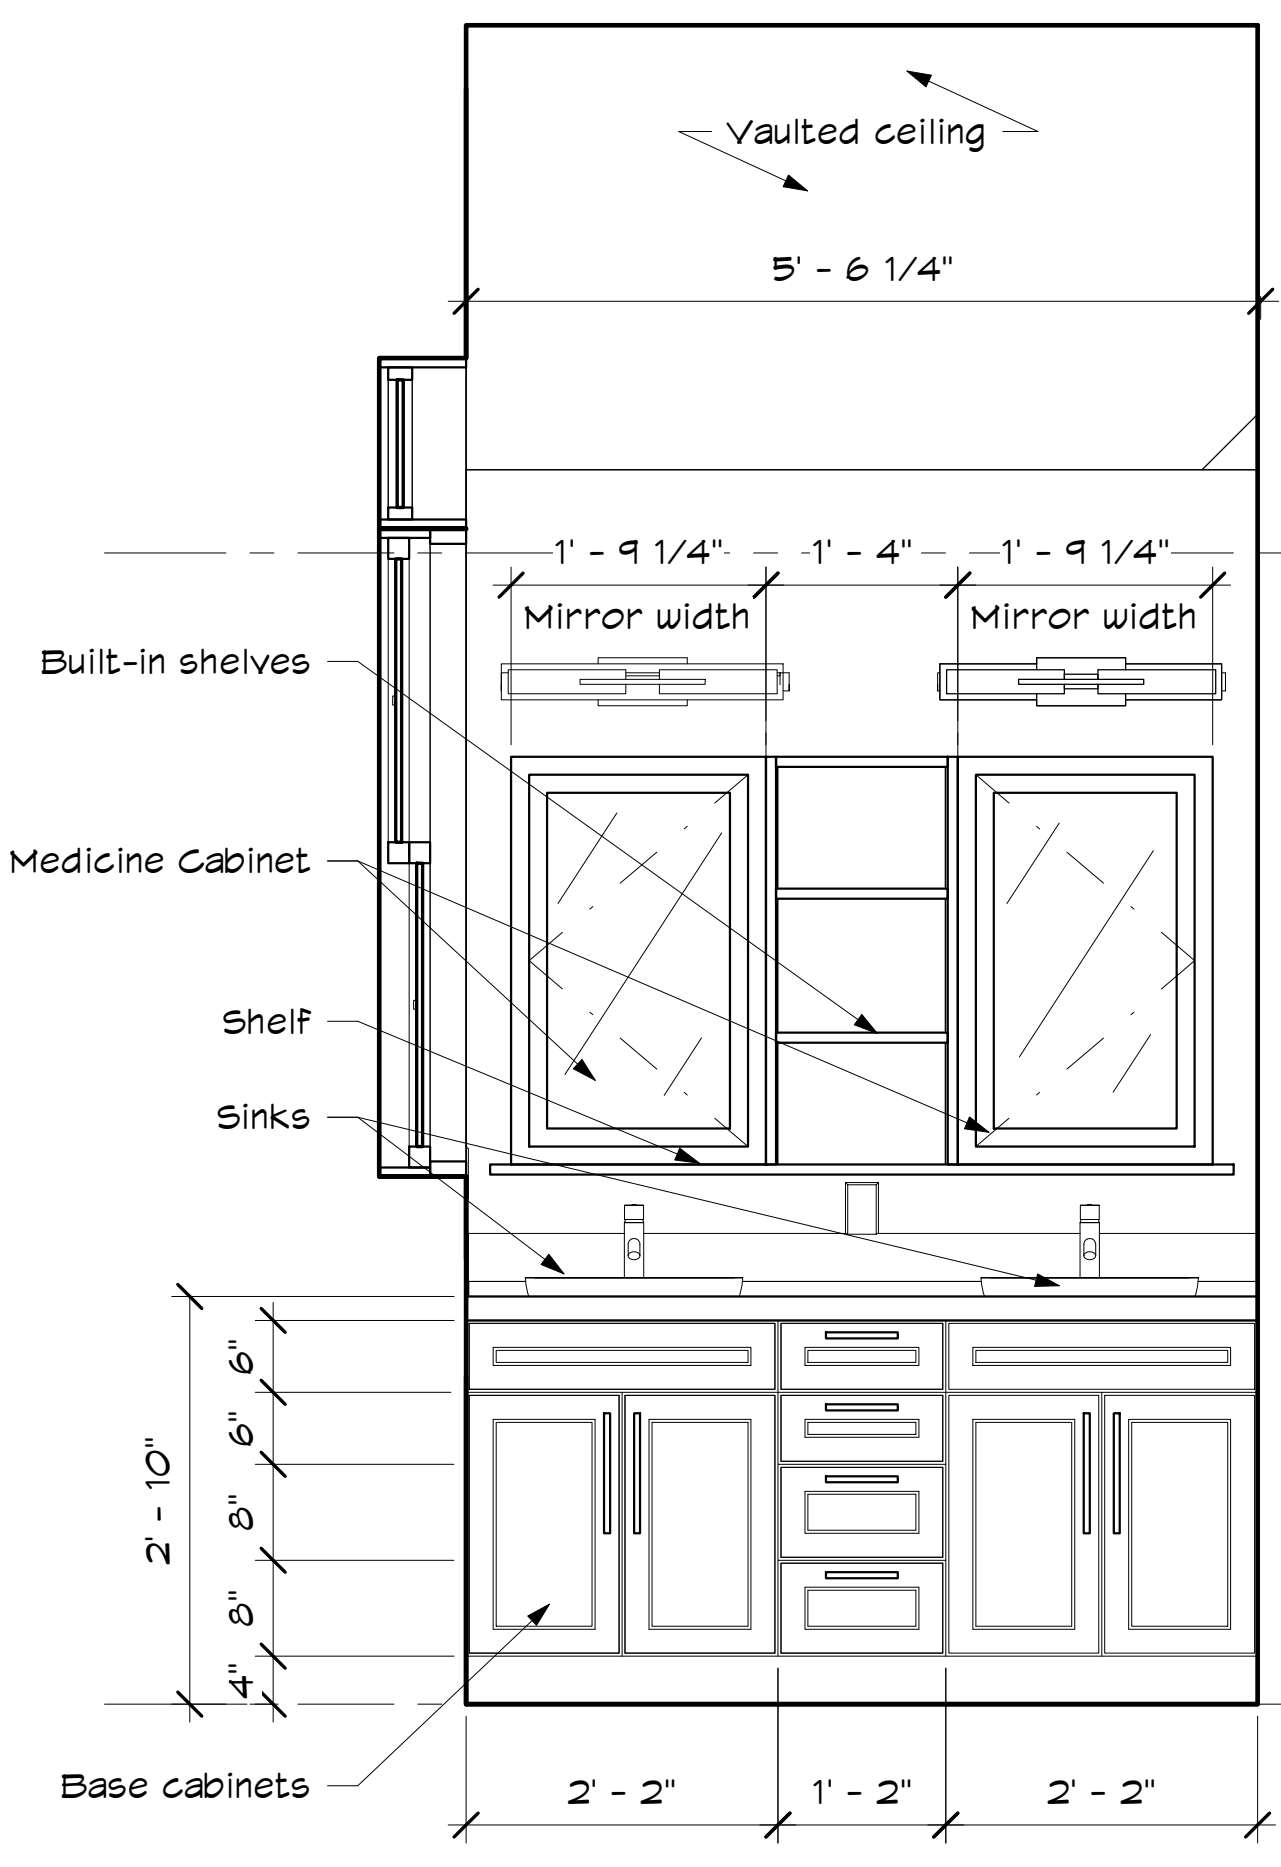

2 Bathroom Vanity Elevation
3/4" = 1'-0"

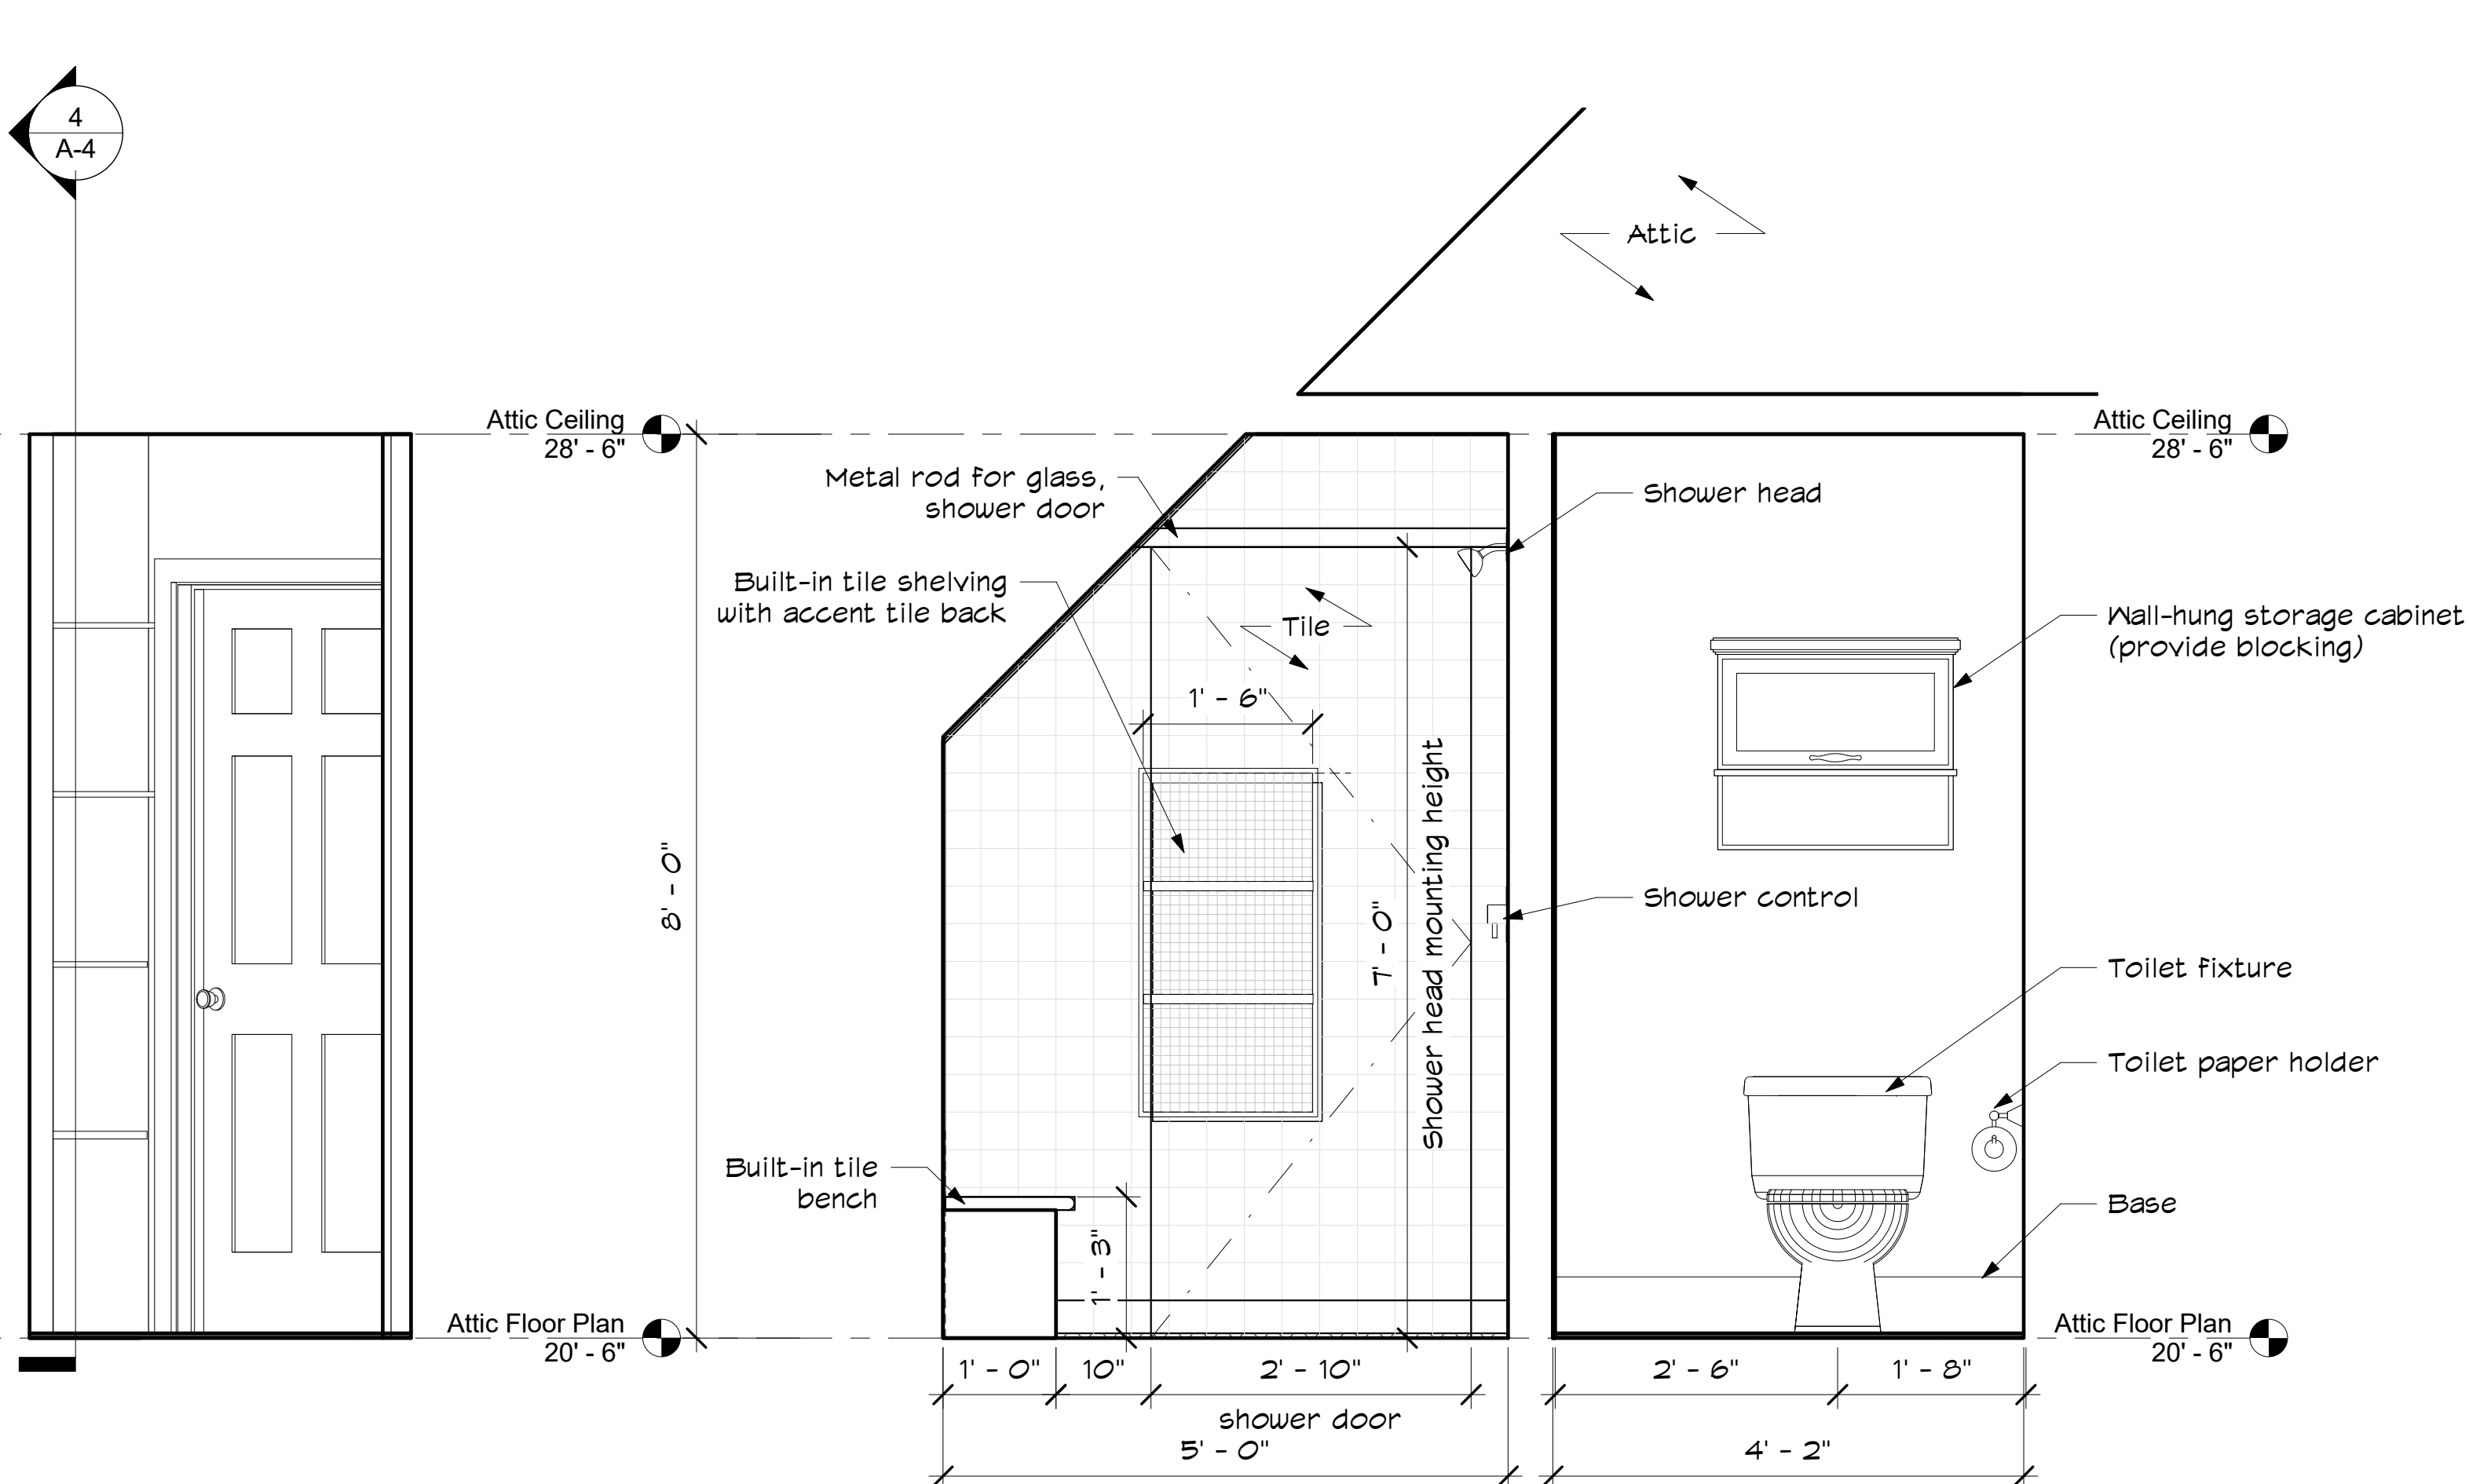

3 Toilet and Shower Room Elevation
3/4" = 1'-0"

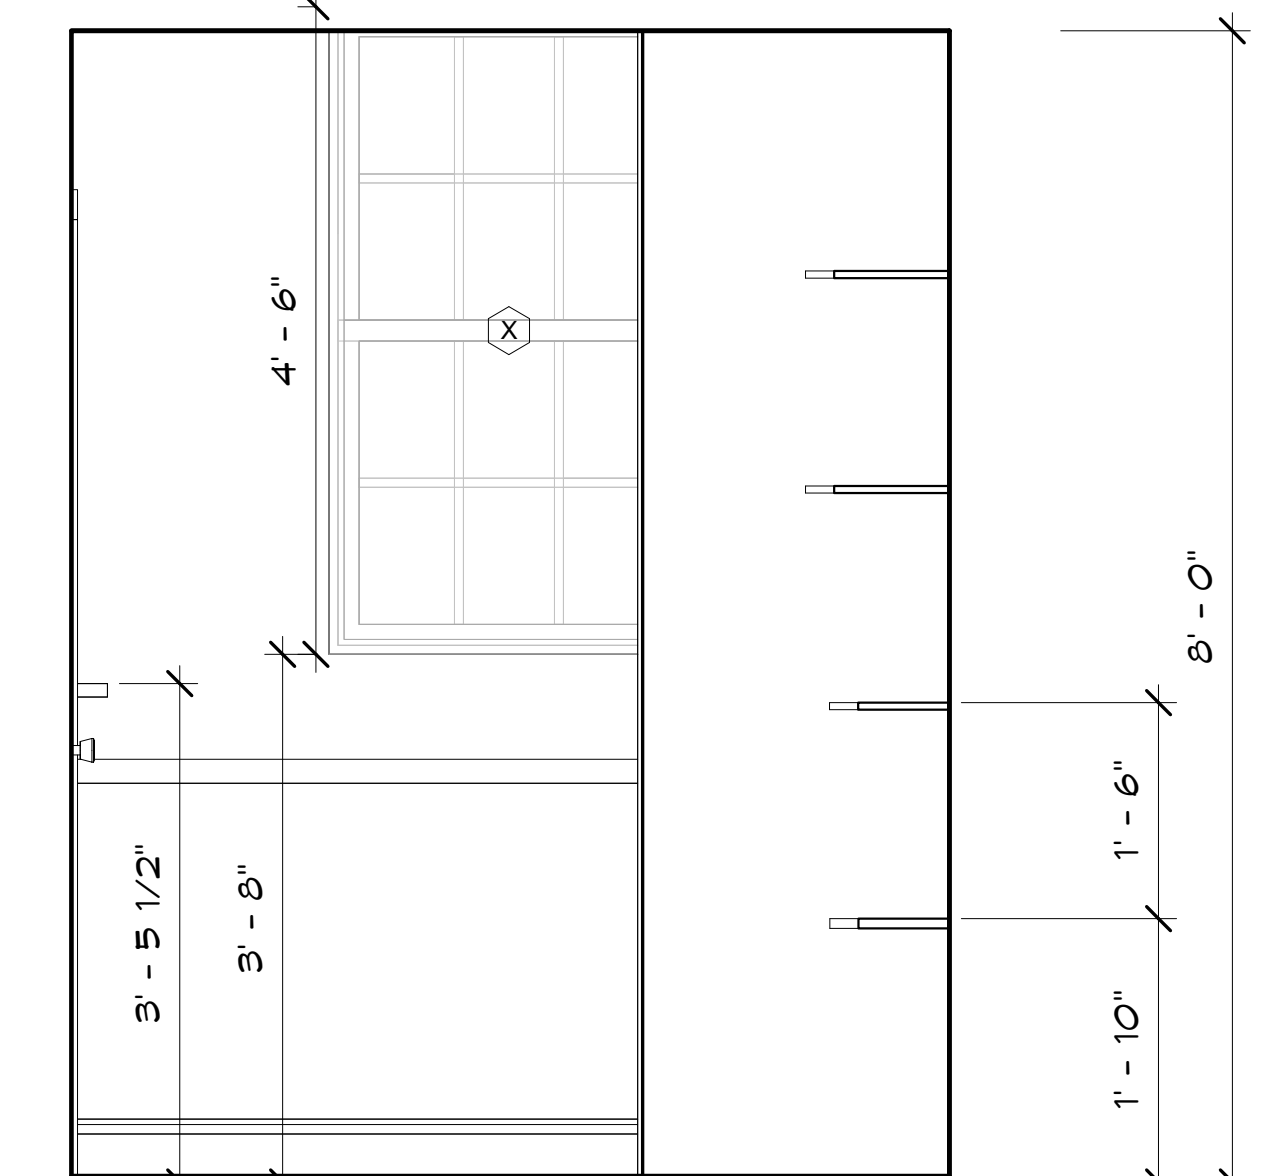

4 Toilet Room Shelving
3/4" = 1'-0"

SCALE 1"=1'-0" 3/4"=1'-0" 1-1/2"=1'-0" 1"=1'-0" 1/2"=1'-0" 1/4"=1'-0" 1/8"=1'-0"

Plot Date: 1/16/2017 10:05:23 AM



**GIENAPP
DESIGN**
ARCHITECTURE

20 Conant Street
Danvers, MA 01923
978.750.9062
gienappdesign.com

Werth Residence
Renovation
10 Cardinal Drive, Westwood, MA

Plot Date: 1/16/2017 10:05:26 AM


© 2017 Gienapp Design Associates, LLC
ALL RIGHTS RESERVED. ALL IDEAS, DESIGNS, PLANS
AND SPECIFICATIONS ARE THE PROPERTY OF
GIENAPP DESIGN ASSOCIATES. RIGHTS OF USE ARE
CONDITIONAL AND ARE LIMITED TO A ONE-TIME USE
TO CONSTRUCT A SINGLE PROJECT ON THE SITE SO
INDICATED. USE OF THE WORK AND ANY DERIVATIVE
WORK COVERED UNDER THIS COPYRIGHT FOR
OTHER PROJECTS IS PROHIBITED. THE USE OR
REPRODUCTION OF THESE PLANS FOR ANY OTHER
CONSTRUCTION OR PERMIT APPLICATION IS STRICTLY
PROHIBITED WITHOUT PRIOR WRITTEN PERMISSION
OF GIENAPP DESIGN ASSOCIATES AND THE
ARCHITECT WHOSE SIGNATURE AND SEAL MAY BE
AFFIXED TO THESE DRAWINGS.

Revisions	Date


Project: 622.1
Drawn by: JB
Check by: JB
Date: 01/13/17
Scale: As indicated

**Building
Section**


A-5

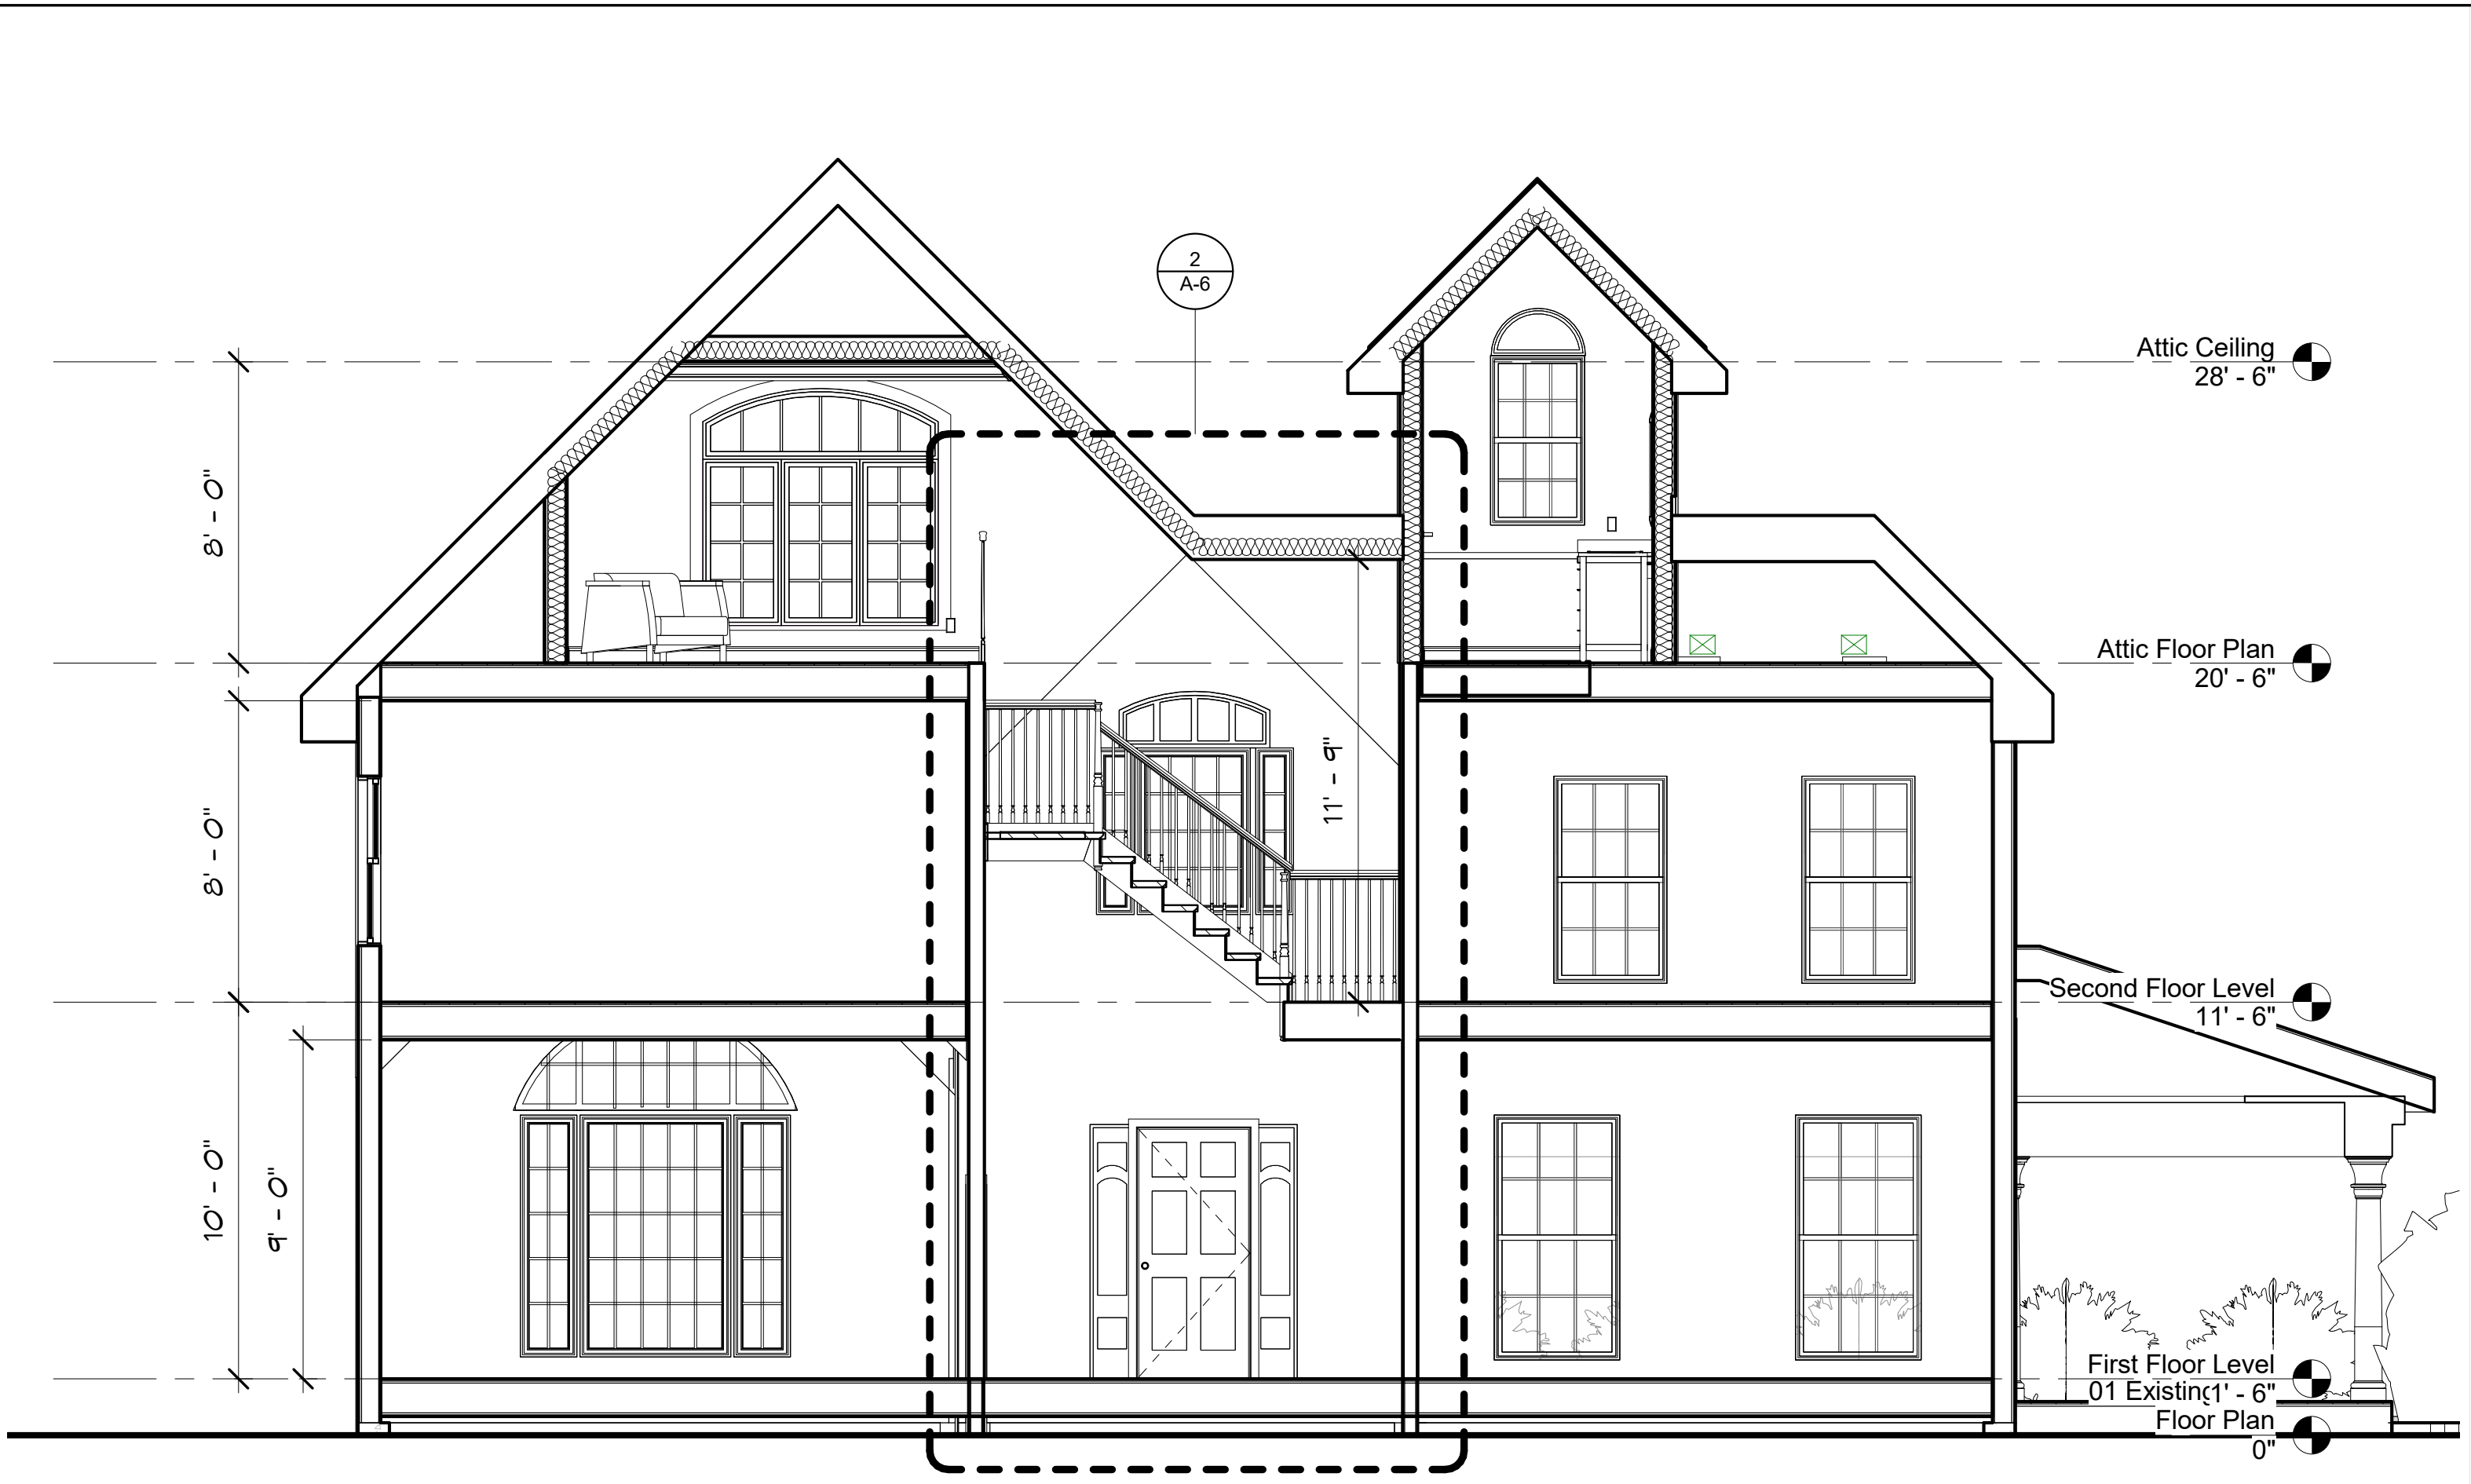


1 Section Facing Front of Building
1/4" = 1'-0"

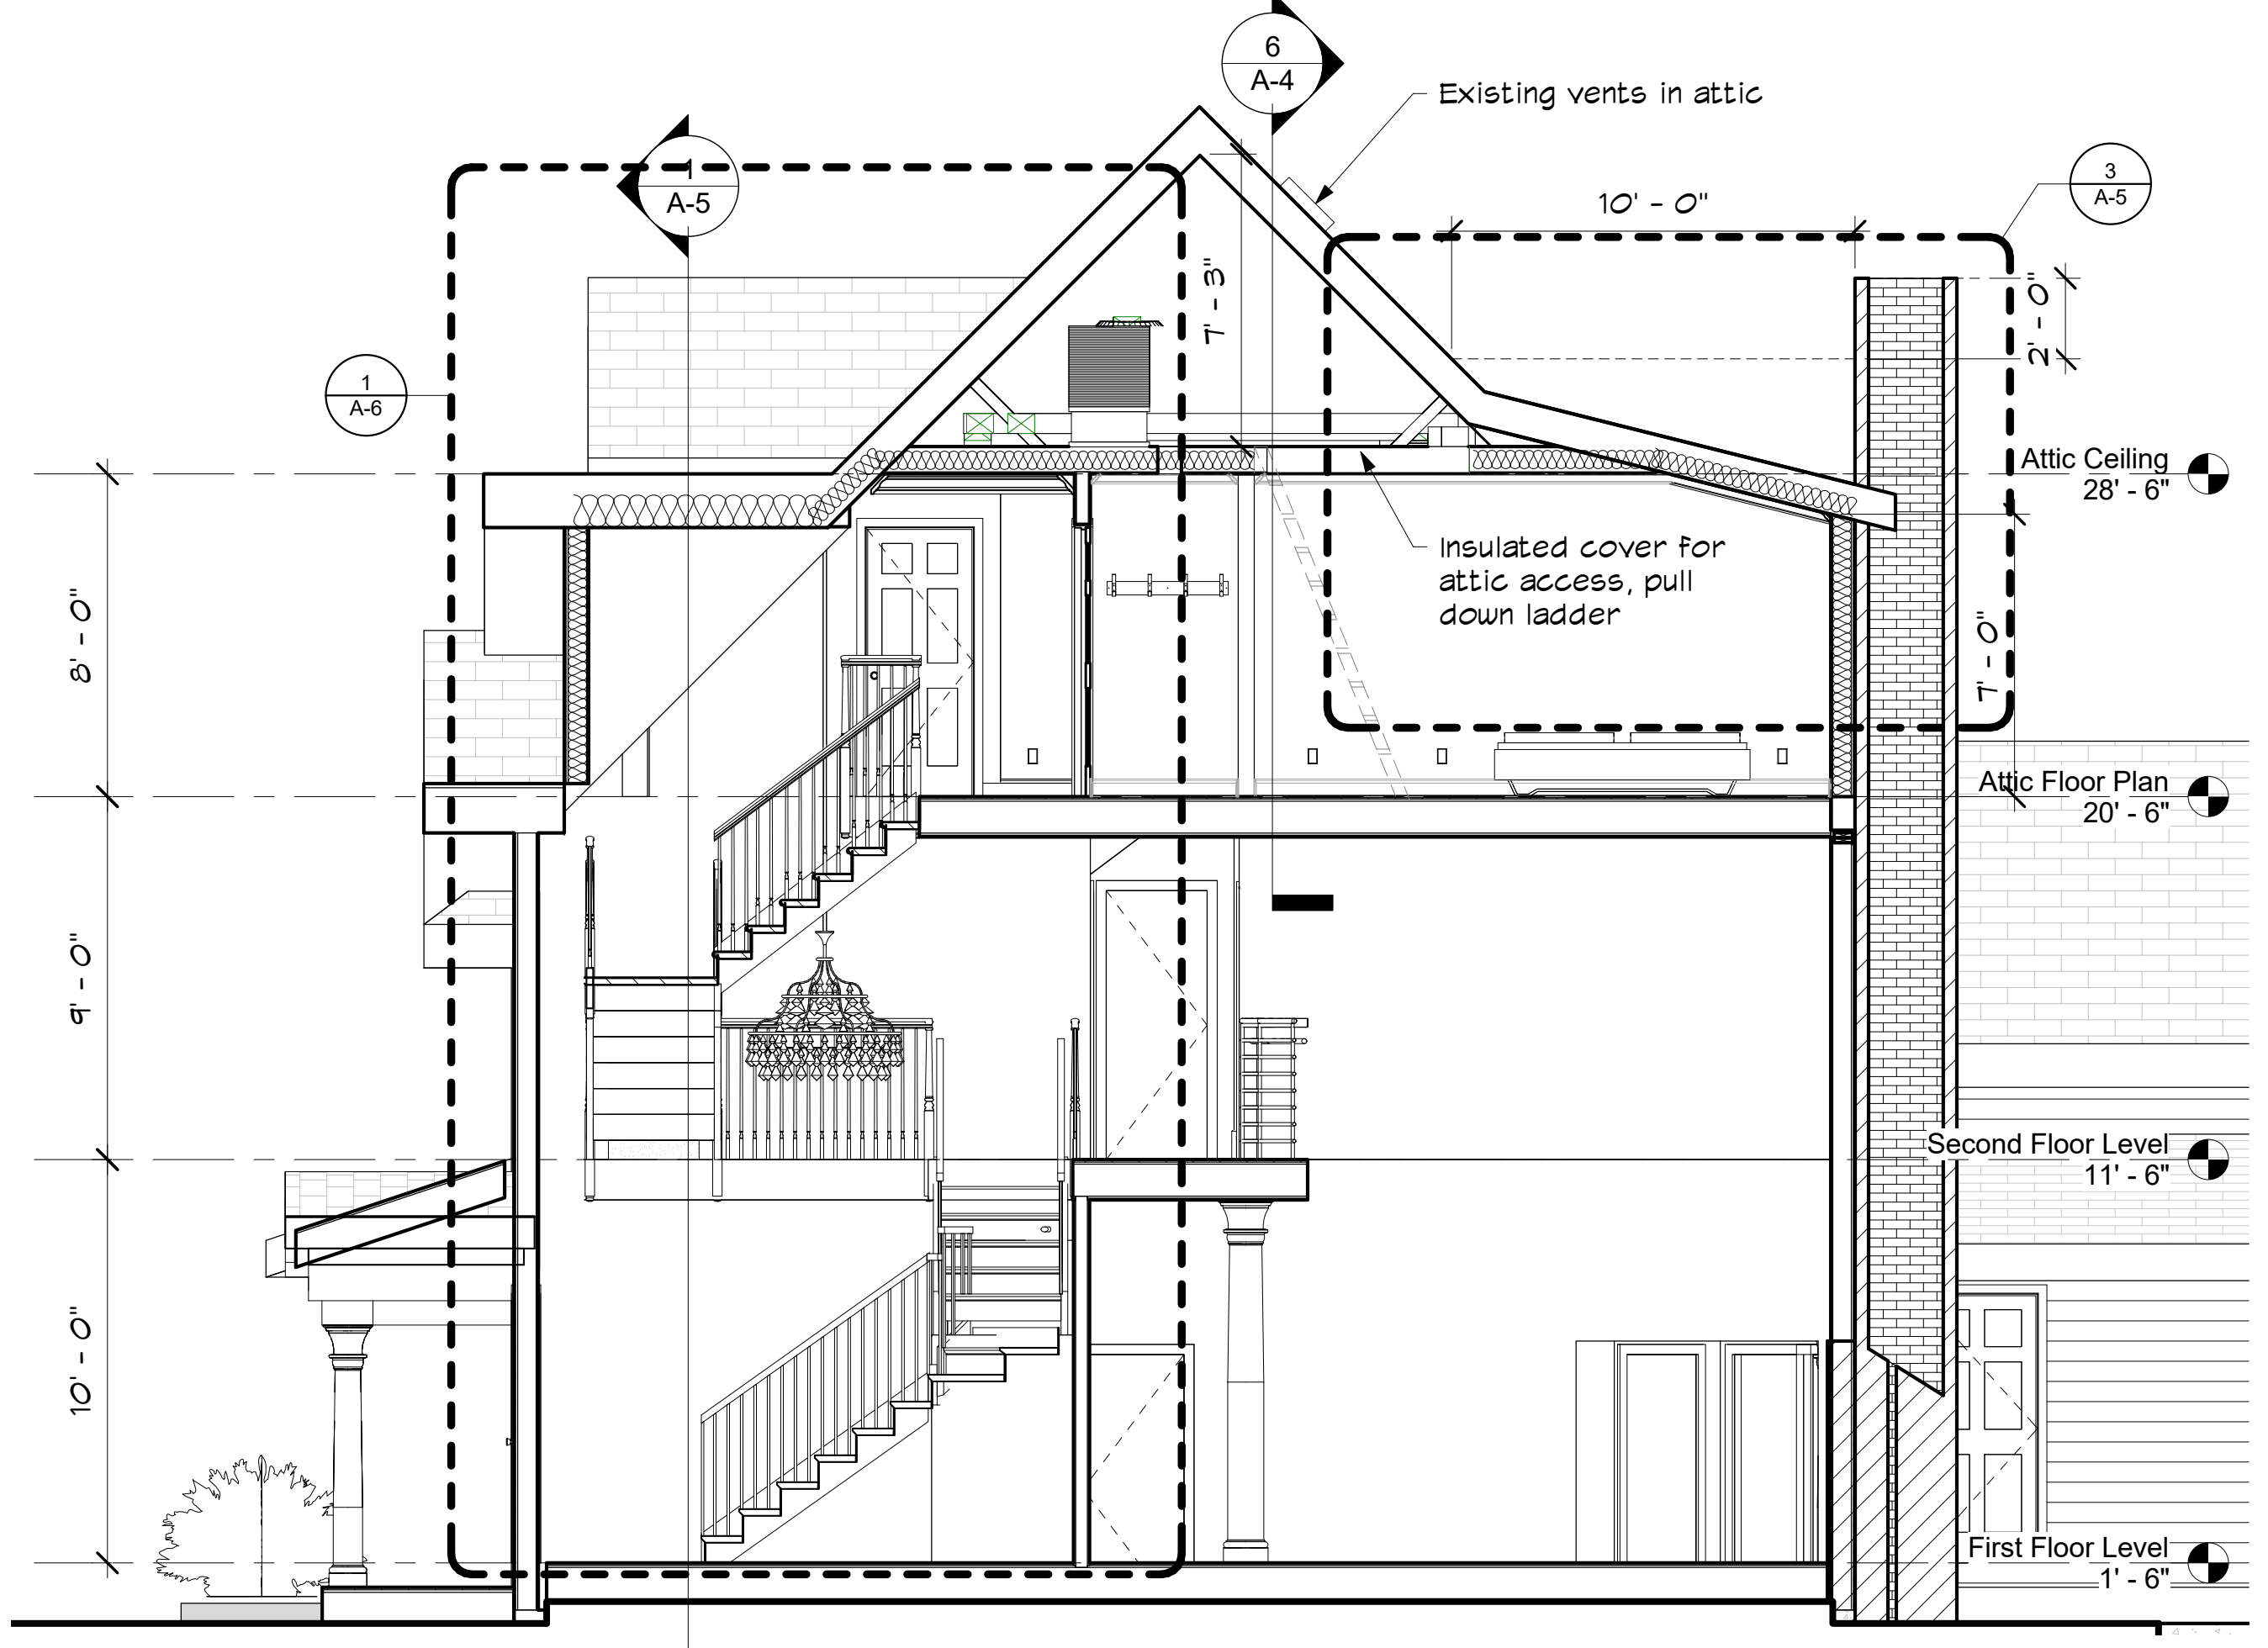

2 Section Through House
1/4" = 1'-0"

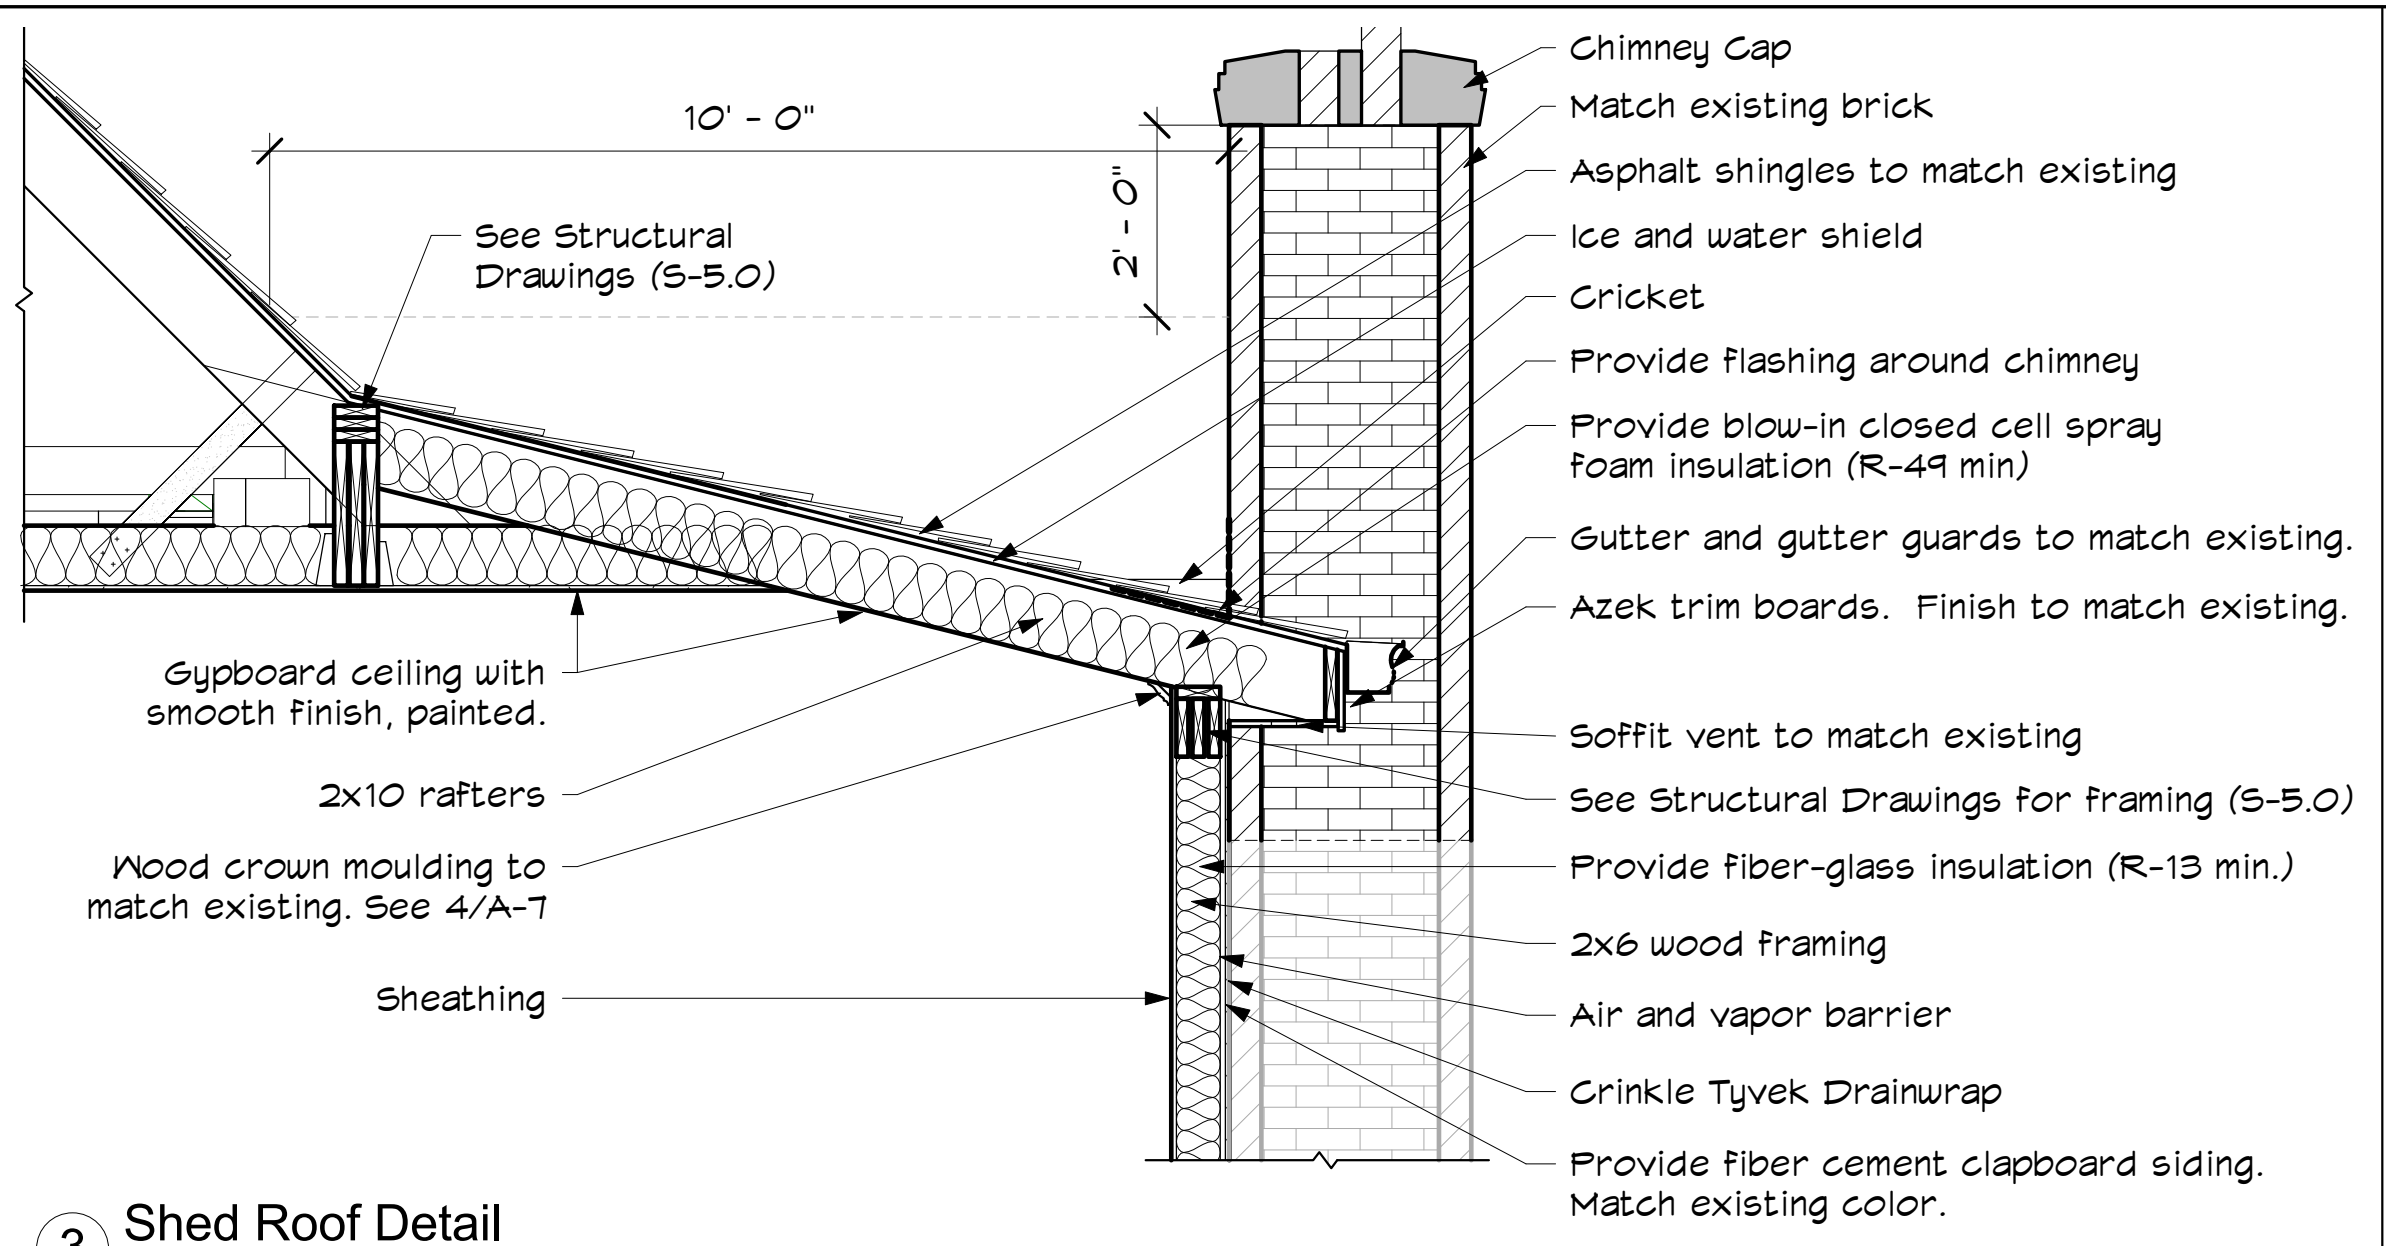

3 Shed Roof Detail
1/2" = 1'-0"

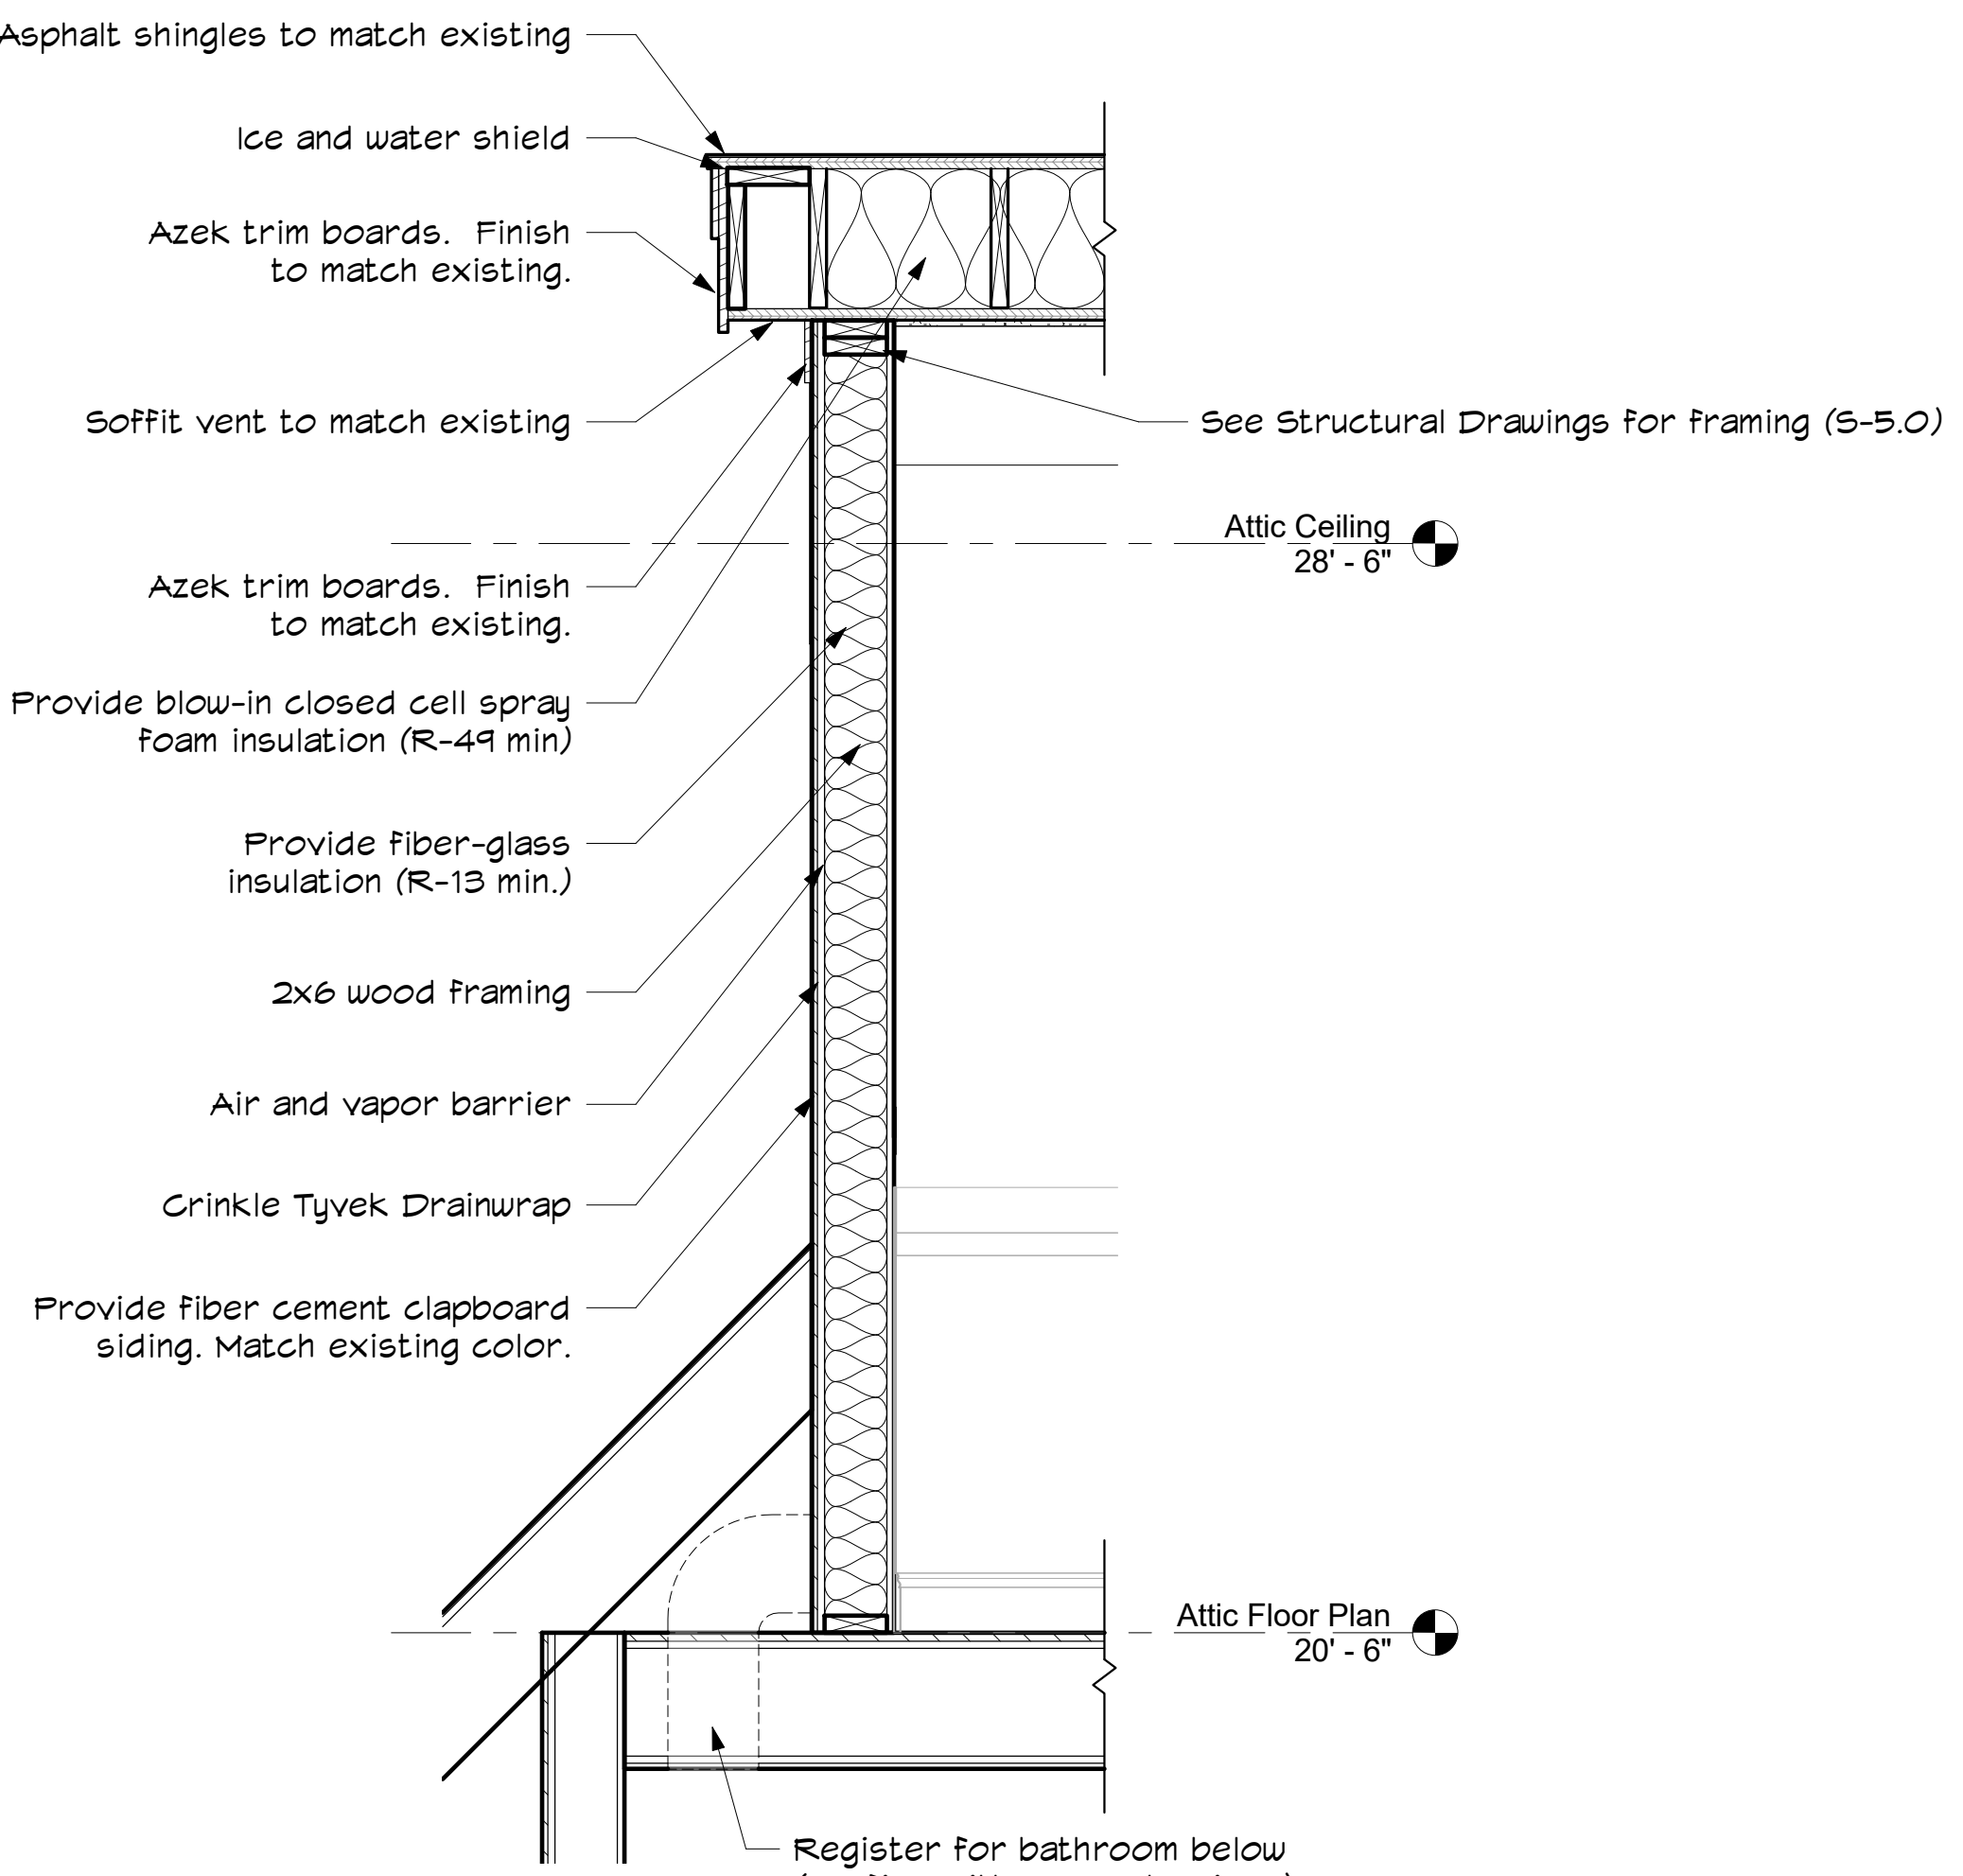

4 Section 7
3/4" = 1'-0"

IF THIS SHEET IS NOT 24 X 36 IT IS A REDUCED SCALE PRINT - SCALE ACCORDINGLY

F:\01 62221 Werth Residence\01 Rev\02 1 DRAWINGS AND SPECIFICATIONS\02 1 Working Set\02 1 Werth Residence_011317.rvt

IF THIS SHEET IS NOT 24 X 36 IT IS A REDUCED SCALE PRINT - SCALE ACCORDINGLY


1
0
2
1
1
0
SCALE
3" = 1'-0"

0
1
2
3
1
1
0
SCALE
1-1/2" = 1'-0"


0
1
2
3
4
5
6
1
1
0
SCALE
1/2" = 1'-0"

0
1
2
3
4
5
6
7
8
9
10
11
12
1
1
0
SCALE
1/4" = 1'-0"


0
5
10
15
20
25
30
35
40
45
50
55
60
65
70
75
80
85
90
95
100
1
1
0
SCALE
1/8" = 1'-0"

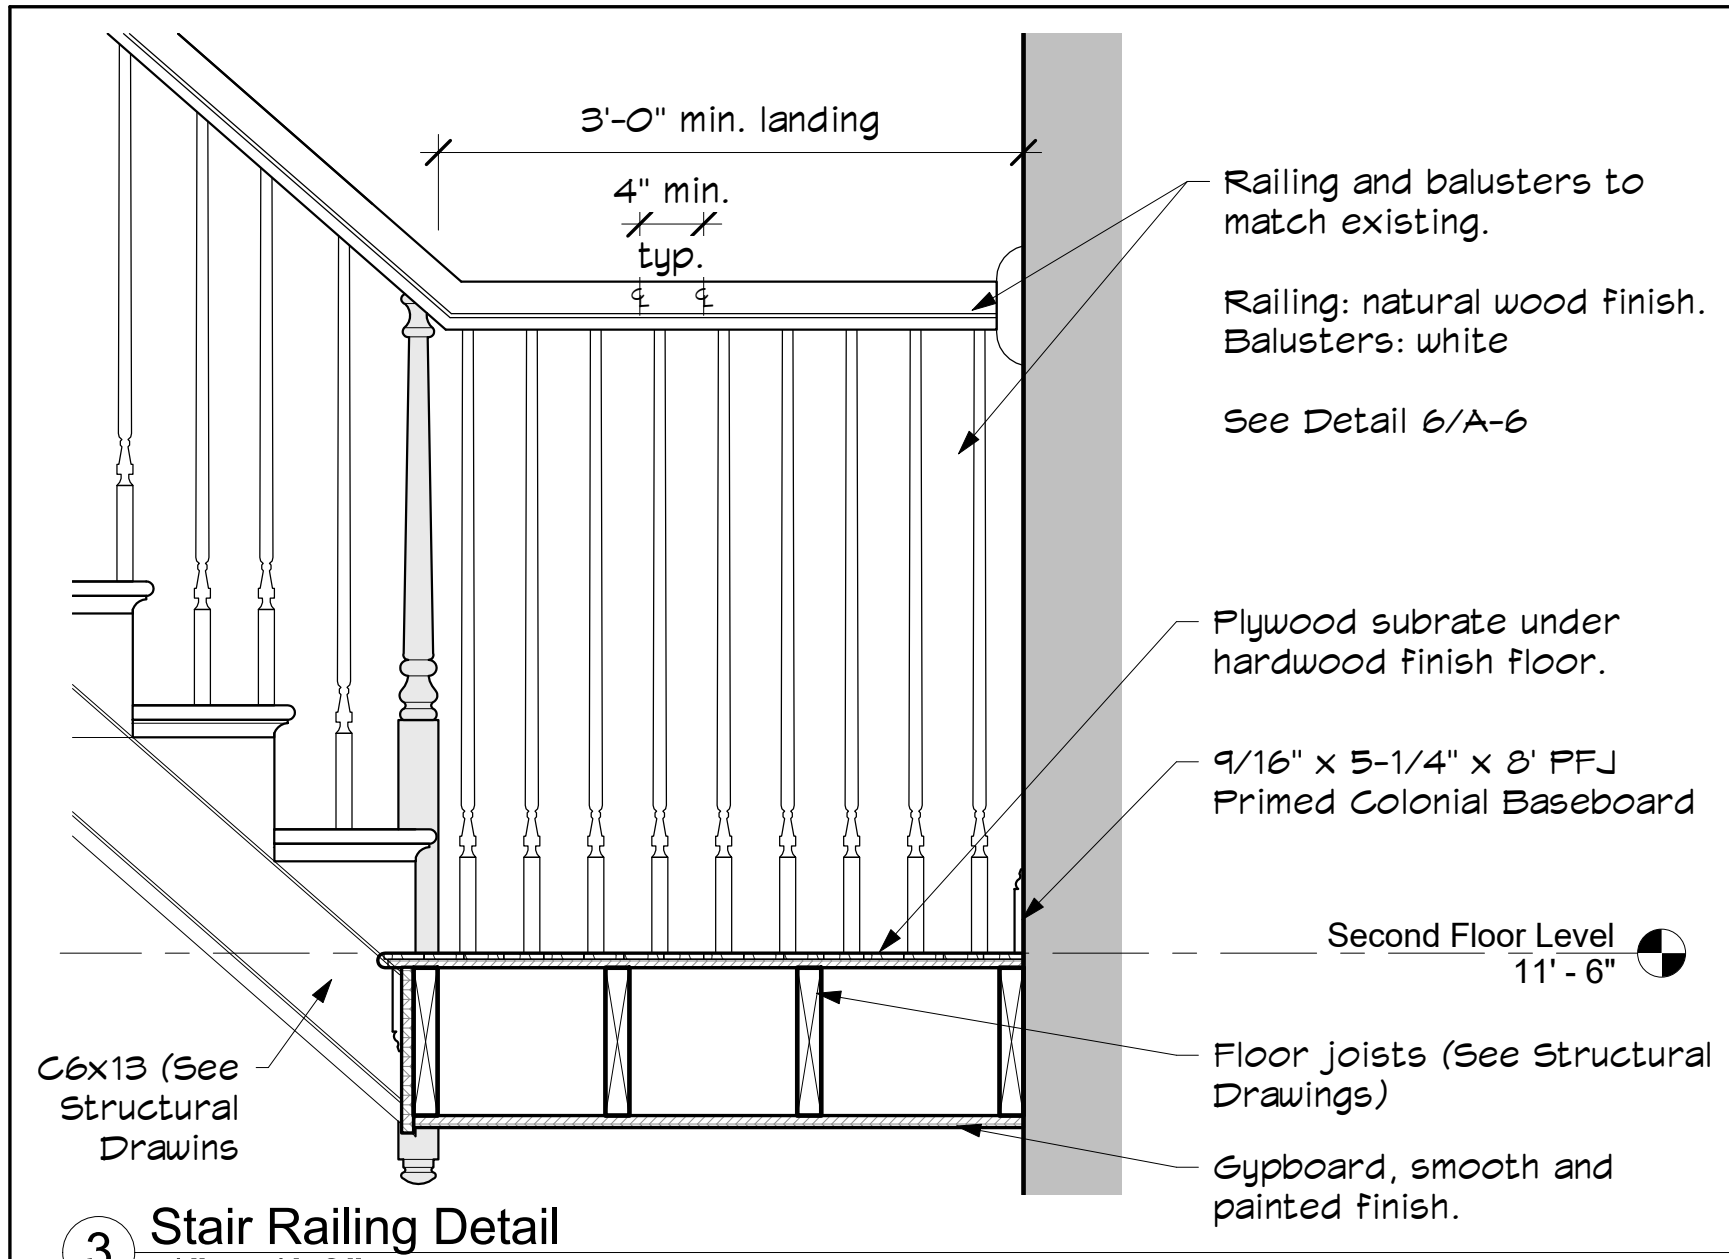


3 Stair Railing Detail
1" = 1'-0"

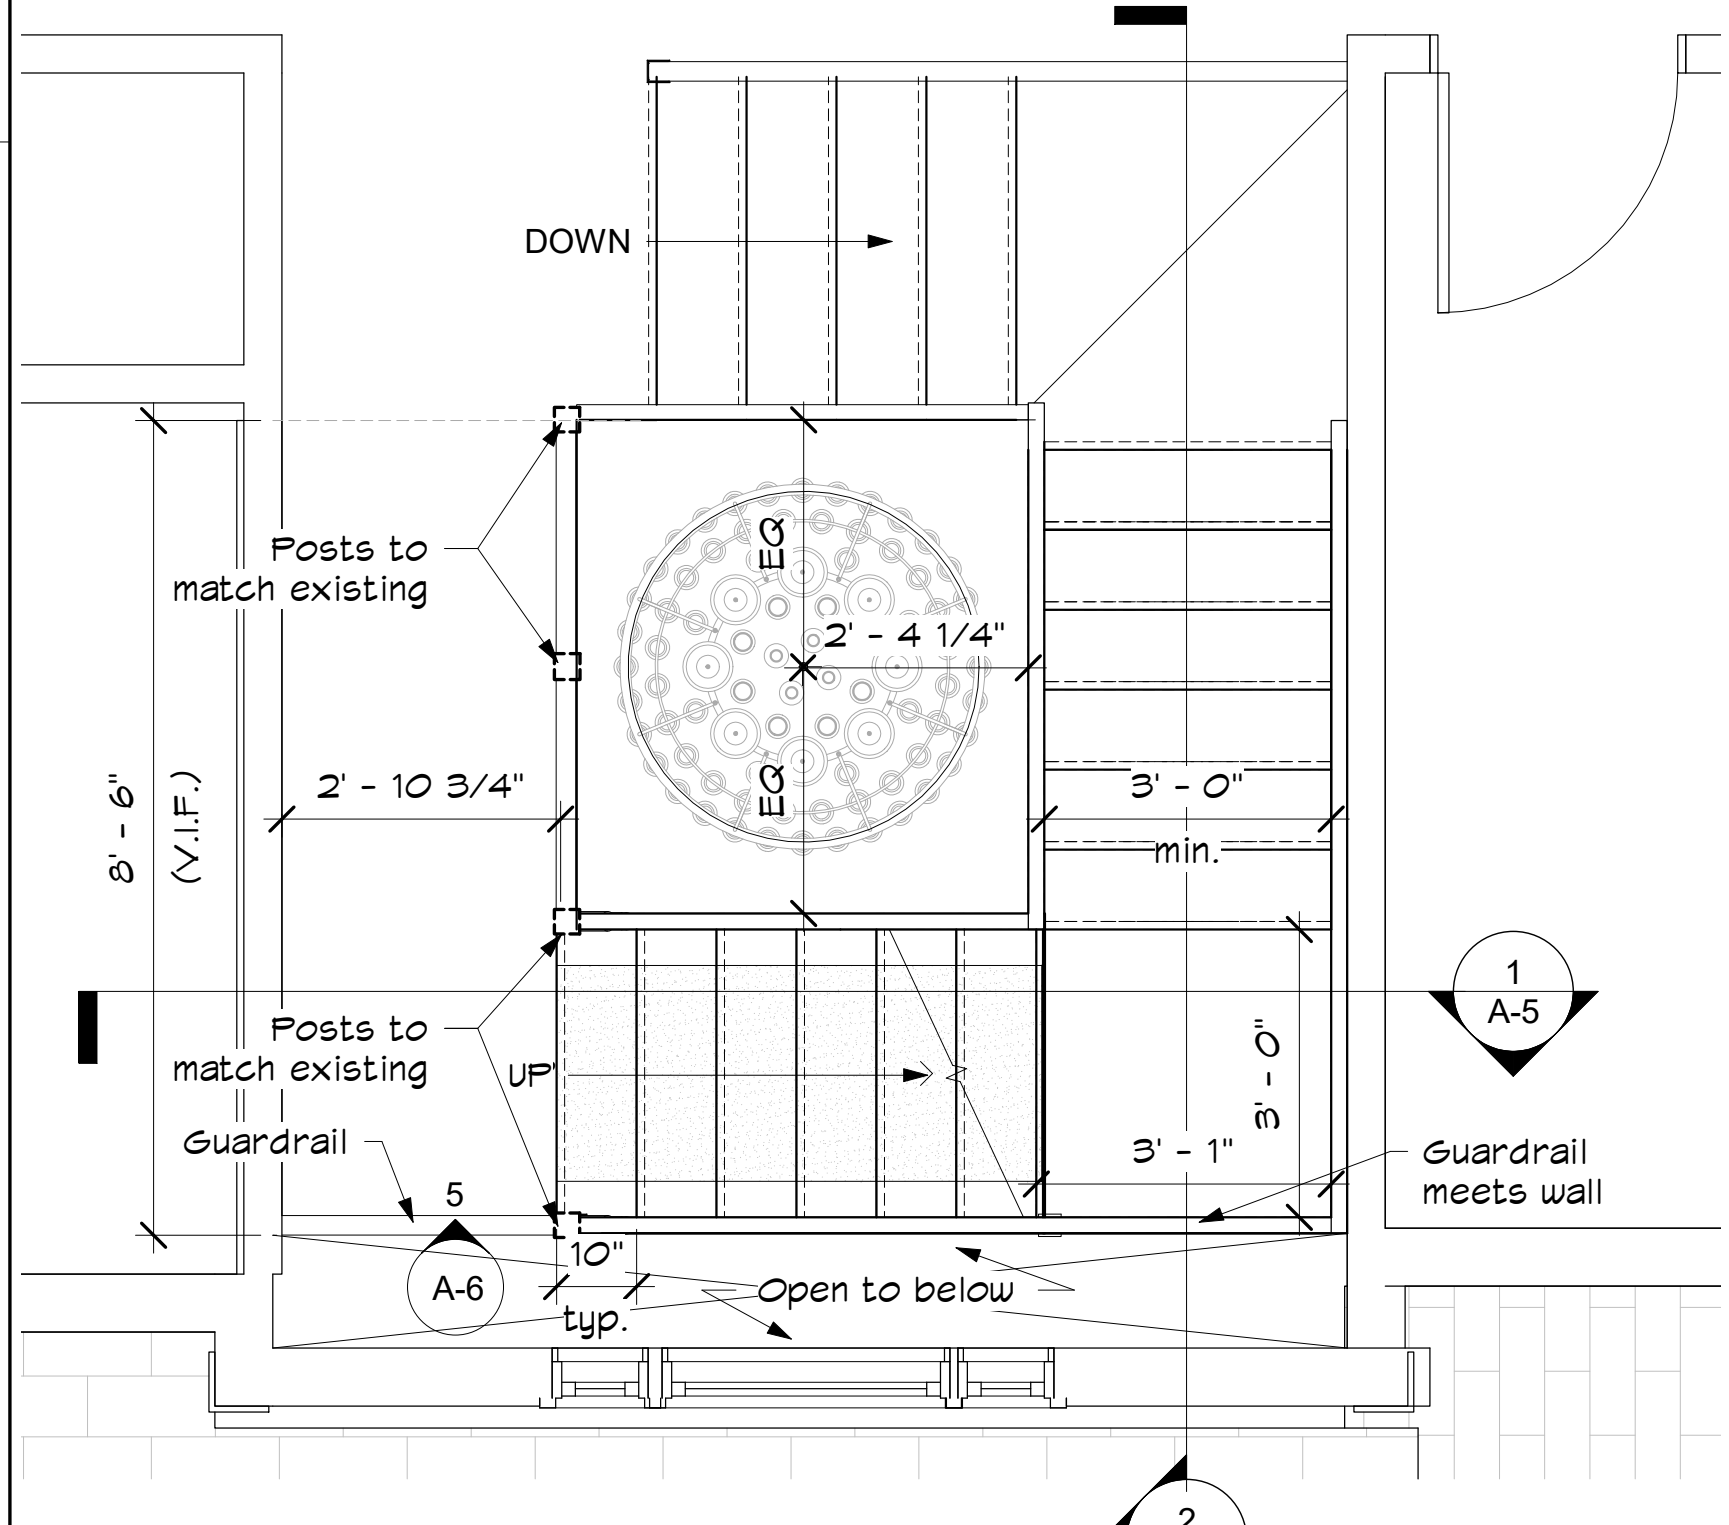


4 Proposed Second Floor Plan
1/2" = 1'-0"

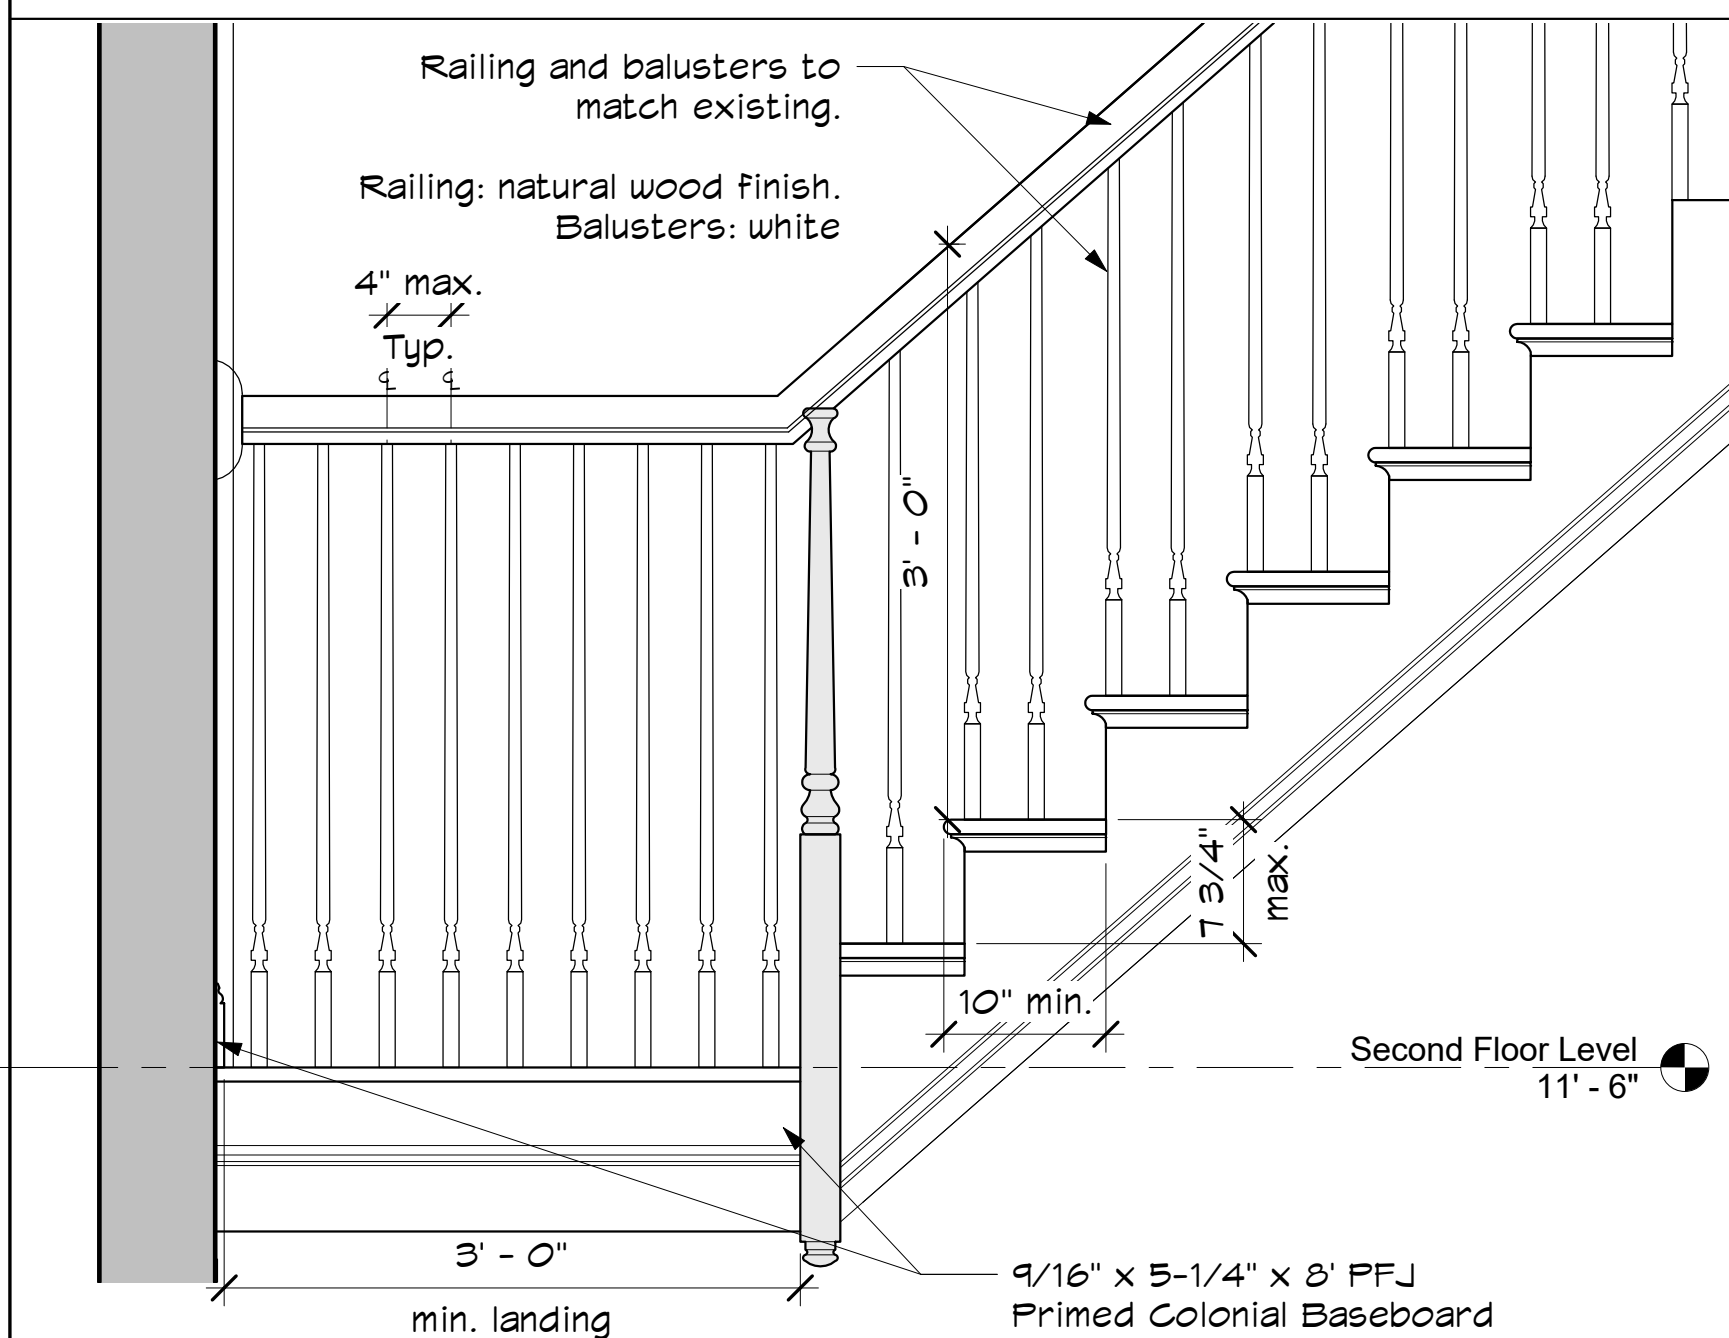


5 3 - c
1" = 1'-0"

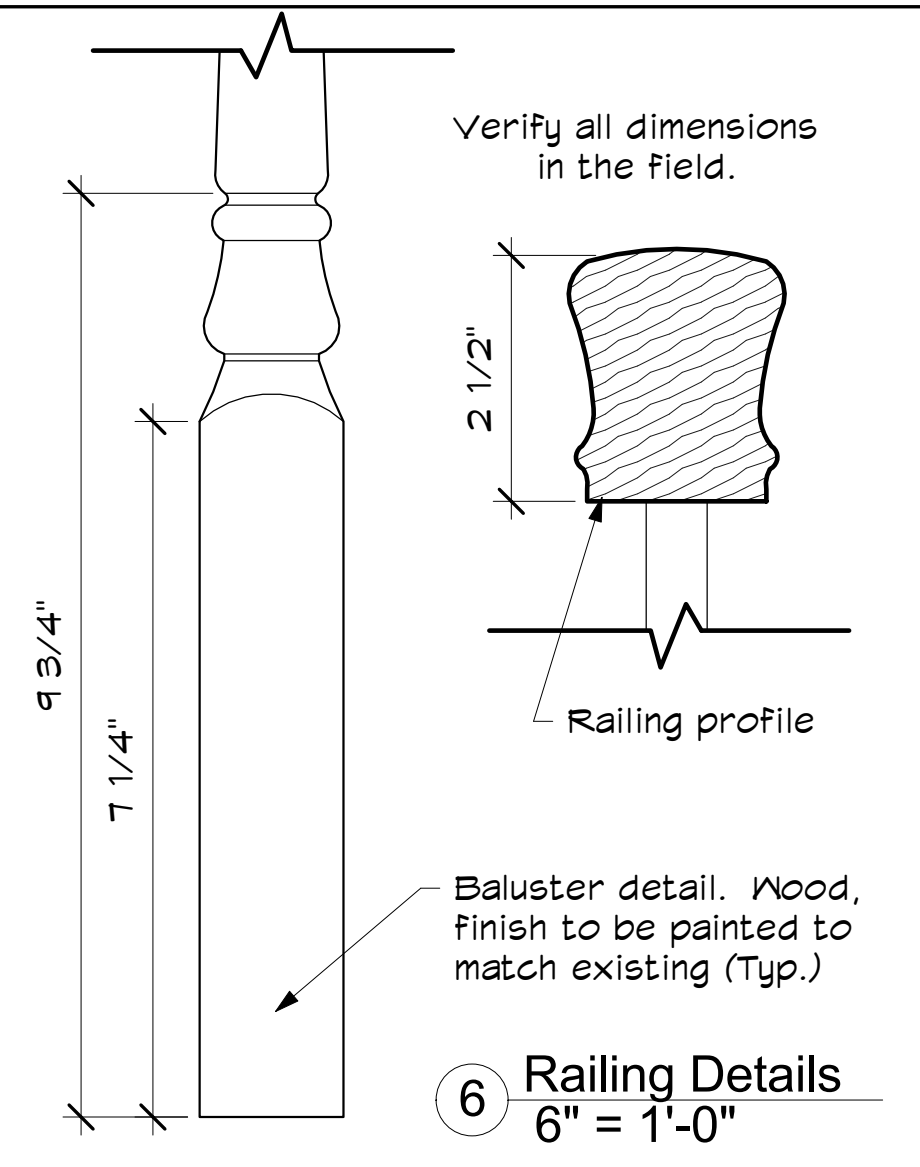


6 Railing Details
6" = 1'-0"

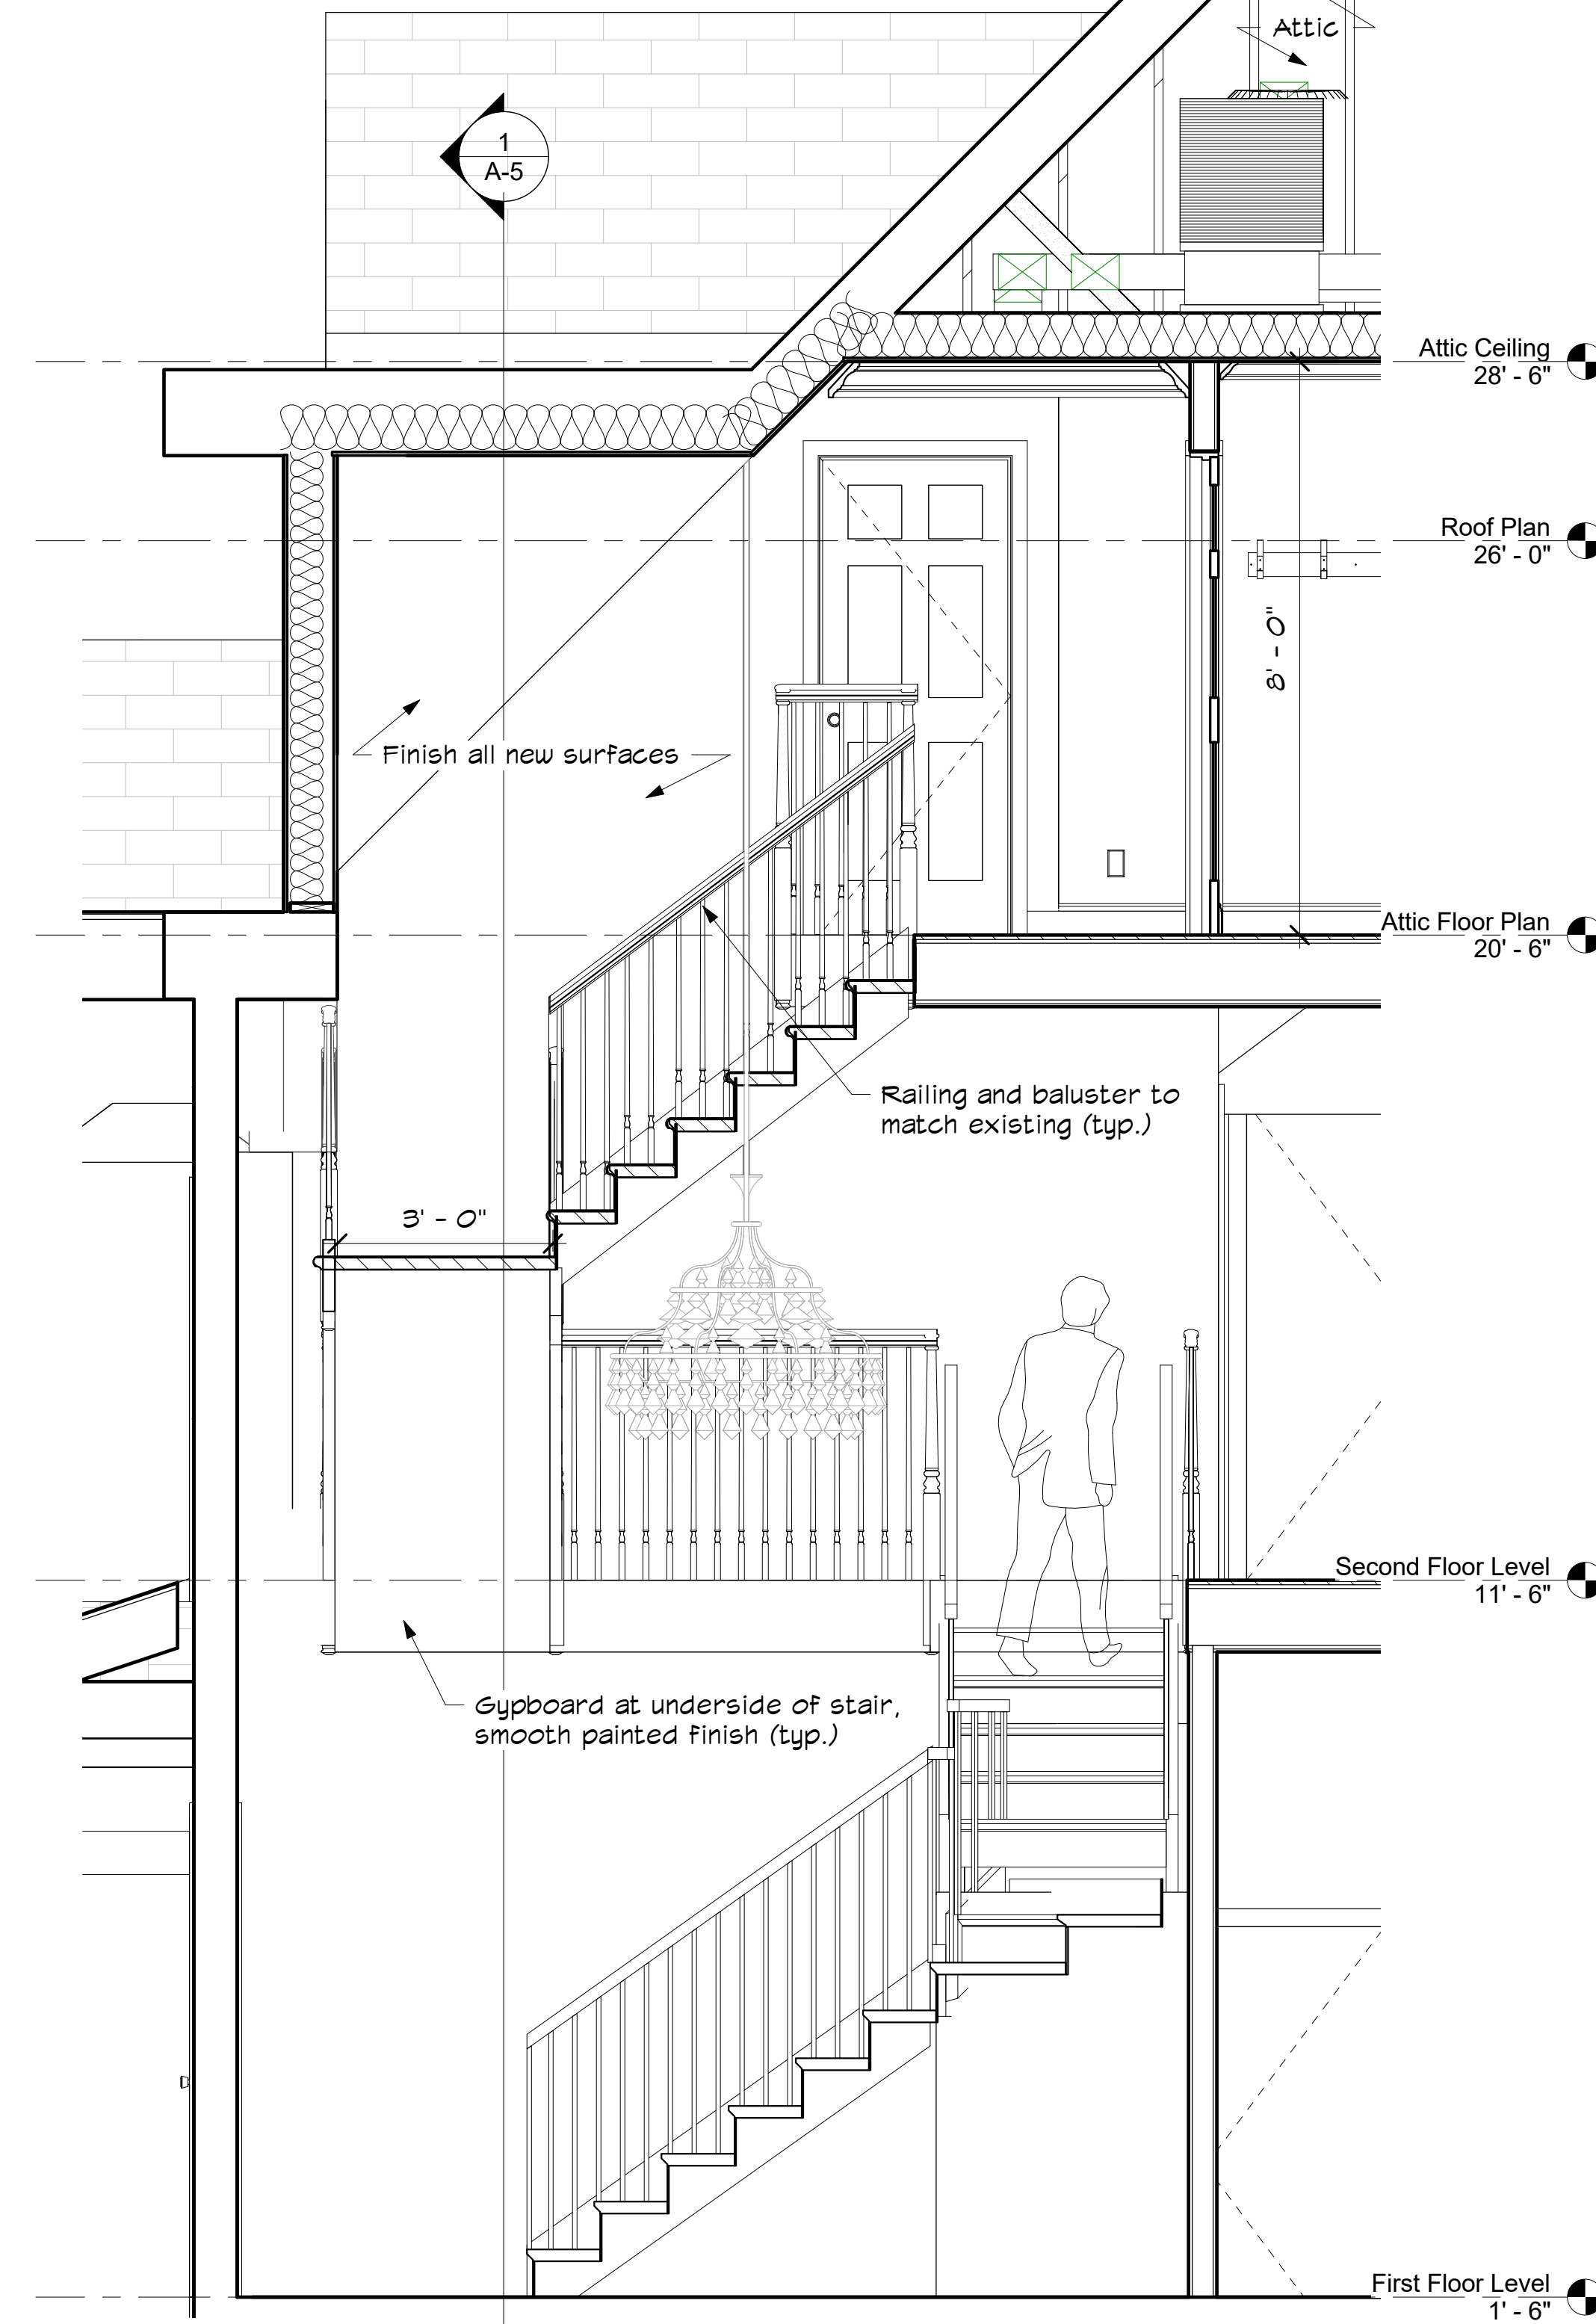

1 Stair Section A
1/2" = 1'-0"

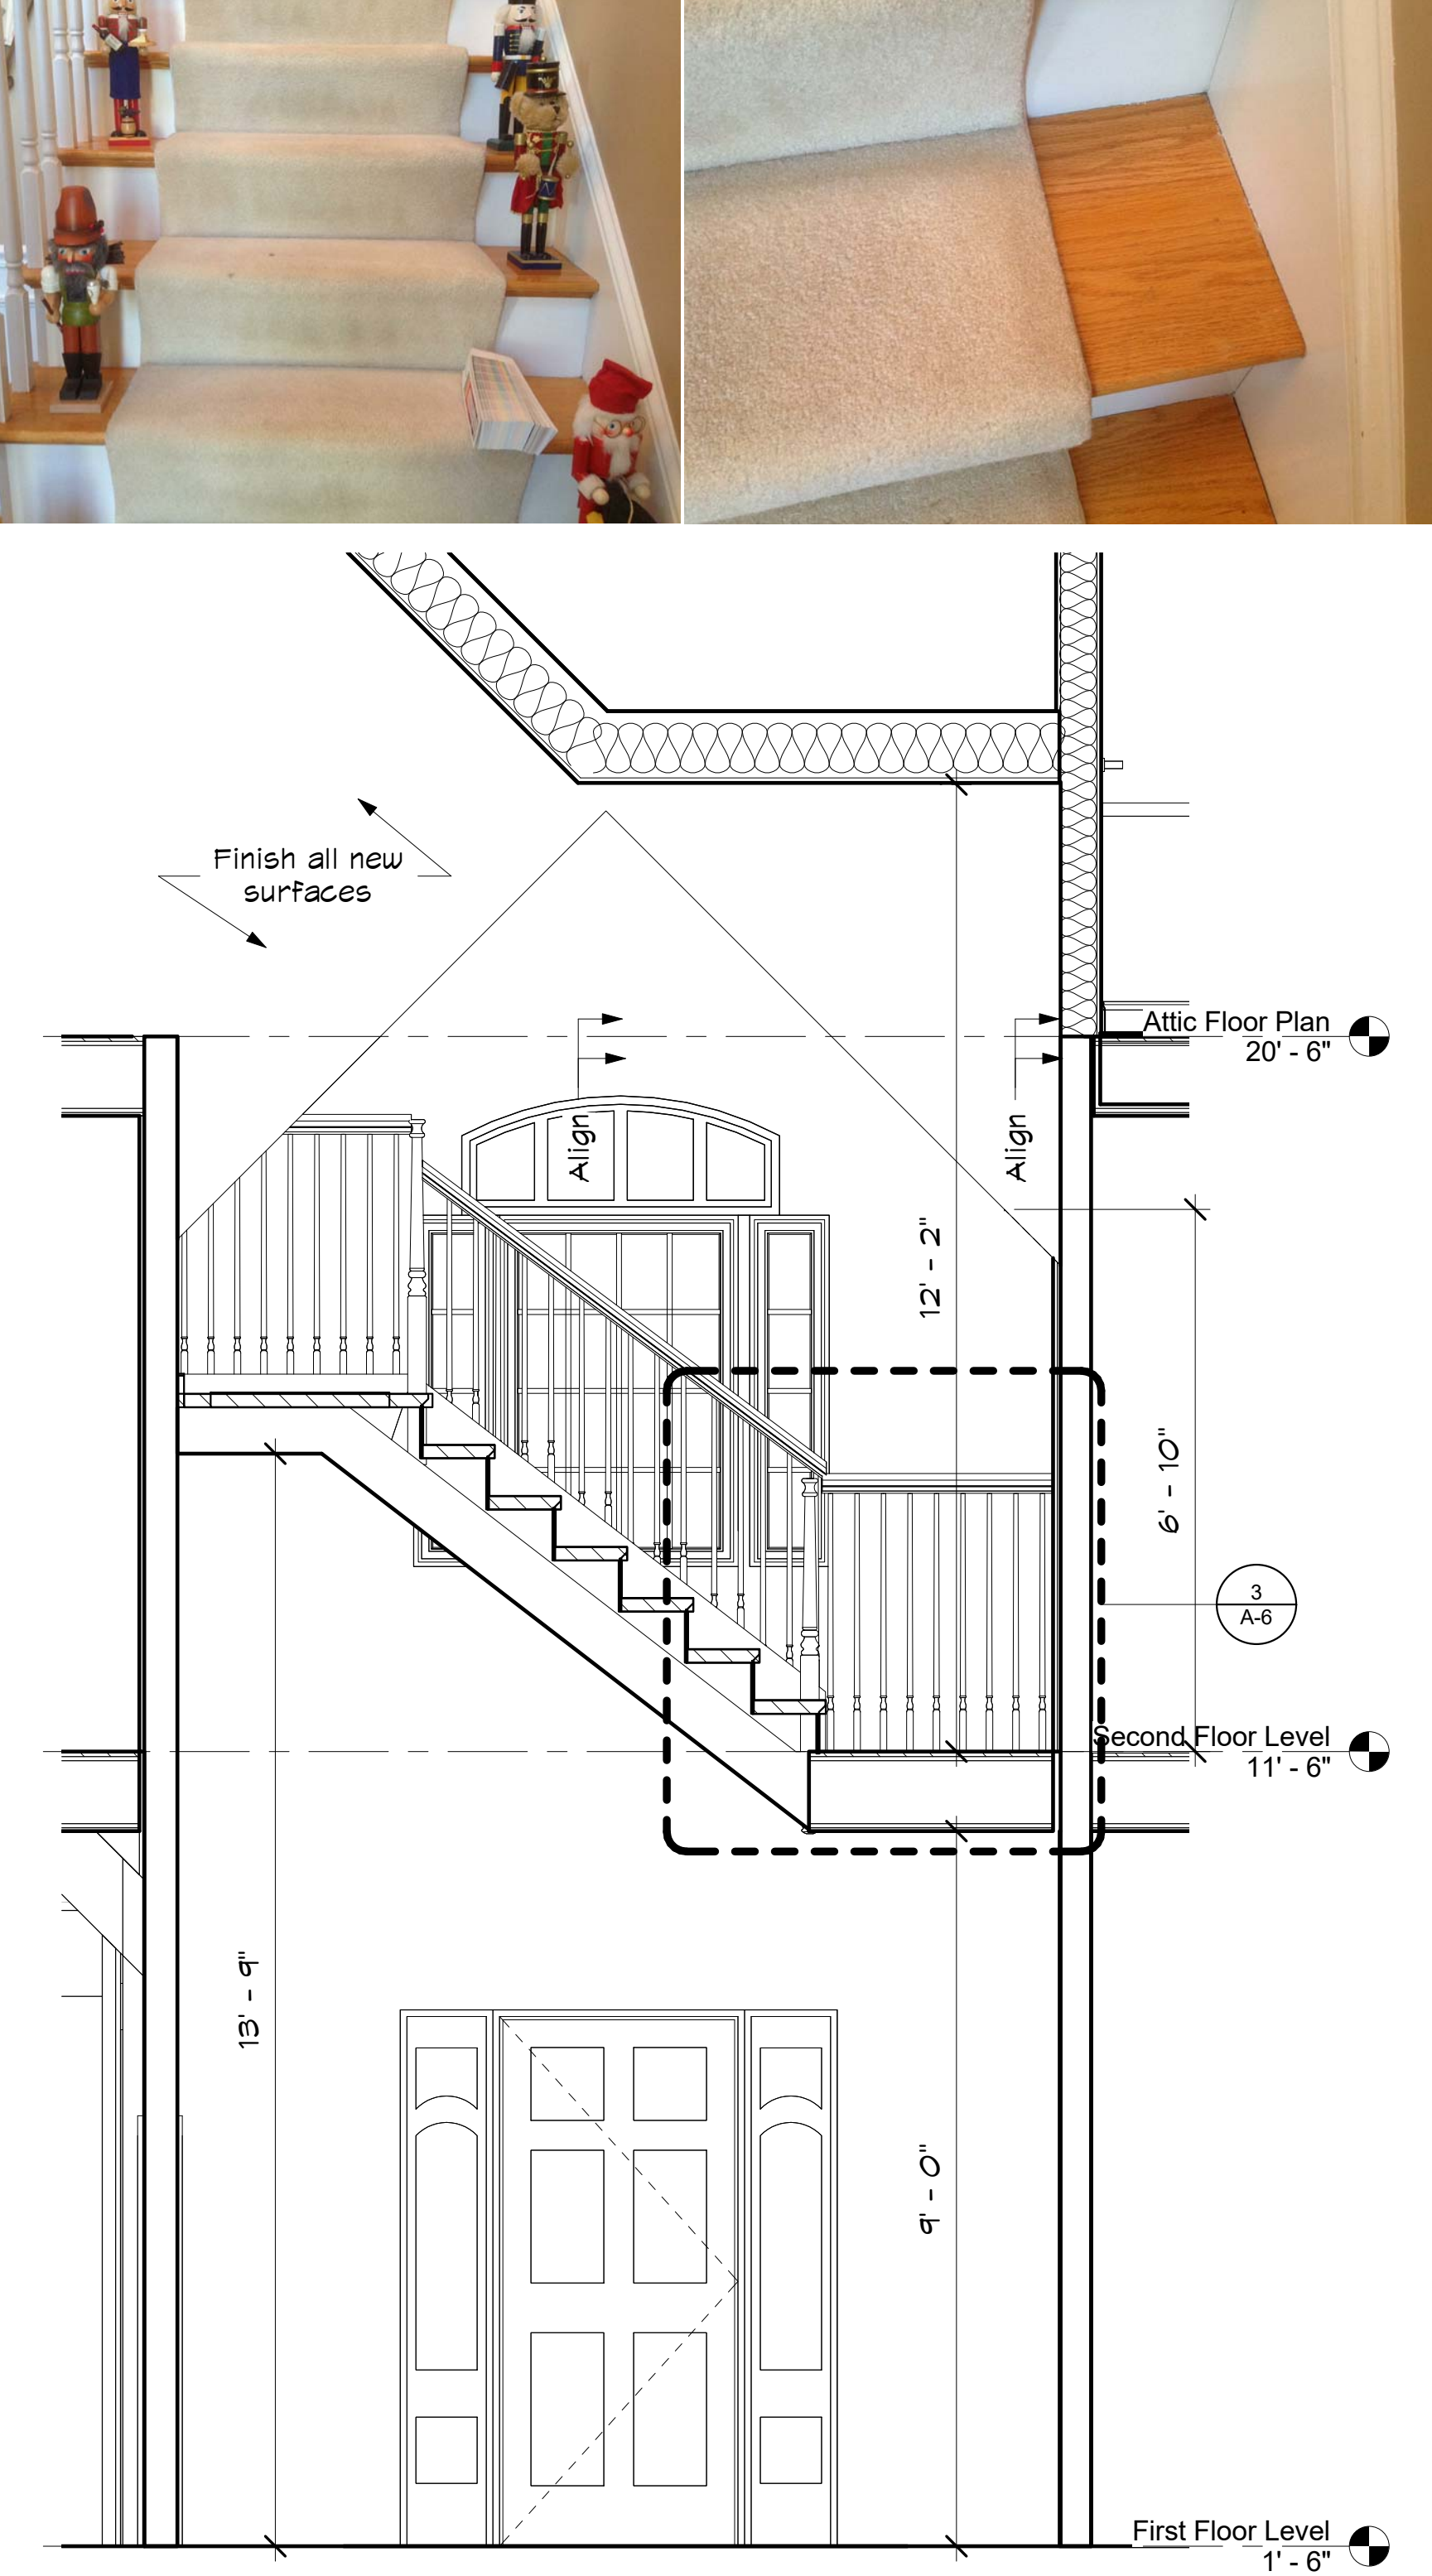

2 Stair Section B
1/2" = 1'-0"

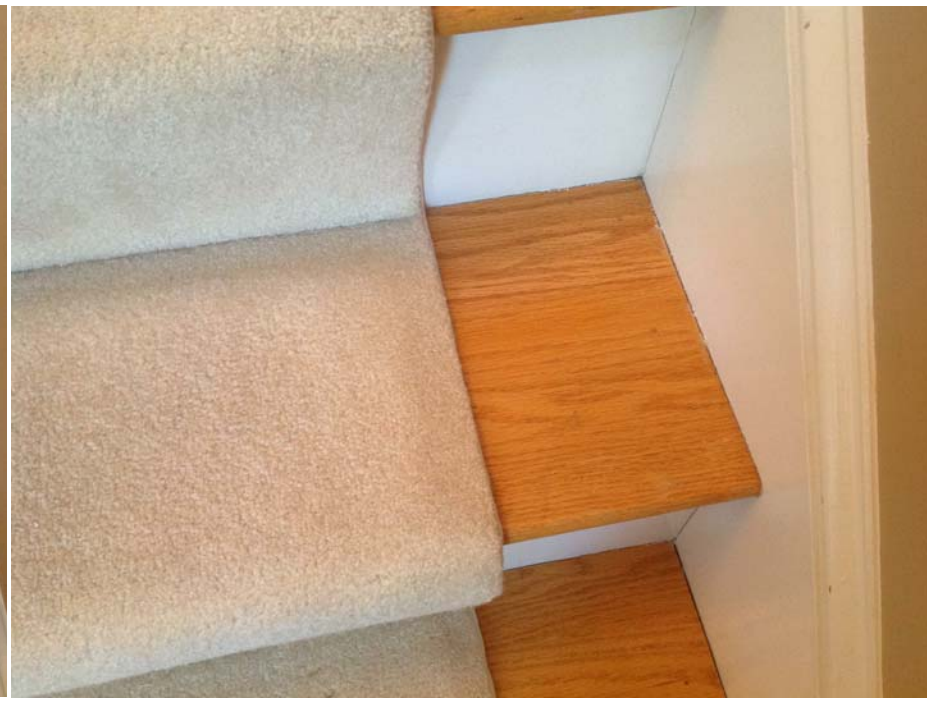

**GIENAPP
DESIGN**
ARCHITECTURE

20 Conant Street
Danvers, MA 01923
978.750.9062
gienappdesign.com

Werth Residence
Renovation
10 Cardinal Drive, Westwood, MA

© 2017 Gienapp Design Associates, LLC
ALL RIGHTS RESERVED. ALL IDEAS, DESIGNS, PLANS
AND SPECIFICATIONS ARE THE PROPERTY OF
GIENAPP DESIGN ASSOCIATES. RIGHTS OF USE ARE
CONDITIONAL AND ARE LIMITED TO A ONE-TIME USE
TO CONSTRUCT A SINGLE PROJECT ON THE SITE SO
INDICATED. USE OF THE WORK AND ANY DERIVATIVE
WORK COVERED UNDER THIS COPYRIGHT FOR
OTHER PROJECTS IS PROHIBITED. THE USE OR
REPRODUCTION OF THESE PLANS FOR ANY OTHER
CONSTRUCTION OR PERMIT APPLICATION IS STRICTLY
PROHIBITED WITHOUT PRIOR WRITTEN PERMISSION
OF GIENAPP DESIGN ASSOCIATES AND THE
ARCHITECT WHOSE SIGNATURE AND SEAL MAY BE
AFFIXED TO THESE DRAWINGS.

Revisions	Date

Project: 622.1
Drawn by: JB
Check by: IB/DG
Date: 01/13/17
Scale: As indicated


Stair Sections

A-6


F:\01-62221\Werth Residence\Attic Floor\02-1-DRAWINGS AND SPECIFICATIONS\02-1-Werth Residence_011317.rvt

IF THIS SHEET IS NOT 24 X 36 IT IS A REDUCED SCALE PRINT - SCALE ACCORDINGLY

1
3"=1'-0"
SCALE
0
2
1-1/2"=1'-0"
SCALE
1
3
1"=1'-0"
SCALE
0
6
1/2"=1'-0"
SCALE
0
12
1/4"=1'-0"
SCALE
0
20
1/8"=1'-0"
SCALE

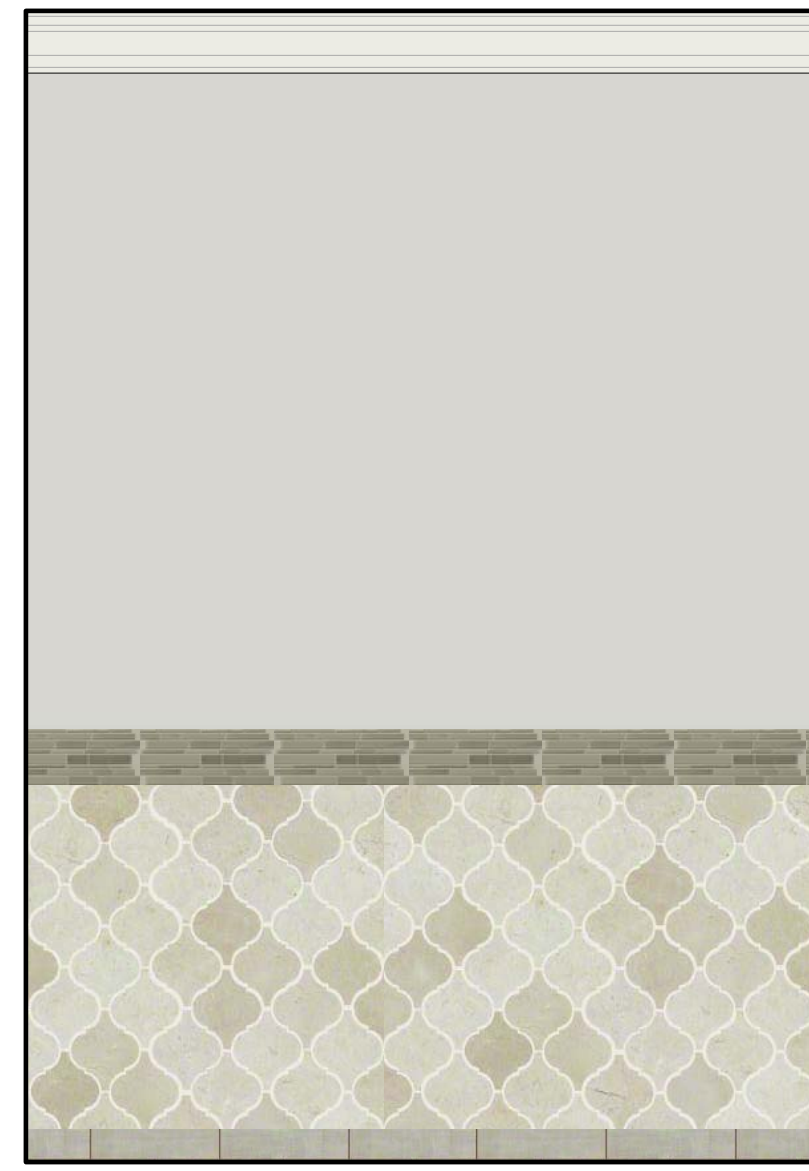

2 Shower Room Finish Elevation
3/4" = 1'-0"

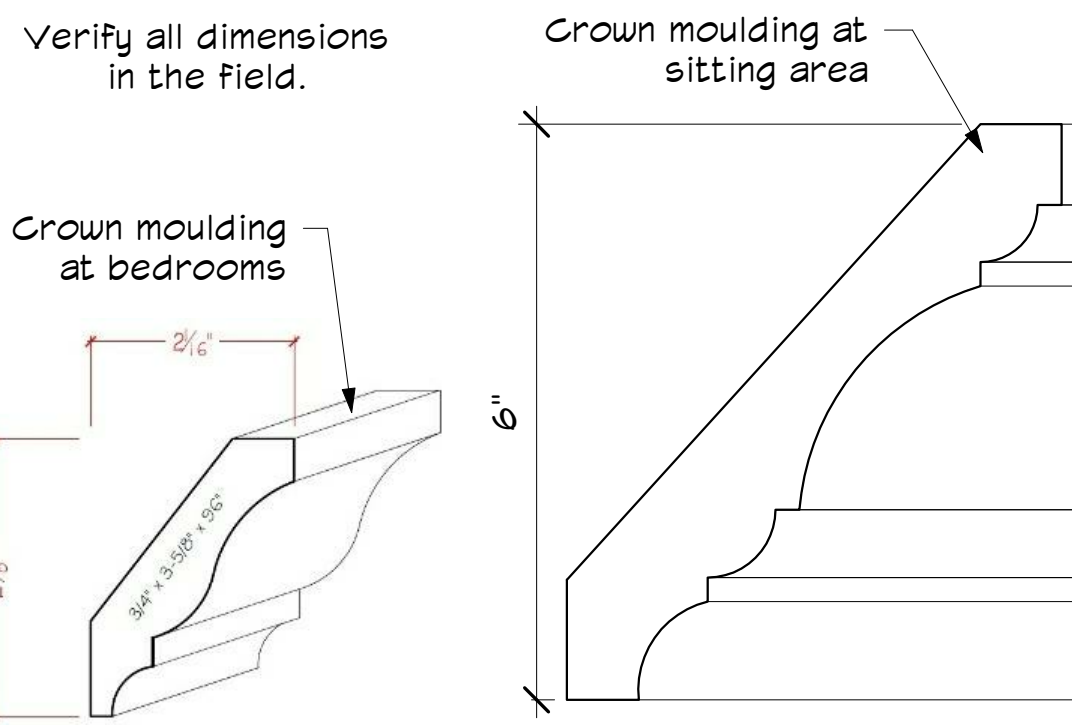


4 Crown Mouldings
6" = 1'-0"



3 Sink Vanity Elevation
3/4" = 1'-0"




PARTITION SCHEDULE 11

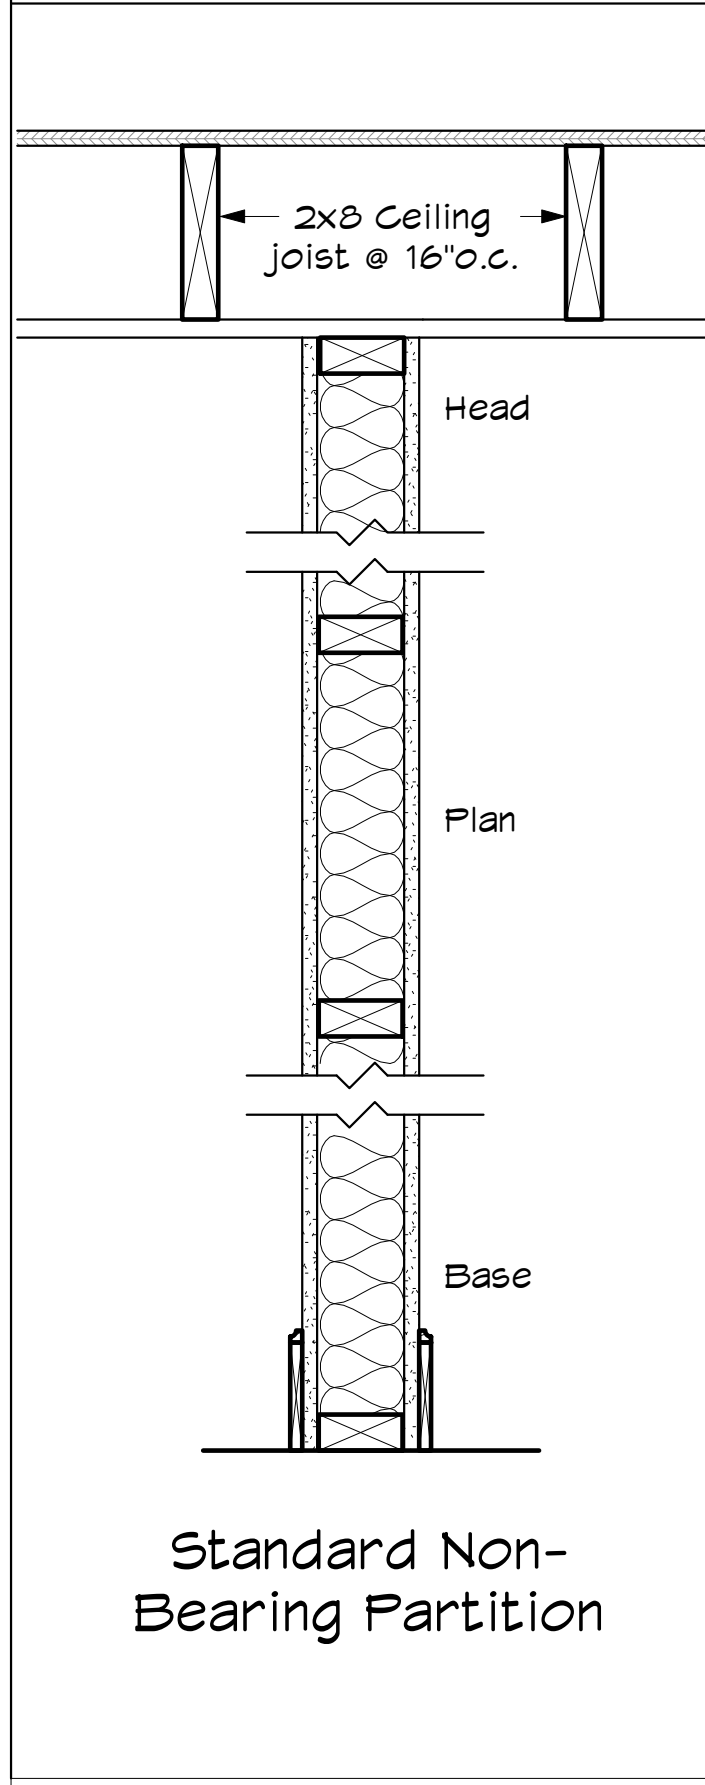


Standard Non-Bearing Partition

Description
<ul style="list-style-type: none"> 2x4" wood stud @ 16" o.c. 1/2" GNB each side SAFB
<p>1</p> <ul style="list-style-type: none"> Height: at finish ceiling
<p>1a</p> <ul style="list-style-type: none"> 5/8" MR GNB each side SAFB Height: to underside of structure

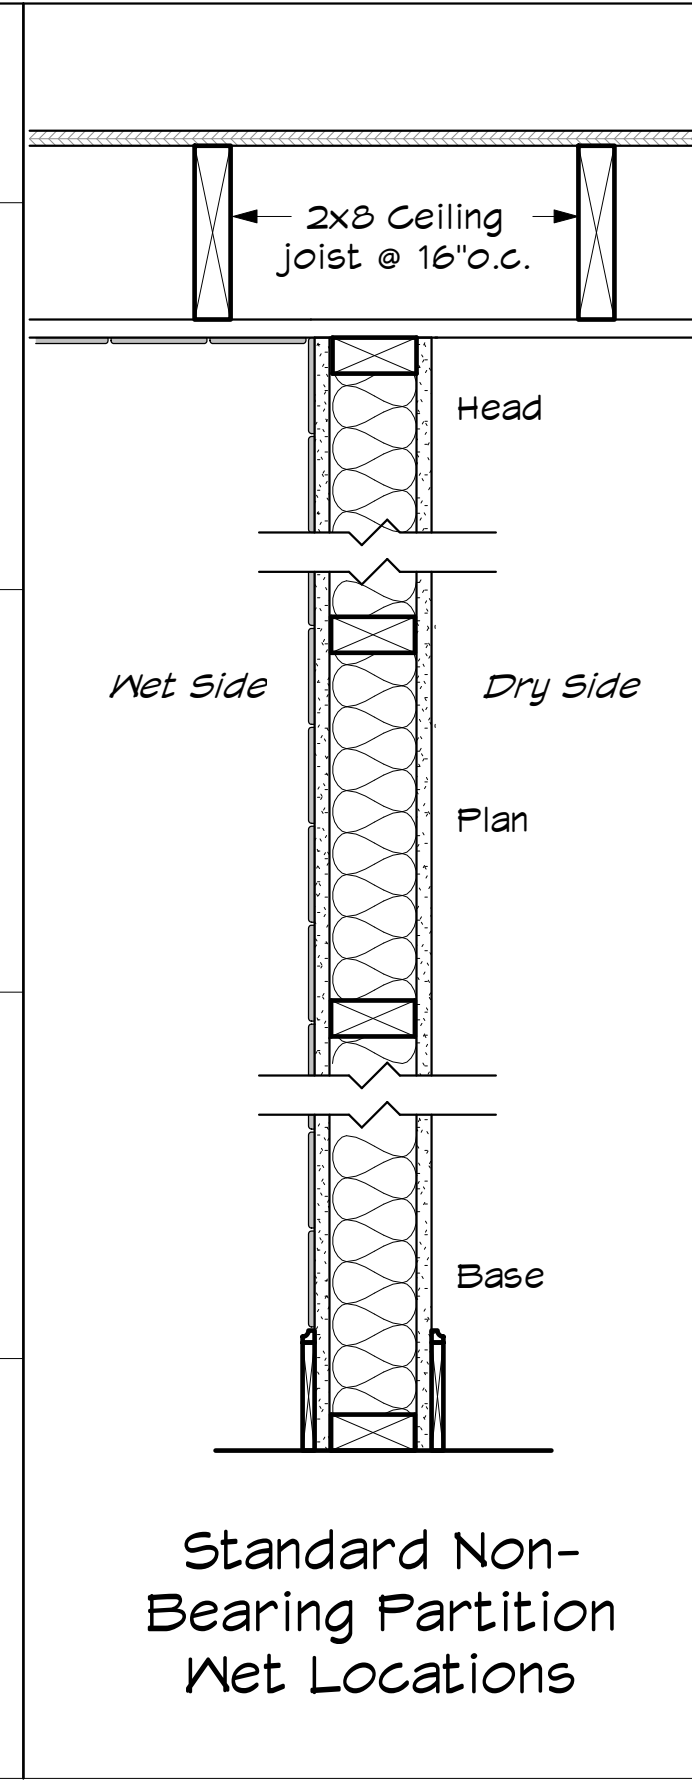

Standard Non-Bearing Partition Wet Locations

Description
<ul style="list-style-type: none"> 2x4" wood stud @ 16" o.c. 1/2" Cement Board Tile finish
<p>2</p> <ul style="list-style-type: none"> Height: at finish ceiling 1/2" Cement Board both sides Tile both sides
<p>2a</p> <ul style="list-style-type: none"> 5/8" MR GNB one side, cement board on tile side SAFB Height: to underside of structure
<p>2b</p> <ul style="list-style-type: none"> 5/8" MR GNB one side, cement board on tile side SAFB Height: to underside of structure
<p>2c</p> <ul style="list-style-type: none"> 5/8" MR GNB one side, cement board on tile side SAFB Height: to underside of structure 6" wall for pipes

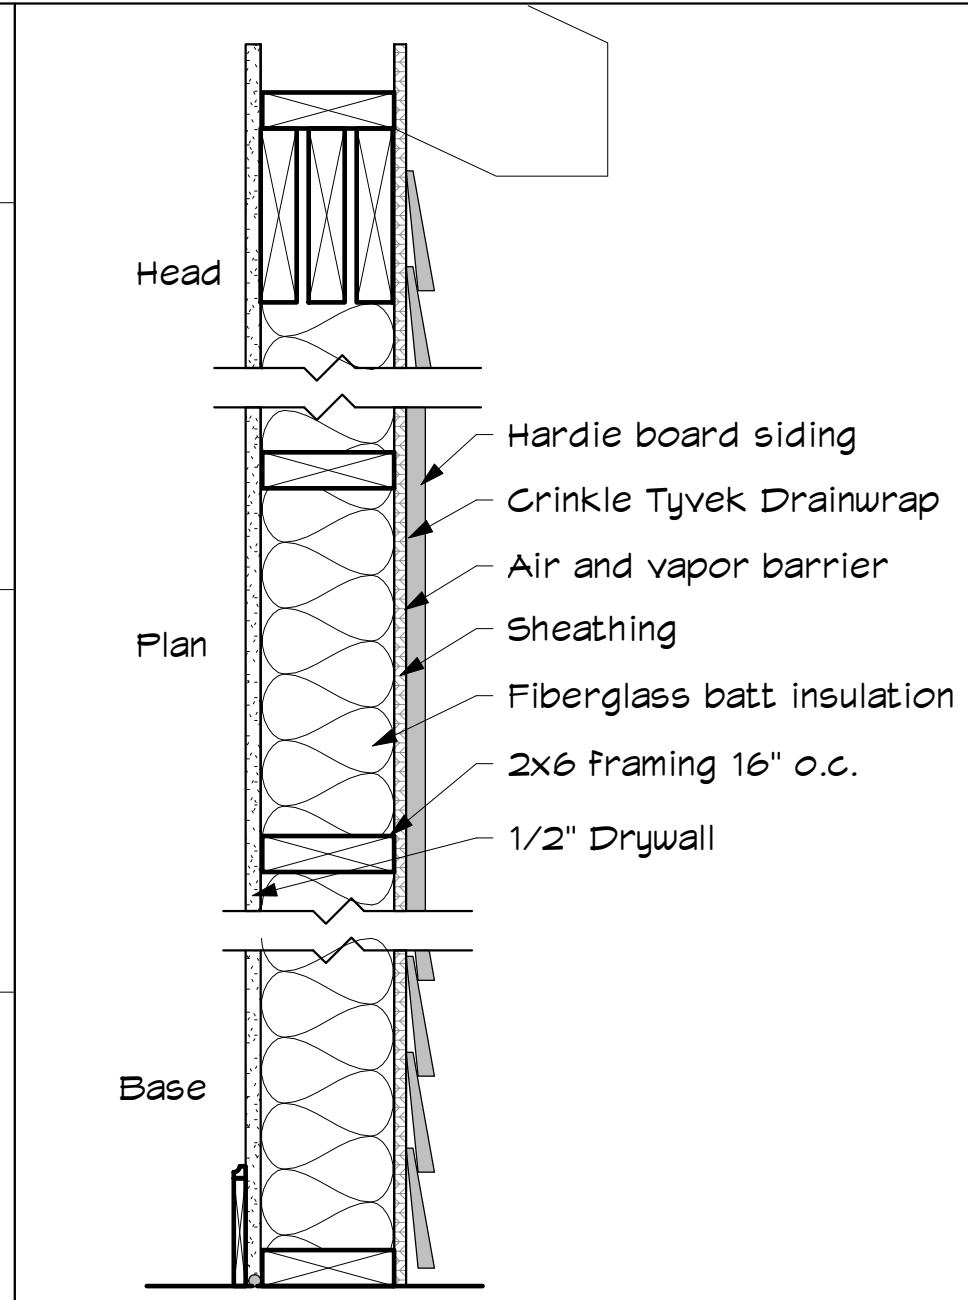

Standard Exterior Wall with Siding

Description
<ul style="list-style-type: none"> 2x6" wood stud @ 16" o.c. 1/2" GNB each side SAFB
<p>3</p> <ul style="list-style-type: none"> Height: To bottom of structure
<p>3a</p> <ul style="list-style-type: none"> 5/8" MR GNB on interior wall side SAFB Height: to underside of structure

General Partition Notes:

- Where partition appears to extend an existing partition, align the face of GNB with the existing GNB for a smooth surface unless noted otherwise.
- All new partitions are to have acoustical sealant as shown on detail
- For better sound isolation, stagger electrical boxes in the partition to avoid being back to back. Where possible, place electrical boxes in different stud cavities.


General Partition Notes:

- Where partition appears to extend an existing partition, align the face of GNB with the existing GNB for a smooth surface unless noted otherwise.
- All new partitions are to have acoustical sealant as shown on detail
- For better sound isolation, stagger electrical boxes in the partition to avoid being back to back. Where possible, place electrical boxes in different stud cavities.

Partition Wall Schedule
1 1/2" = 1'-0"

NOTES:

- Closet walls will be painted one color.
- Hardwood Floors throughout (U.N.O.)
- Bathroom walls will be painted one color.

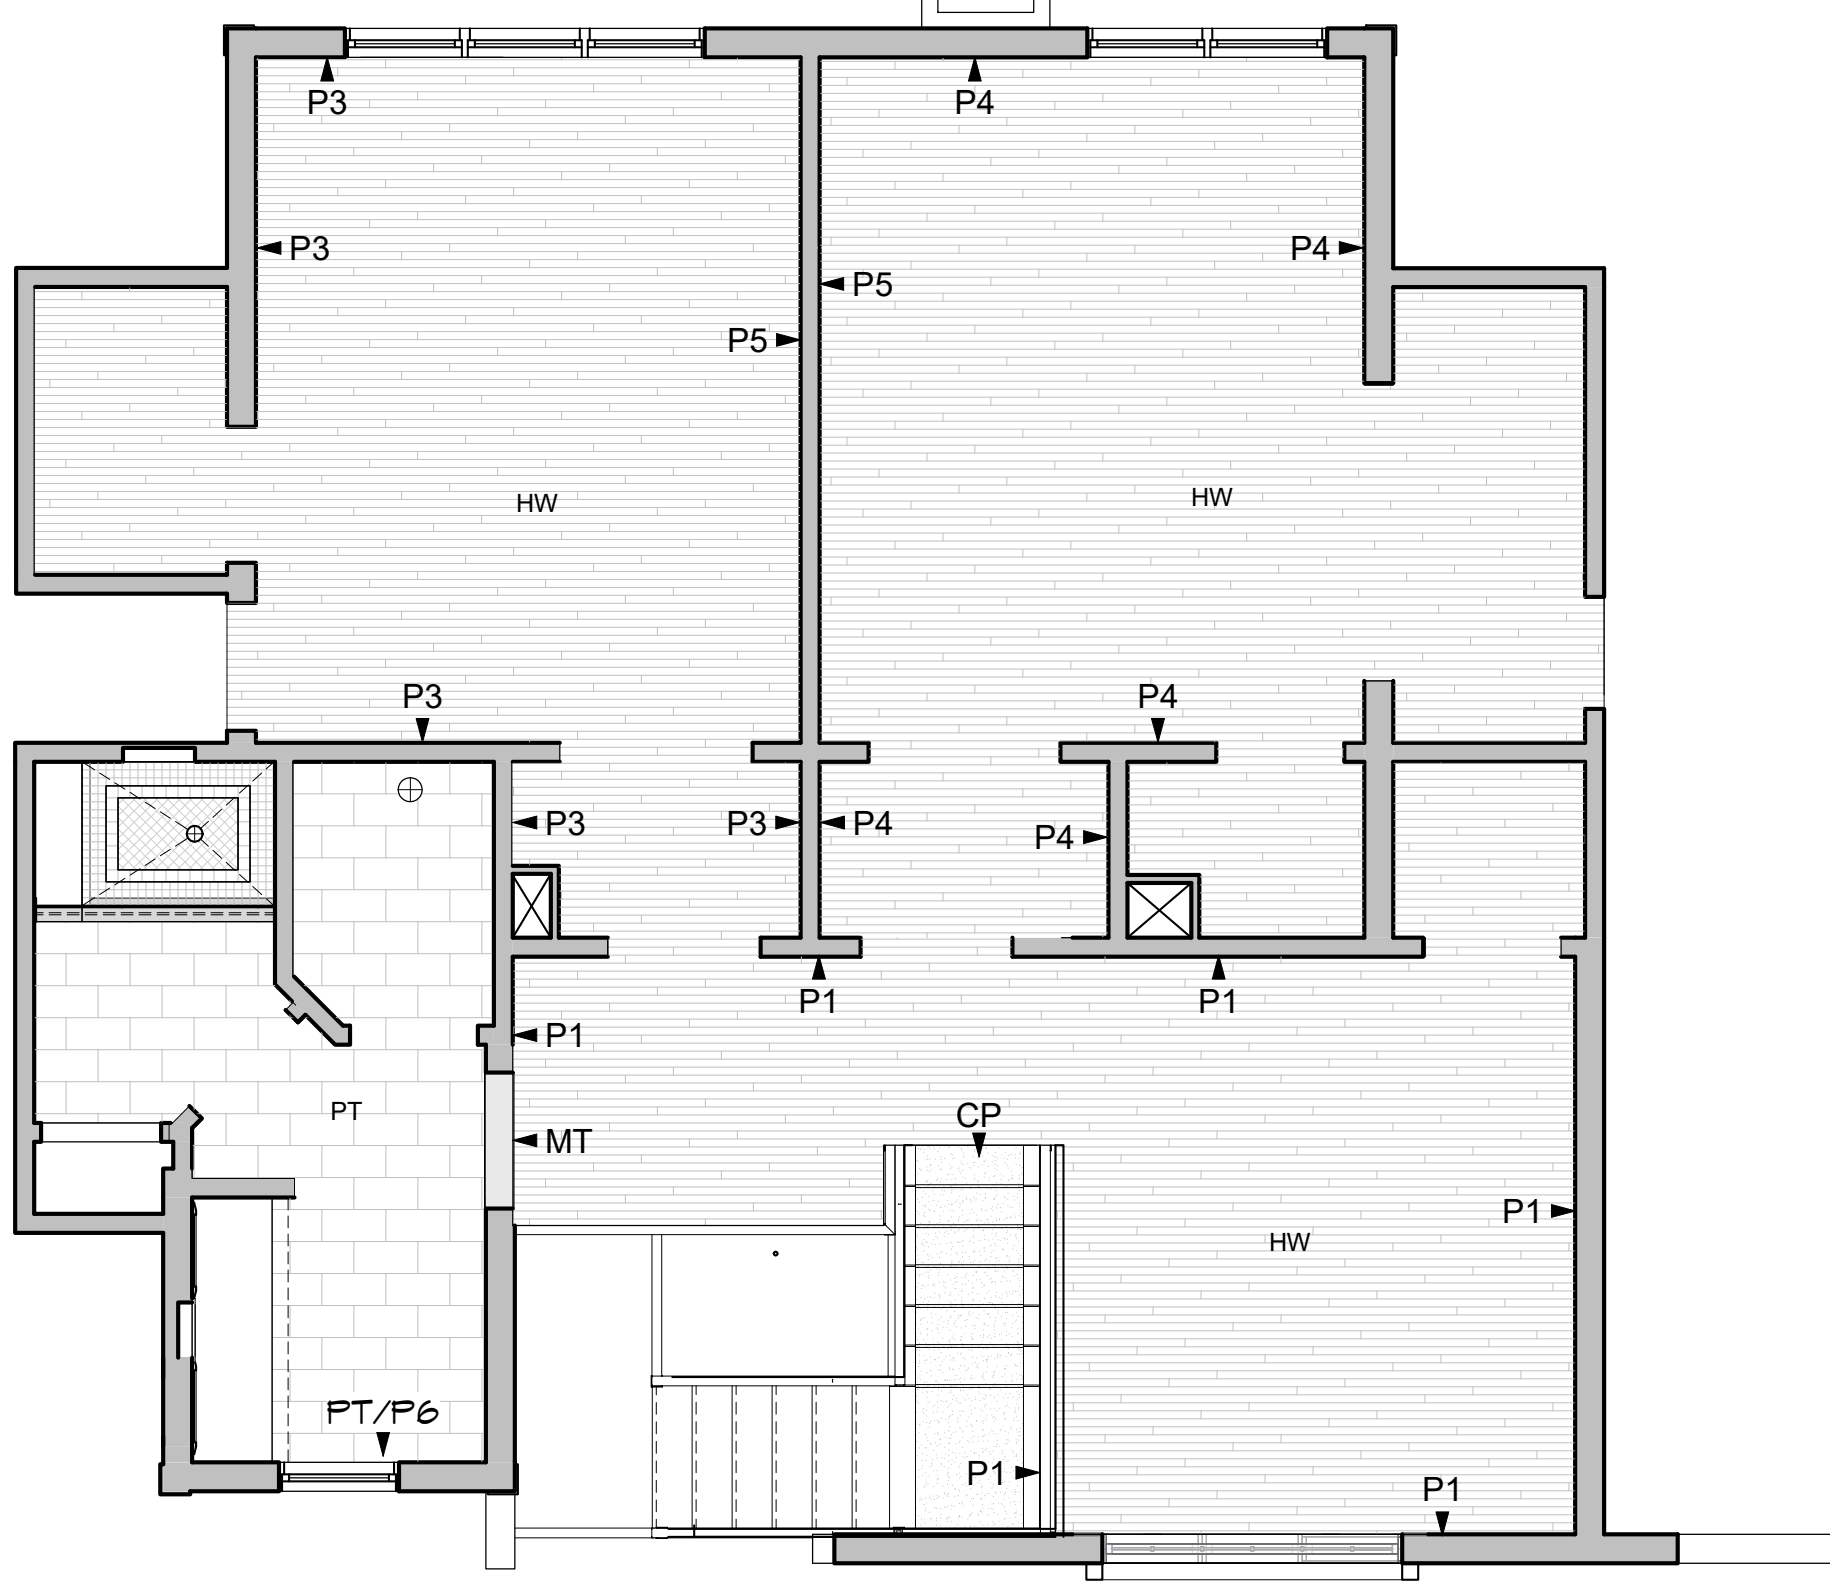

1 Attic Finish Floor Plan
1/4" = 1'-0"



FINISH ABBREVIATION LEGEND	
Flooring	
CP	Carpet
PT	Porcelain Tile
HW	Hardwood
WB	Wood Base
MT	Marble Threshold
Walls	
P#	Paint
WT#	Wall Tile

SYMBOL LEGEND	
Floor Finish Labels	
[Symbol]	Base Material
[Symbol]	Floor Material
[Symbol]	Carpet
[Symbol]	Hardwood
[Symbol]	Tile Floor
Wall Finish Labels	
[Symbol]	Finish on entire wall

Finish Legend
1/8" = 1'-0"

© 2017 Gienapp Design Associates, LLC
ALL RIGHTS RESERVED. ALL IDEAS, DESIGNS, PLANS AND SPECIFICATIONS ARE THE PROPERTY OF GIENAPP DESIGN ASSOCIATES. RIGHTS OF USE ARE CONDITIONAL AND ARE LIMITED TO A ONE-TIME USE TO CONSTRUCT A SINGLE PROJECT ON THE SITE SO INDICATED. USE OF THE WORK AND ANY DERIVATIVE WORK COVERED UNDER THIS COPYRIGHT FOR OTHER PROJECTS IS PROHIBITED. THE USE OR REPRODUCTION OF THESE PLANS FOR ANY OTHER CONSTRUCTION OR PERMIT APPLICATION IS STRICTLY PROHIBITED WITHOUT PRIOR WRITTEN PERMISSION OF GIENAPP DESIGN ASSOCIATES AND THE ARCHITECT WHOSE SIGNATURE AND SEAL MAY BE AFFIXED TO THESE DRAWINGS.

Revisions	Date

Project: 622.1
Drawn by: JB
Check by: IB
Date: 01/13/17
Scale: As indicated

Partition Schedule and Finish Plan



**GIENAPP
DESIGN**
ARCHITECTURE

20 Conant Street
Danvers, MA 01923
978.750.9062
gienappdesign.com

Werth Residence
Renovation
10 Cardinal Drive, Westwood, MA

Plot Date: 1/16/2017 10:05:30 AM

© 2017 Gienapp Design Associates, LLC
ALL RIGHTS RESERVED. ALL IDEAS, DESIGNS, PLANS
AND SPECIFICATIONS ARE THE PROPERTY OF
GIENAPP DESIGN ASSOCIATES. RIGHTS OF USE ARE
CONDITIONAL AND ARE LIMITED TO A ONE-TIME USE
TO CONSTRUCT A SINGLE PROJECT ON THE SITE SO
INDICATED. USE OF THE WORK AND ANY DERIVATIVE
WORK COVERED UNDER THIS COPYRIGHT FOR
OTHER PROJECTS IS PROHIBITED. THE USE OR
REPRODUCTION OF THESE PLANS FOR ANY OTHER
CONSTRUCTION OR PERMIT APPLICATION IS STRICTLY
PROHIBITED WITHOUT PRIOR WRITTEN PERMISSION
OF GIENAPP DESIGN ASSOCIATES AND THE
ARCHITECT WHOSE SIGNATURE AND SEAL MAY BE
AFFIXED TO THESE DRAWINGS.

Revisions	Date

Project: 622.1
Drawn by: JB
Check by: IB
Date: 01/13/17
Scale: As indicated


Window and
Door
Schedules

A-8


Door Schedule

No.	Door Type	Door Size		Door		Frame		Details			Hardware Set Function	Notes	
		Height	Width	Mat.	Finish	Mat.	Finish	Head	Jamb	Thresh			
New Construction													
101	A	6' - 8"	3' - 0"	WD	PTD	WD	PTD					Bedroom Lockset Privacy	
102	A	6' - 8"	3' - 0"	WD	PTD	WD	PTD					Bedroom Lockset Privacy	
103	A	6' - 8"	2' - 8"	WD	PTD	WD	PTD					Bathroom Lockset	
104	A	6' - 8"	2' - 6"	WD	PTD	WD	PTD					Bathroom Lockset	
105	A	6' - 8"	2' - 8"	WD	PTD	WD	PTD					Bathroom Lockset	
106	A	6' - 8"	2' - 4"	WD	PTD	WD	PTD					Closet/No lock	
107	A	6' - 8"	2' - 6"	WD	PTD	WD	PTD					Attic Access	Provide weather stripping
108	B	6' - 8"	6' - 0"	WD	PTD	WD	PTD					Closet/Sliding Door	
109	Y	6' - 0"	2' - 4"	WD	PTD	WD	PTD					Attic Access	
111	A	6' - 8"	2' - 8"	WD	PTD	WD	PTD					Closet/No lock	
112	A	6' - 8"	2' - 8"	WD	PTD	WD	PTD					Closet/No lock	
113	A	6' - 8"	2' - 6"	WD	PTD	WD	PTD					Closet/No lock	Provide weather stripping

DOOR TYPES


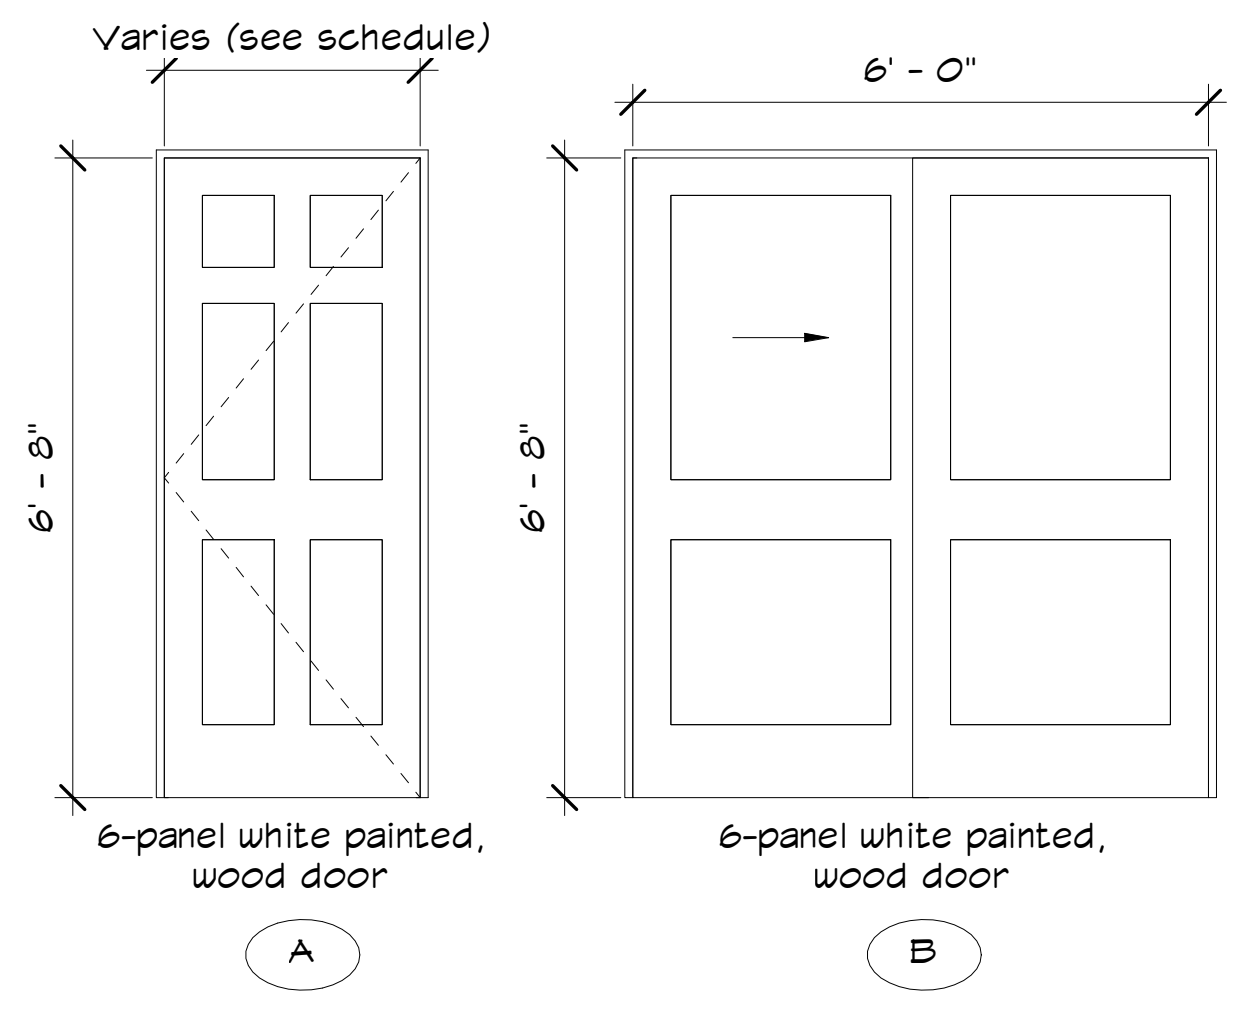


DOOR FRAME TYPES

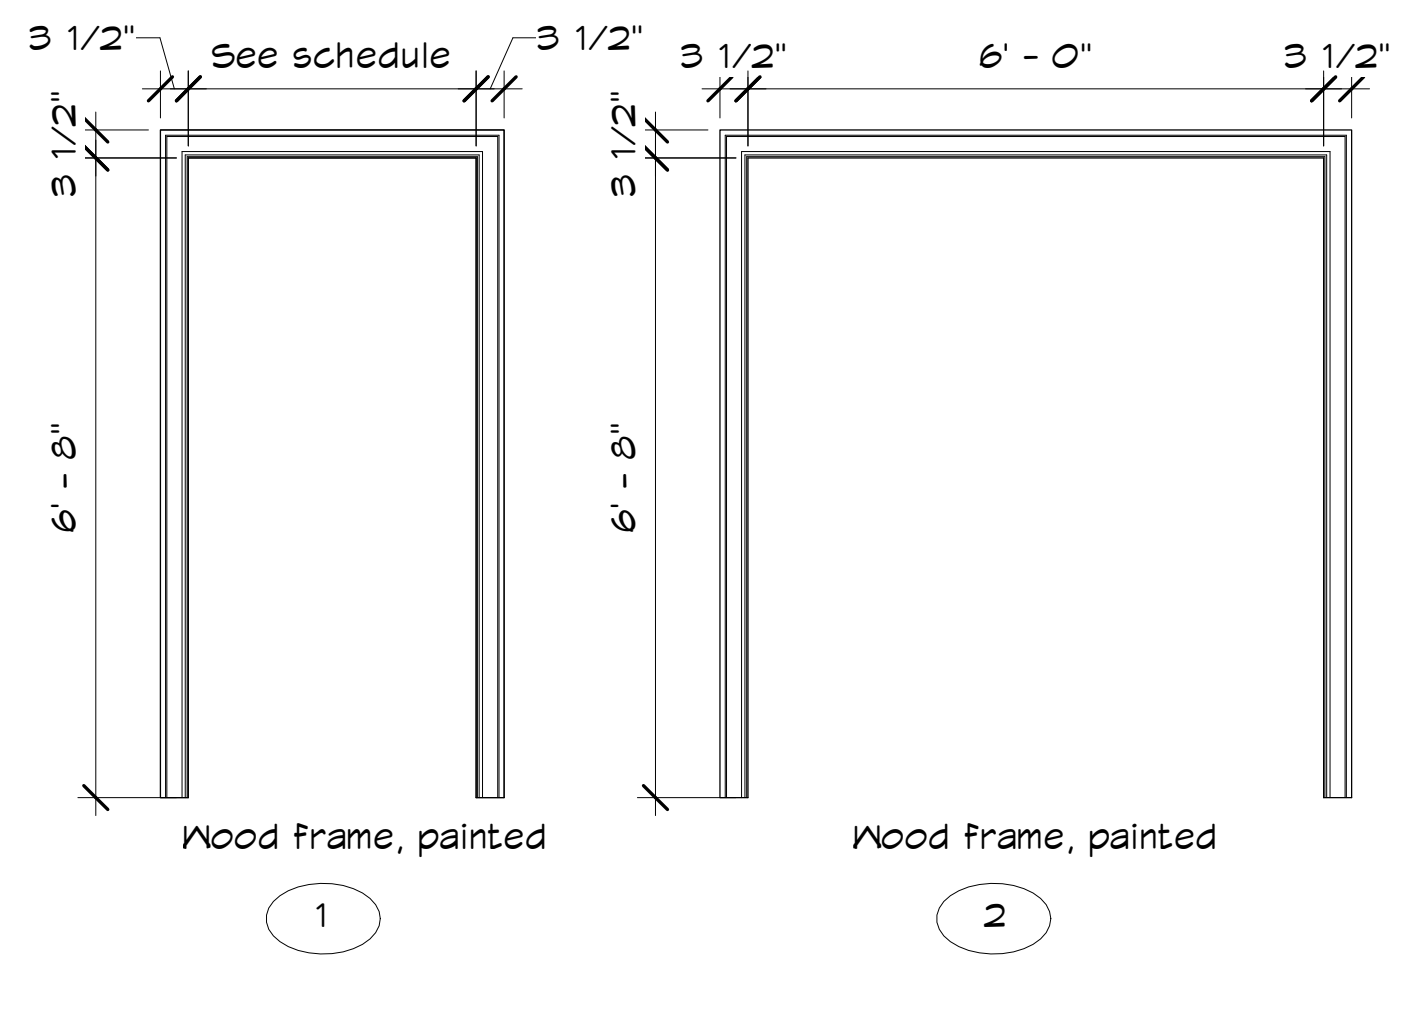

Door Legend
1/2" = 1'-0"

WINDOW TYPES

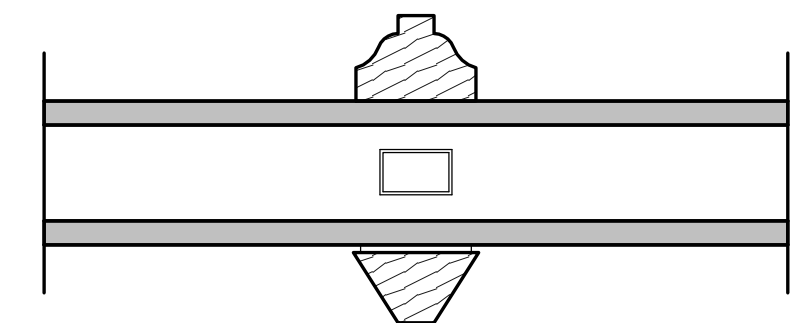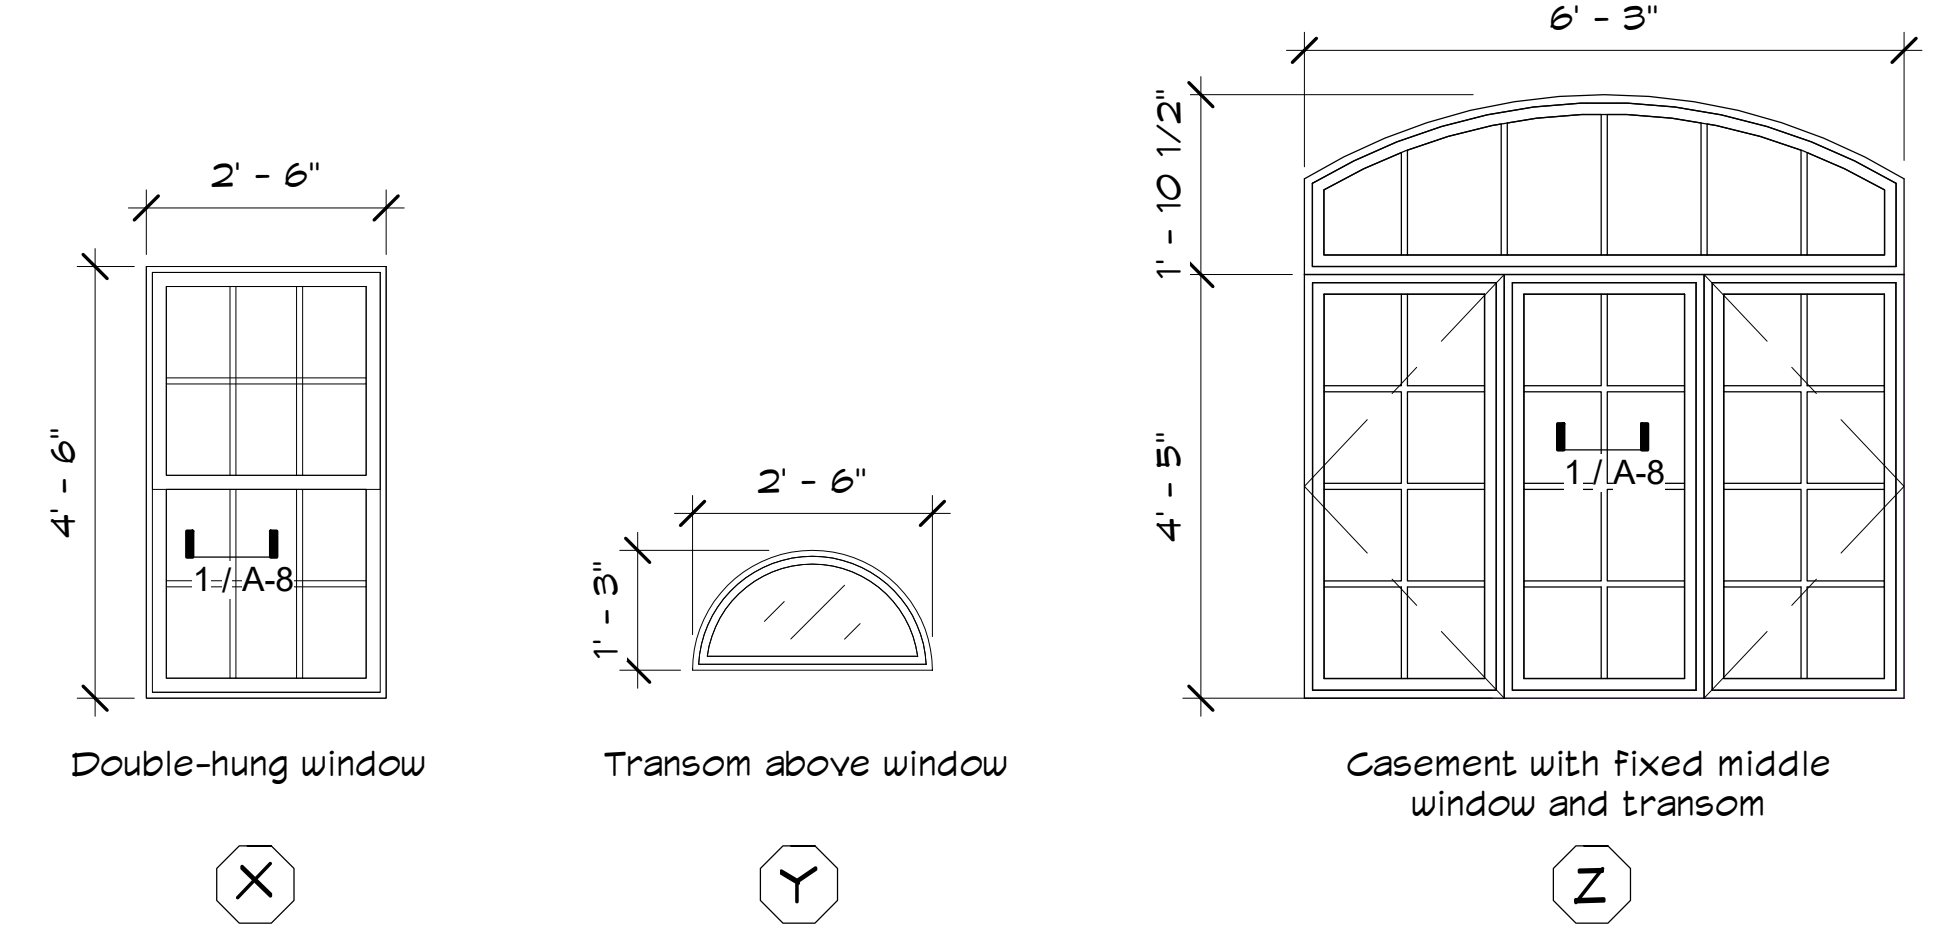

1 Divided Lites
12" = 1'-0"



Door Frame
6" = 1'-0"



IF THIS SHEET IS NOT 24 X 36 IT IS A REDUCED SCALE PRINT - SCALE ACCORDINGLY

1 3"=1'-0"
SCALE
0
2 1-1/2"=1'-0"
SCALE
0
3 1"=1'-0"
SCALE
0
6 1/2"=1'-0"
SCALE
0
12 1/4"=1'-0"
SCALE
0
20 1/8"=1'-0"
SCALE



**GIENAPP
DESIGN**
ARCHITECTURE

20 Conant Street
Danvers, MA 01923
978.750.9062
gienappdesign.com

Werth Residence
Renovation
10 Cardinal Drive, Westwood, MA


© 2017 Gienapp Design Associates, LLC
ALL RIGHTS RESERVED. ALL IDEAS, DESIGNS, PLANS
AND SPECIFICATIONS ARE THE PROPERTY OF
GIENAPP DESIGN ASSOCIATES. RIGHTS OF USE ARE
CONDITIONAL AND ARE LIMITED TO A ONE-TIME USE
TO CONSTRUCT A SINGLE PROJECT ON THE SITE SO
INDICATED. USE OF THE WORK AND ANY DERIVATIVE
WORK COVERED UNDER THIS COPYRIGHT FOR
OTHER PROJECTS IS PROHIBITED. THE USE OR
REPRODUCTION OF THESE PLANS FOR ANY OTHER
CONSTRUCTION OR PERMIT APPLICATION IS STRICTLY
PROHIBITED WITHOUT PRIOR WRITTEN PERMISSION
OF GIENAPP DESIGN ASSOCIATES AND THE
ARCHITECT WHOSE SIGNATURE AND SEAL MAY BE
AFFIXED TO THESE DRAWINGS.

Revisions	Date


Project: 622.1
Drawn by: JB
Check by: IB/DG
Date: 01/13/17
Scale: 1/4" = 1'-0"

Proposed
Mechanical
Above Attic
Space

A-9

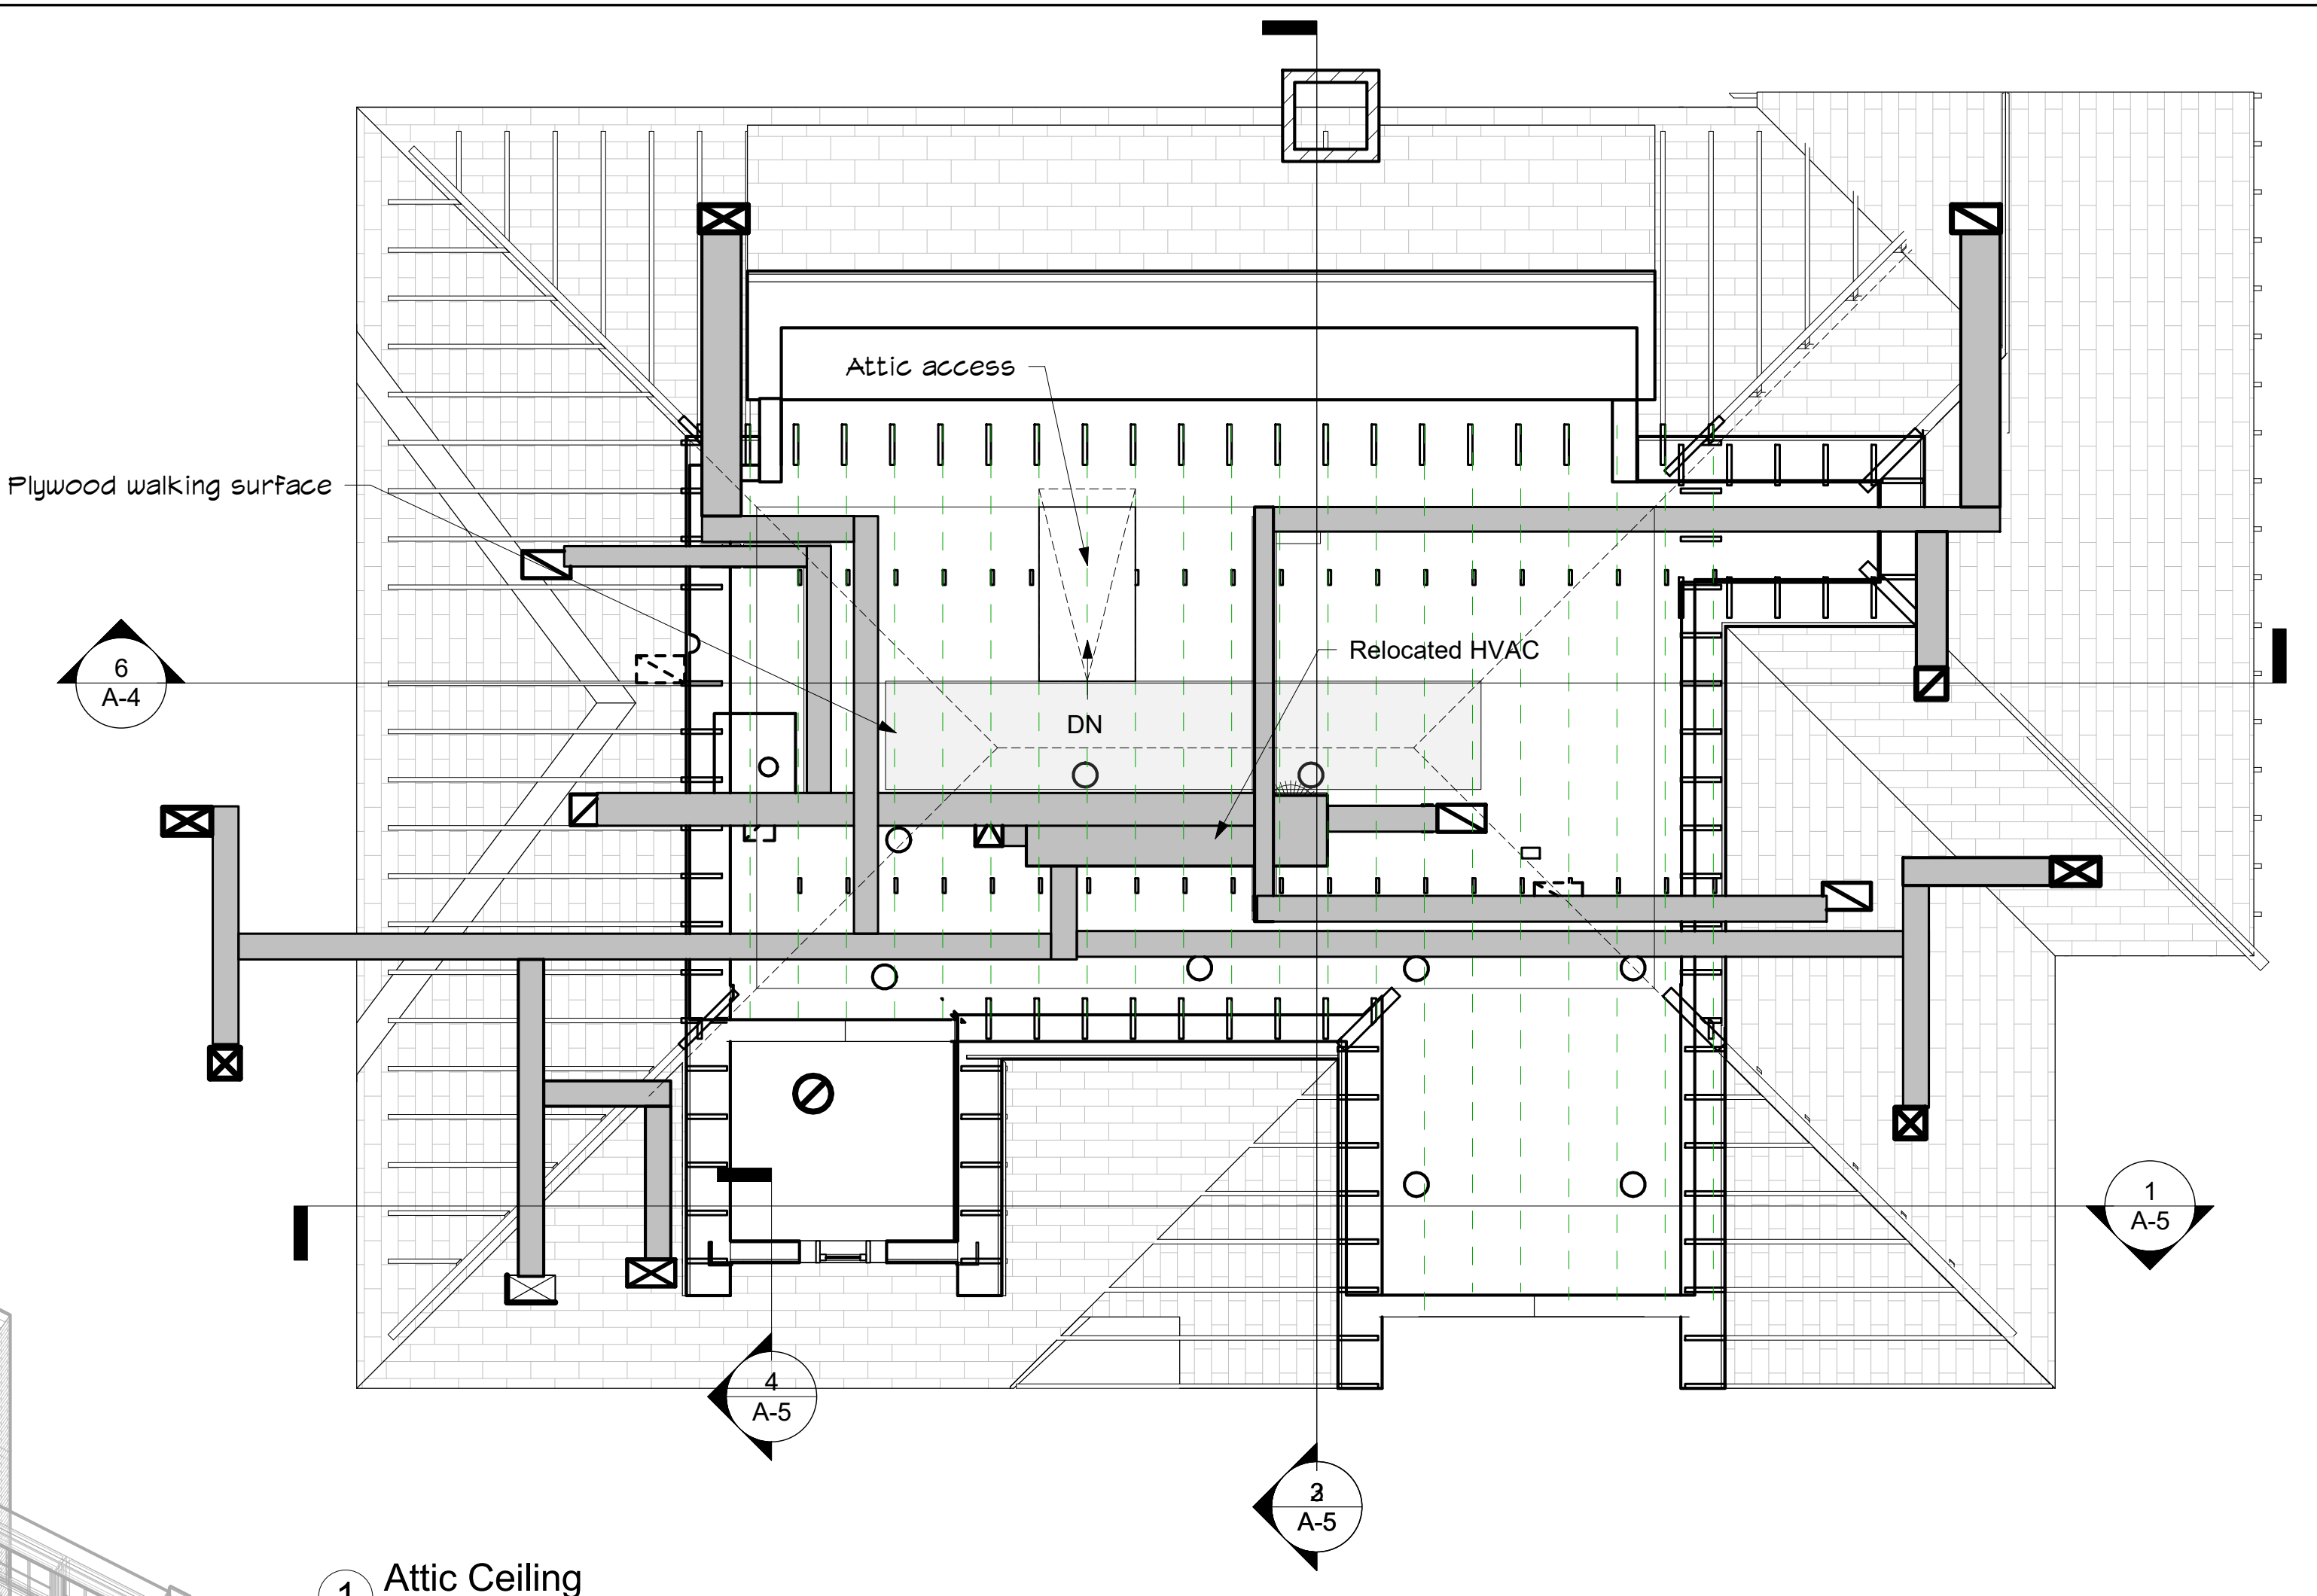

1 Attic Ceiling
1/4" = 1'-0"

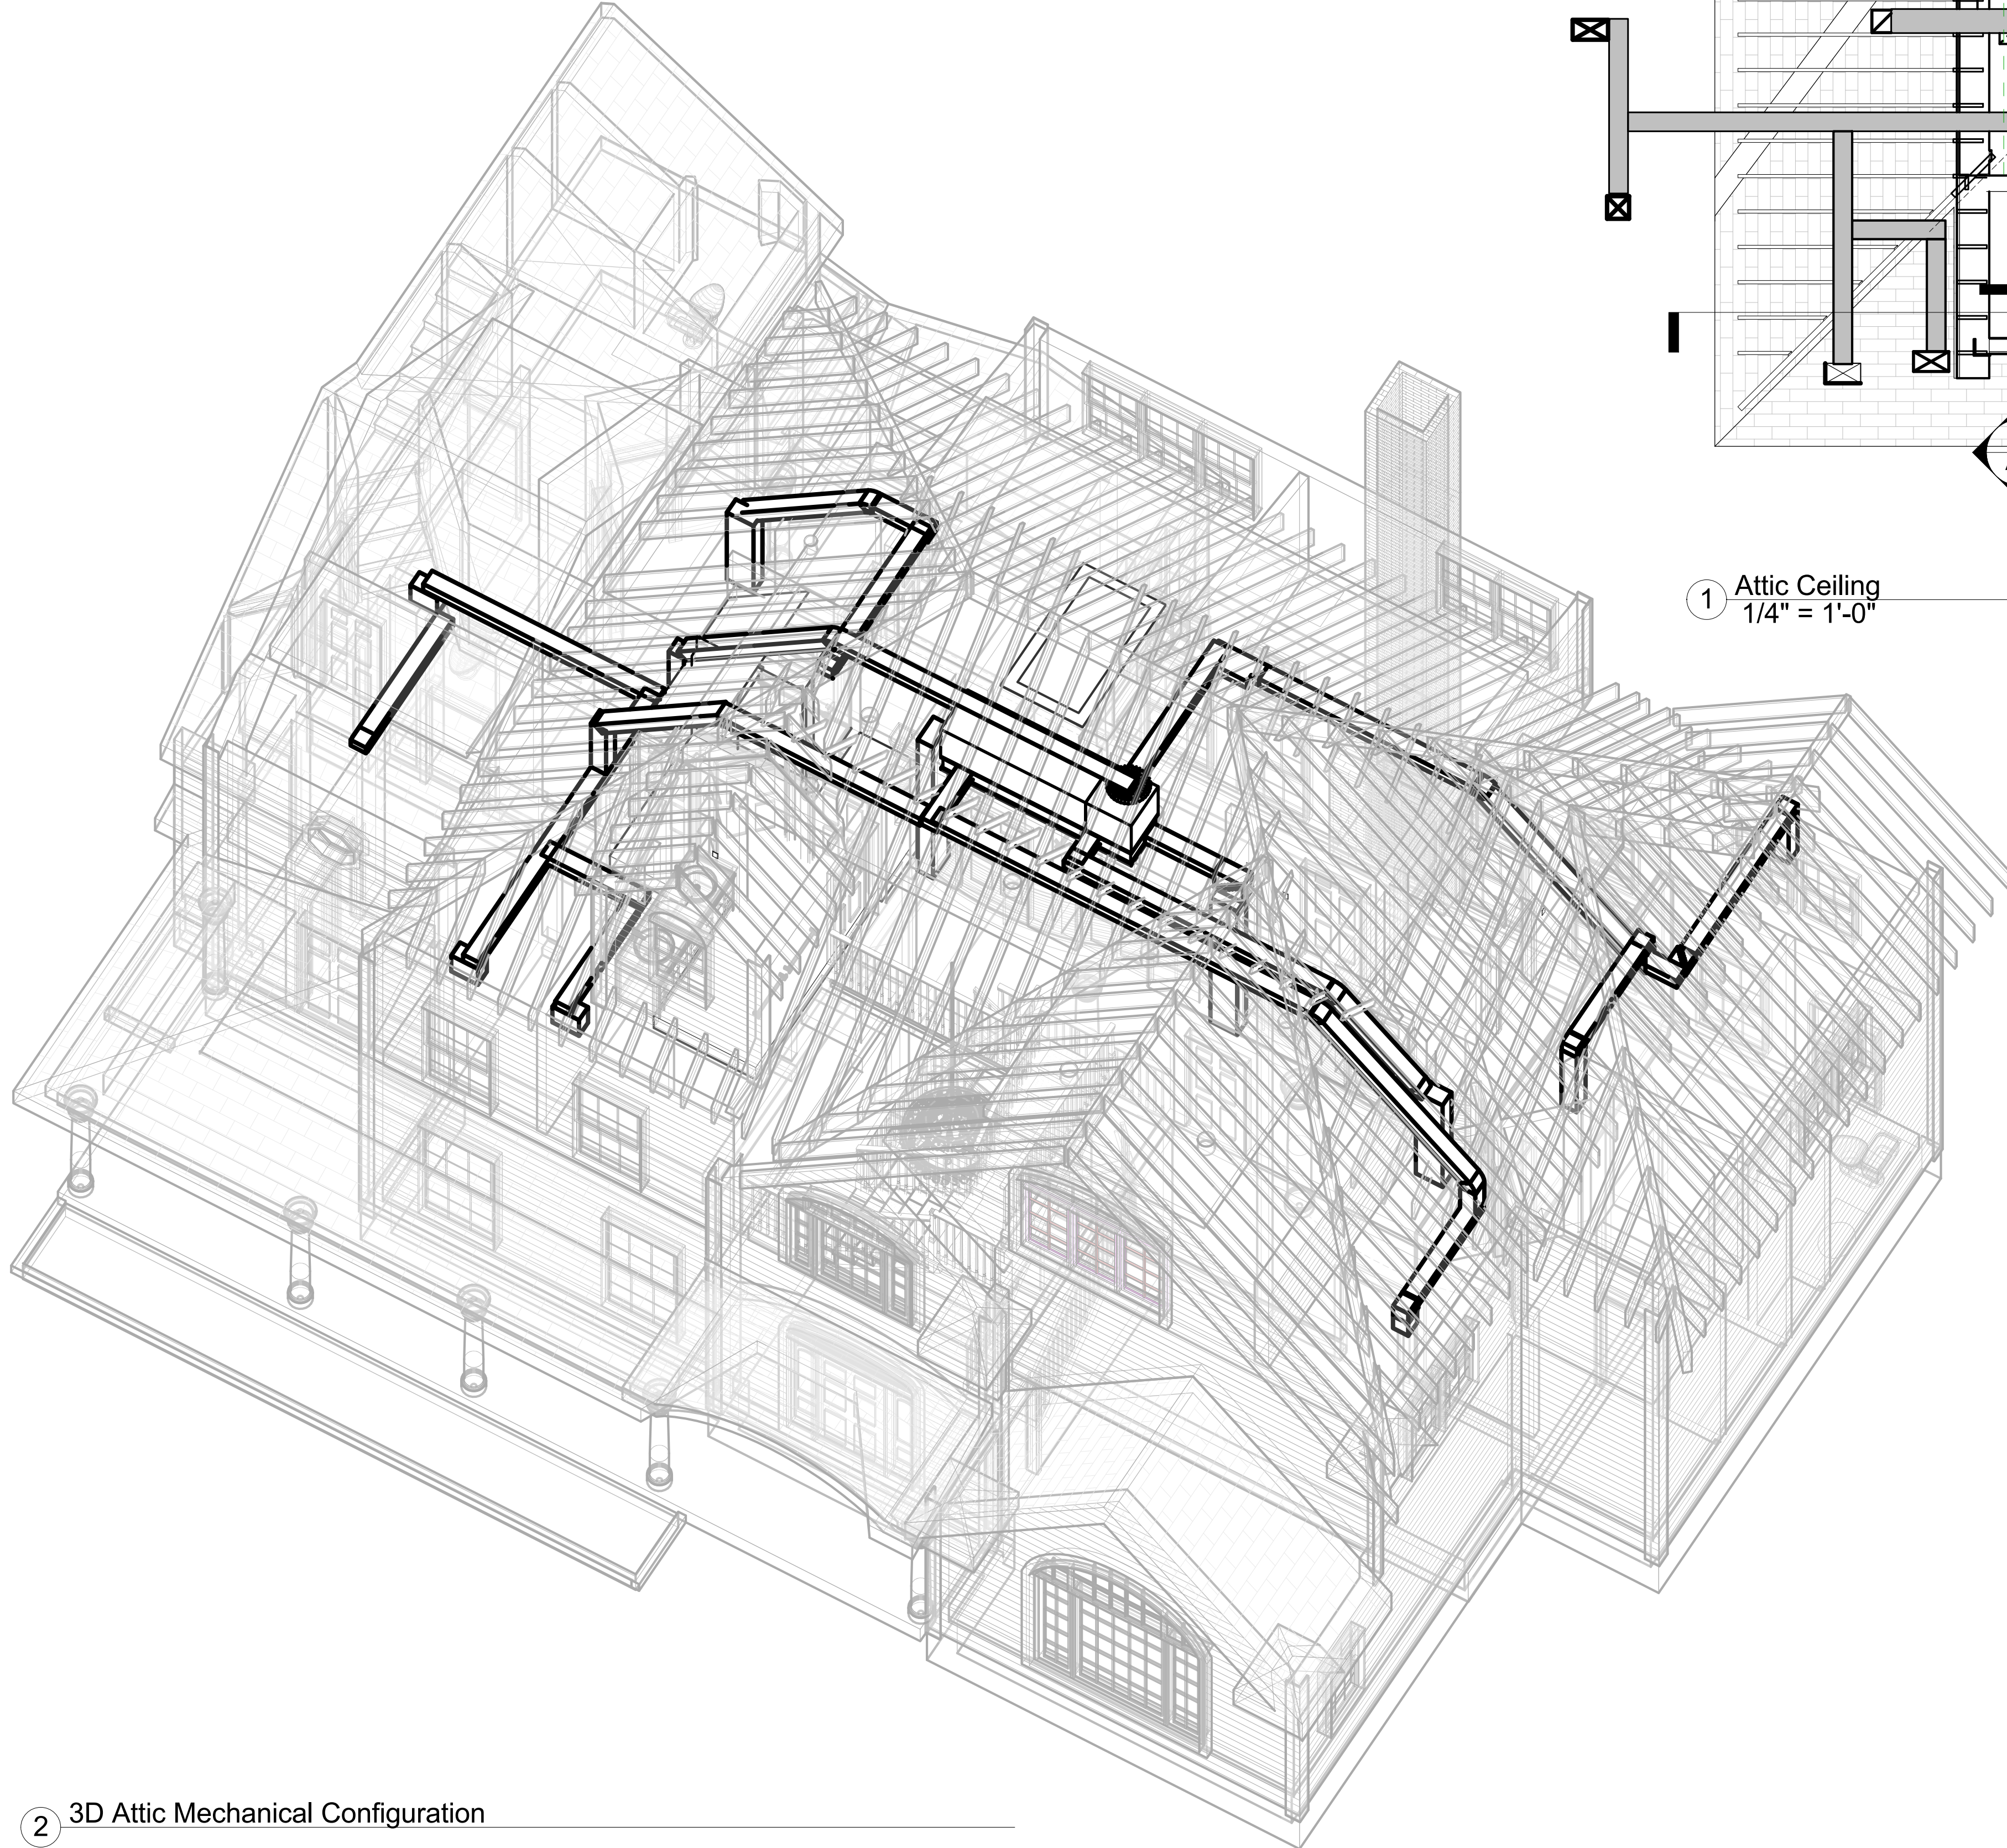

2 3D Attic Mechanical Configuration

See HVAC Drawings for more information

SCALE 1" = 1'-0" 0 1 2 3 4 5 10 20

SCALE 1/8" = 1'-0" 0 1 2 3 4 6 8 12


SCALE 1/2" = 1'-0" 0 1 2 3 6

SCALE 1" = 1'-0" 0 1 2 3

SCALE 1-1/2" = 1'-0" 0 1 2

SCALE 3" = 1'-0" 0 1

F:\01-622\021 Werth Residence\Attic Rev\021 DRAWINGS AND SPECIFICATIONS\021 Working Set\021 Werth Residence_011317.rvt

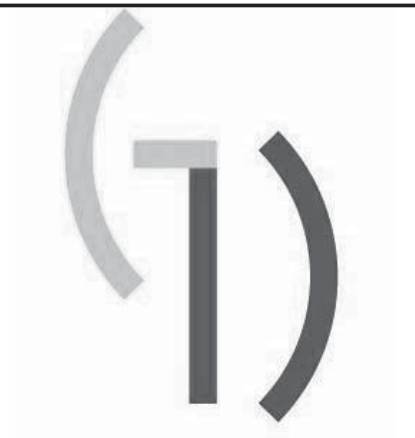

GIENAPP DESIGN ARCHITECTURE

20 Conant Street Danvers, MA 01923 978.750.9062 gienappdesign.com



01/09/2017

Werth Residence Renovation 10 Cardinal Drive, Westwood, MA

© 2015 Gienapp Design Associates, LLC ALL RIGHTS RESERVED. ALL IDEAS, DESIGN, PLANS AND SPECIFICATIONS ARE THE PROPERTY OF GIENAPP DESIGN ASSOCIATES...

Table with 2 columns: Revisions, Date

Project: 622.1 Drawn by: MAB Check by: TLH Date: 01/09/17 Scale: As indicated

Structural Noted

S-0.0

TABLE R602.3(1) FASTENER SCHEDULE FOR STRUCTURAL MEMBERS

Main fastener schedule table with columns: ITEM, DESCRIPTION OF BUILDING ELEMENTS, NUMBER AND TYPE OF FASTENER, SPACING OF FASTENERS. Includes sections for Roof, Wall, and Floor.

Detailed fastener schedule table with columns: ITEM, DESCRIPTION OF BUILDING, DESCRIPTION OF FASTENER, SPACING OF FASTENERS (Edges, Intermediate supports).

FOR SI: 1 INCH = 25.4 MM, 1 FOOT = 304.8 MM, 1 MILE PER HOUR = 0.447 M/S, 1 KSI = 6.895 MPA

- A. ALL NAILS ARE SMOOTH-COMMON, BOX OR DEFORMED SHANKS EXCEPT WHERE OTHERWISE STATED. NAILS USED FOR FRAMING AND SHEATHING CONNECTIONS SHALL HAVE MINIMUM AVERAGE BENDING YIELD STRENGTHS AS SHOWN: 80 KSI FOR SHANK DIAMETER OF 0.192 INCH (20D COMMON NAIL), 90 KSI FOR SHANK DIAMETERS LARGER THAN 0.142 INCH BUT NOT LARGER THAN 0.177 INCH, AND 100 KSI FOR SHANK DIAMETERS OF 0.142 INCH OR LESS.


STRUCTURAL DESIGN CRITERIA

- 1. THE STRUCTURAL DESIGN IS BASED ON THE 2009 INTERNATIONAL RESIDENTIAL CODE AND THE NEW HAMPSHIRE AMENDMENTS.
2. LIVE LOADS: RESIDENTIAL SLEEPING ROOMS 30 PSF, RESIDENTIAL OTHER THAN SLEEPING ROOMS 40 PSF, STAIRS 40 PSF
3. DEAD LOADS: WEIGHT OF MATERIALS ME/P PLUS MISC 3 PSF
4. SNOW LOADS: BASIC GROUND SNOW, Pg 40 PSF, FLAT ROOF SNOW, Pfl 30.8 PSF
5. WIND LOAD: BASIC WIND SPEED 100 MPH, BUILDING CATEGORY II, EXPOSURE B

CONTRACTORS RESPONSIBILITIES

- 1. G.C. TO VERIFY ALL EXISTING CONDITIONS AND DIMENSIONS IN FIELD. IF THERE ARE ANY QUESTIONS, CONSULT WITH THE ENGINEER IMMEDIATELY.
2. THE G.C. IS RESPONSIBLE FOR VISITING THE SITE AND FAMILIARIZING HIMSELF WITH THE EXISTING CONDITIONS AND THESE DRAWINGS. ANY DISCREPANCIES OR INCONSISTENCIES MUST BE BROUGHT TO THE ENGINEER'S ATTENTION BEFORE BEGINNING CONSTRUCTION.

IF THIS SHEET IS NOT 24 X 36 IT IS A REDUCED SCALE PRINT - SCALE ACCORDINGLY

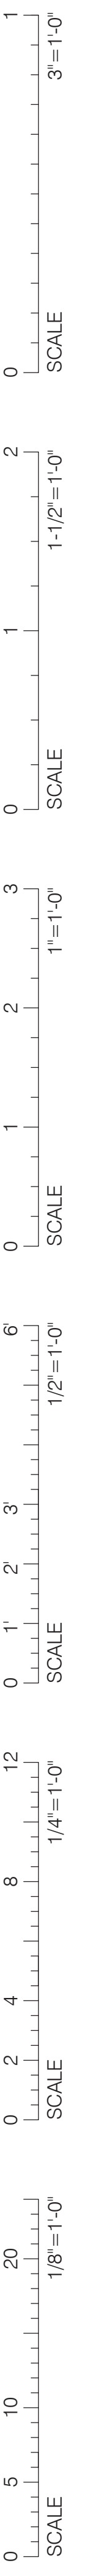



**GIENAPP
DESIGN**

ARCHITECTURE

20 Conant Street
Danvers, MA 01923
978.750.9062
gienappdesign.com



01/09/2017

Werth Residence
Renovation
10 Cardinal Drive, Westwood, MA

© 2015 Gienapp Design Associates, LLC
ALL RIGHTS RESERVED. ALL IDEAS, DESIGNS, PLANS AND SPECIFICATIONS ARE THE PROPERTY OF GIENAPP DESIGN ASSOCIATES. RIGHTS OF USE ARE CONDITIONAL AND ARE LIMITED TO A ONE TIME USE TO CONSTRUCT A SINGLE PROJECT ON THE SITE SO INDICATED. USE OF THE WORK AND ANY DERIVATIVE WORK COVERED UNDER THIS COPYRIGHT FOR OTHER PROJECTS IS PROHIBITED. THE USE OR REPRODUCTION OF THESE PLANS FOR ANY OTHER CONSTRUCTION OR PERMIT APPLICATION IS STRICTLY PROHIBITED WITHOUT PRIOR WRITTEN PERMISSION OF GIENAPP DESIGN ASSOCIATES AND THE ARCHITECT WHOSE SIGNATURE AND SEAL MAY BE AFFIXED TO THESE DRAWINGS.

Revisions	Date

Project: 622.1
Drawn by: MAB
Check by: TLH
Date: 01/09/17
Scale: As indicated

**First Floor
Framing Plan**

S-1.0

IF THIS SHEET IS NOT 24 X 36 IT IS A REDUCED SCALE PRINT - SCALE ACCORDINGLY

SCALE
0 1
3" = 1'-0"


SCALE
0 1 2
1-1/2" = 1'-0"

SCALE
0 1 2 3
1" = 1'-0"


SCALE
0 1 2 3 4 5 6
1/2" = 1'-0"

SCALE
0 1 2 3 4 6 8 12
1/4" = 1'-0"

SCALE
0 2 4 5 10 20
1/8" = 1'-0"

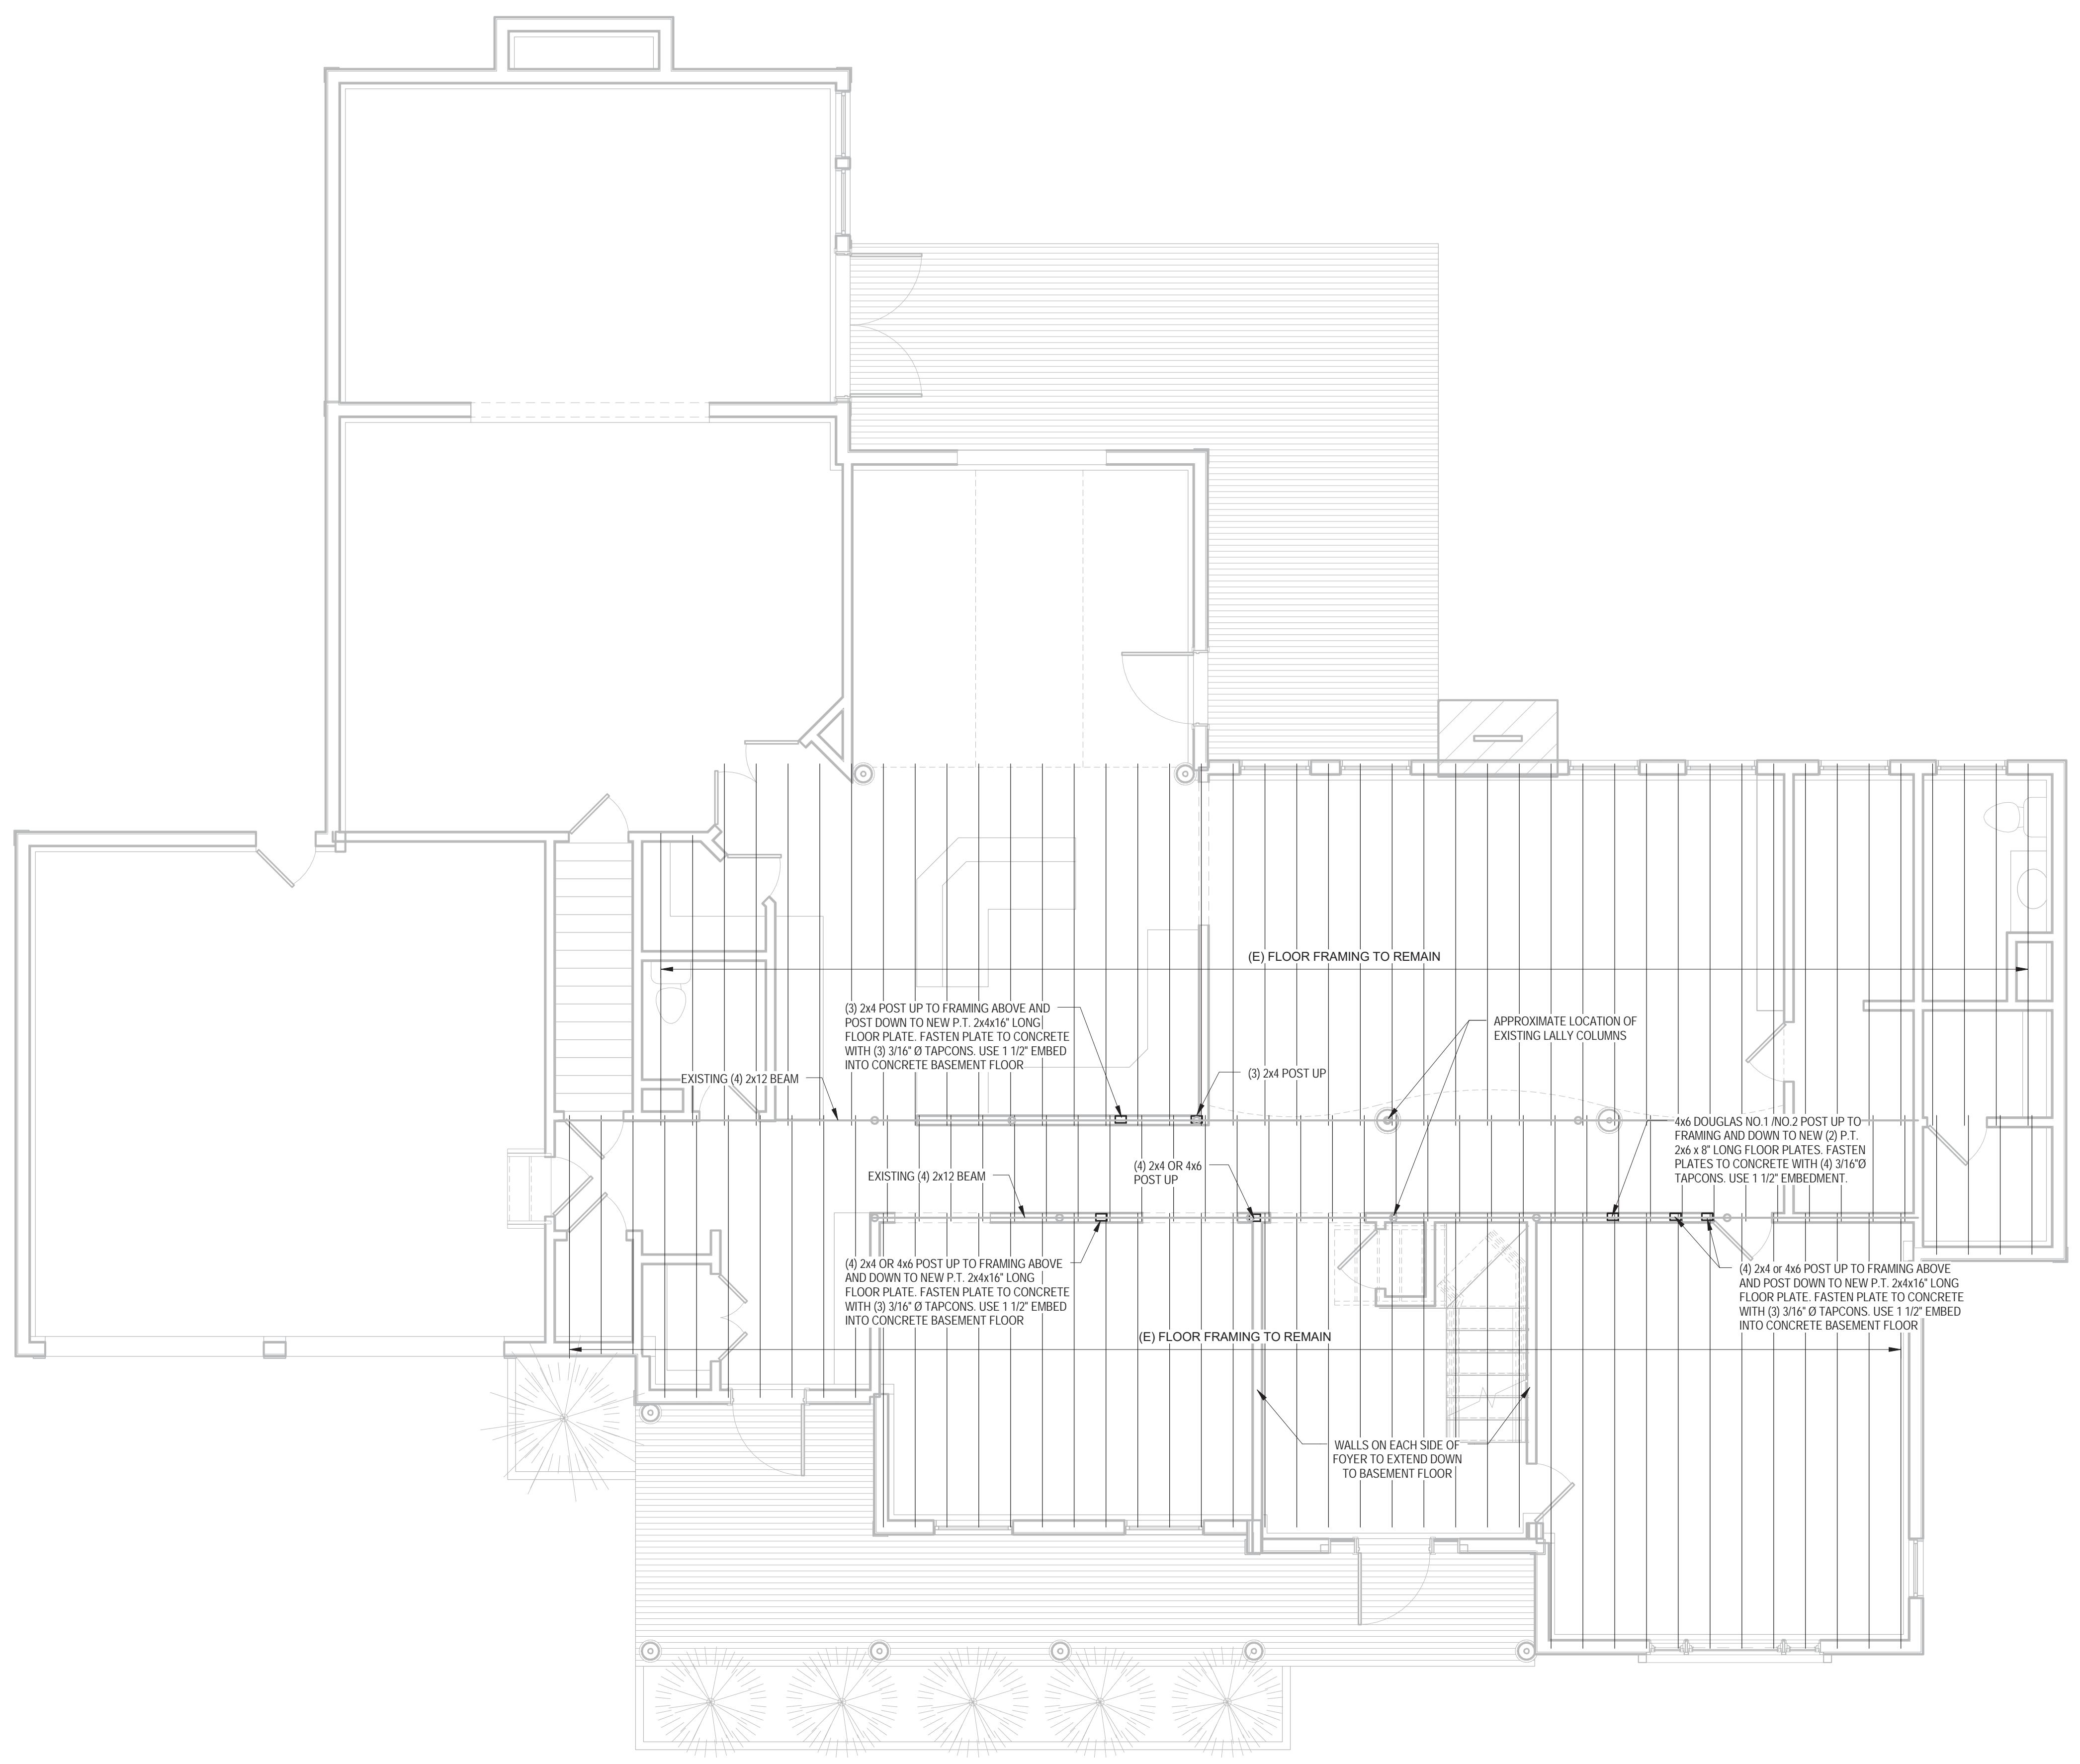

① 1ST FLOOR PARTIAL FRAMING PLAN
1/4" = 1'-0"

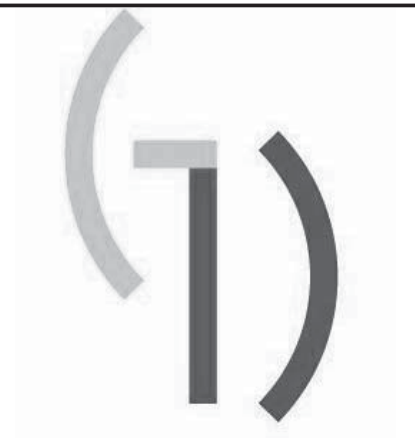

**GIENAPP
DESIGN**

ARCHITECTURE

20 Conant Street
Danvers, MA 01923
978.750.9062
gienappdesign.com



01/09/2017

Werth Residence
Renovation
10 Cardinal Drive, Westwood, MA

© 2015 Gienapp Design Associates, LLC
ALL RIGHTS RESERVED. ALL IDEAS, DESIGNS, PLANS AND SPECIFICATIONS ARE THE PROPERTY OF GIENAPP DESIGN ASSOCIATES. RIGHTS OF USE ARE CONDITIONAL AND ARE LIMITED TO A ONE-TIME USE TO CONSTRUCT A SINGLE PROJECT ON THE SITE SO INDICATED. USE OF THE WORK AND ANY DERIVATIVE WORK COVERED UNDER THIS COPYRIGHT FOR OTHER PROJECTS IS PROHIBITED. THE USE OR REPRODUCTION OF THESE PLANS FOR ANY OTHER CONSTRUCTION OR PERMIT APPLICATION IS STRICTLY PROHIBITED WITHOUT WRITTEN PERMISSION OF GIENAPP DESIGN ASSOCIATES AND THE ARCHITECT WHOSE SIGNATURE AND SEAL MAY BE AFFIXED TO THESE DRAWINGS.

Revisions	Date

Project: 622.1
Drawn by: MAB
Check by: TLH
Date: 01/09/17
Scale: As indicated

Second Floor Framing Plan

S-2.0

IF THIS SHEET IS NOT 24 X 36 IT IS A REDUCED SCALE PRINT - SCALE ACCORDINGLY

SCALE 1"=1'-0"


SCALE 1-1/2"=1'-0"

SCALE 1"=1'-0"

SCALE 1/2"=1'-0"


SCALE 1/4"=1'-0"

SCALE 1/8"=1'-0"

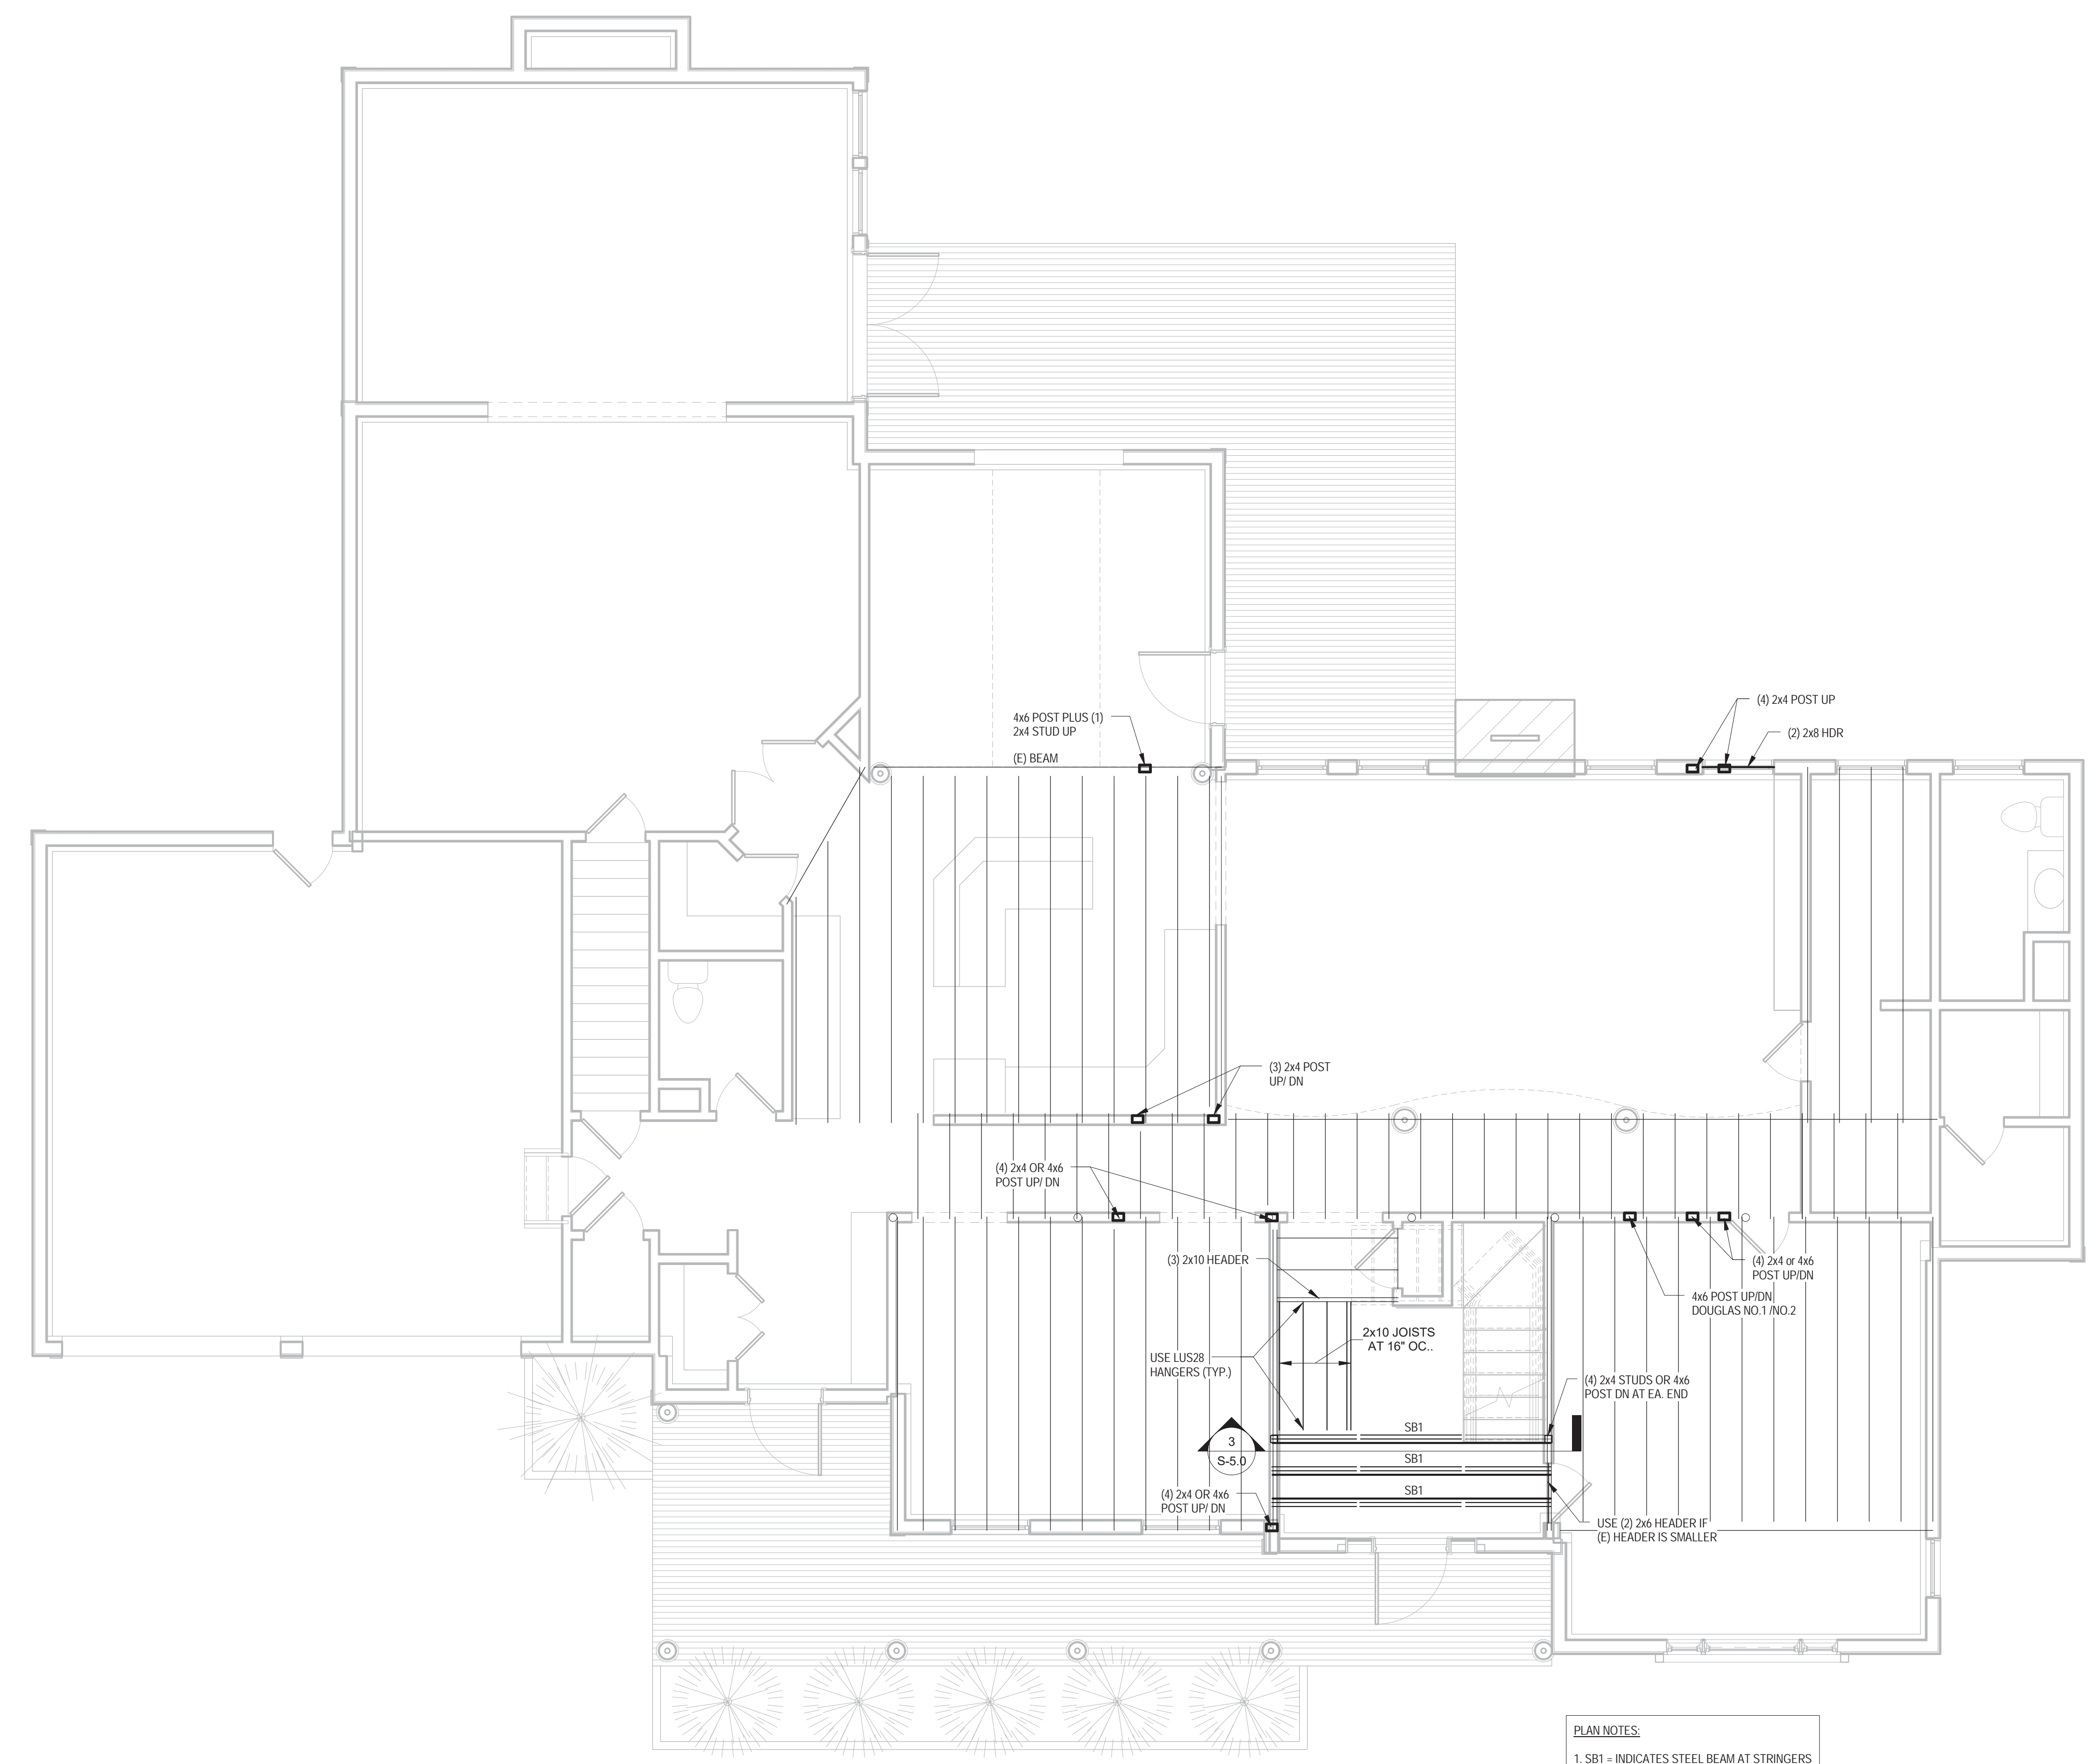

PLAN NOTES:
1. SB1 - INDICATES STEEL BEAM AT STRINGERS

① 2ND FLOOR PARTIAL FRAMING PLAN
1/4" = 1'-0"

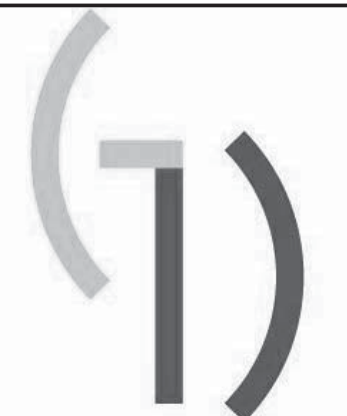

GIENAPP DESIGN

ARCHITECTURE

20 Conant Street
Danvers, MA 01923
978.750.9062
gienappdesign.com



01/09/2017

Werth Residence Renovation 10 Cardinal Drive, Westwood, MA

© 2015 Gienapp Design Associates, LLC
ALL RIGHTS RESERVED. ALL IDEAS, DESIGNS, PLANS AND SPECIFICATIONS ARE THE PROPERTY OF GIENAPP DESIGN ASSOCIATES. RIGHTS OF USE ARE CONDITIONAL AND ARE LIMITED TO A ONE TIME USE TO CONSTRUCT A SINGLE PROJECT ON THE SITE SO INDICATED. USE OF THE WORK AND ANY DERIVATIVE WORK COVERED UNDER THIS COPYRIGHT FOR OTHER PROJECTS IS PROHIBITED. THE USE OR REPRODUCTION OF THESE PLANS FOR ANY OTHER CONSTRUCTION OR PERMIT APPLICATION IS STRICTLY PROHIBITED WITHOUT WRITTEN PERMISSION OF GIENAPP DESIGN ASSOCIATES AND THE ARCHITECT WHOSE SIGNATURE AND SEAL MAY BE AFFIXED TO THESE DRAWINGS.


Revisions	Date

Project: 622.1
 Drawn by: MAB
 Check by: TLH
 Date: 01/09/17
 Scale: As indicated

Attic Framing Plan


S-3.0

IF THIS SHEET IS NOT 24 X 36 IT IS A REDUCED SCALE PRINT - SCALE ACCORDINGLY
 SCALE 3" = 1'-0"
 SCALE 1-1/2" = 1'-0"
 SCALE 1" = 1'-0"
 SCALE 1/2" = 1'-0"
 SCALE 1/4" = 1'-0"
 SCALE 1/8" = 1'-0"
 SCALE 1/8" = 1'-0"

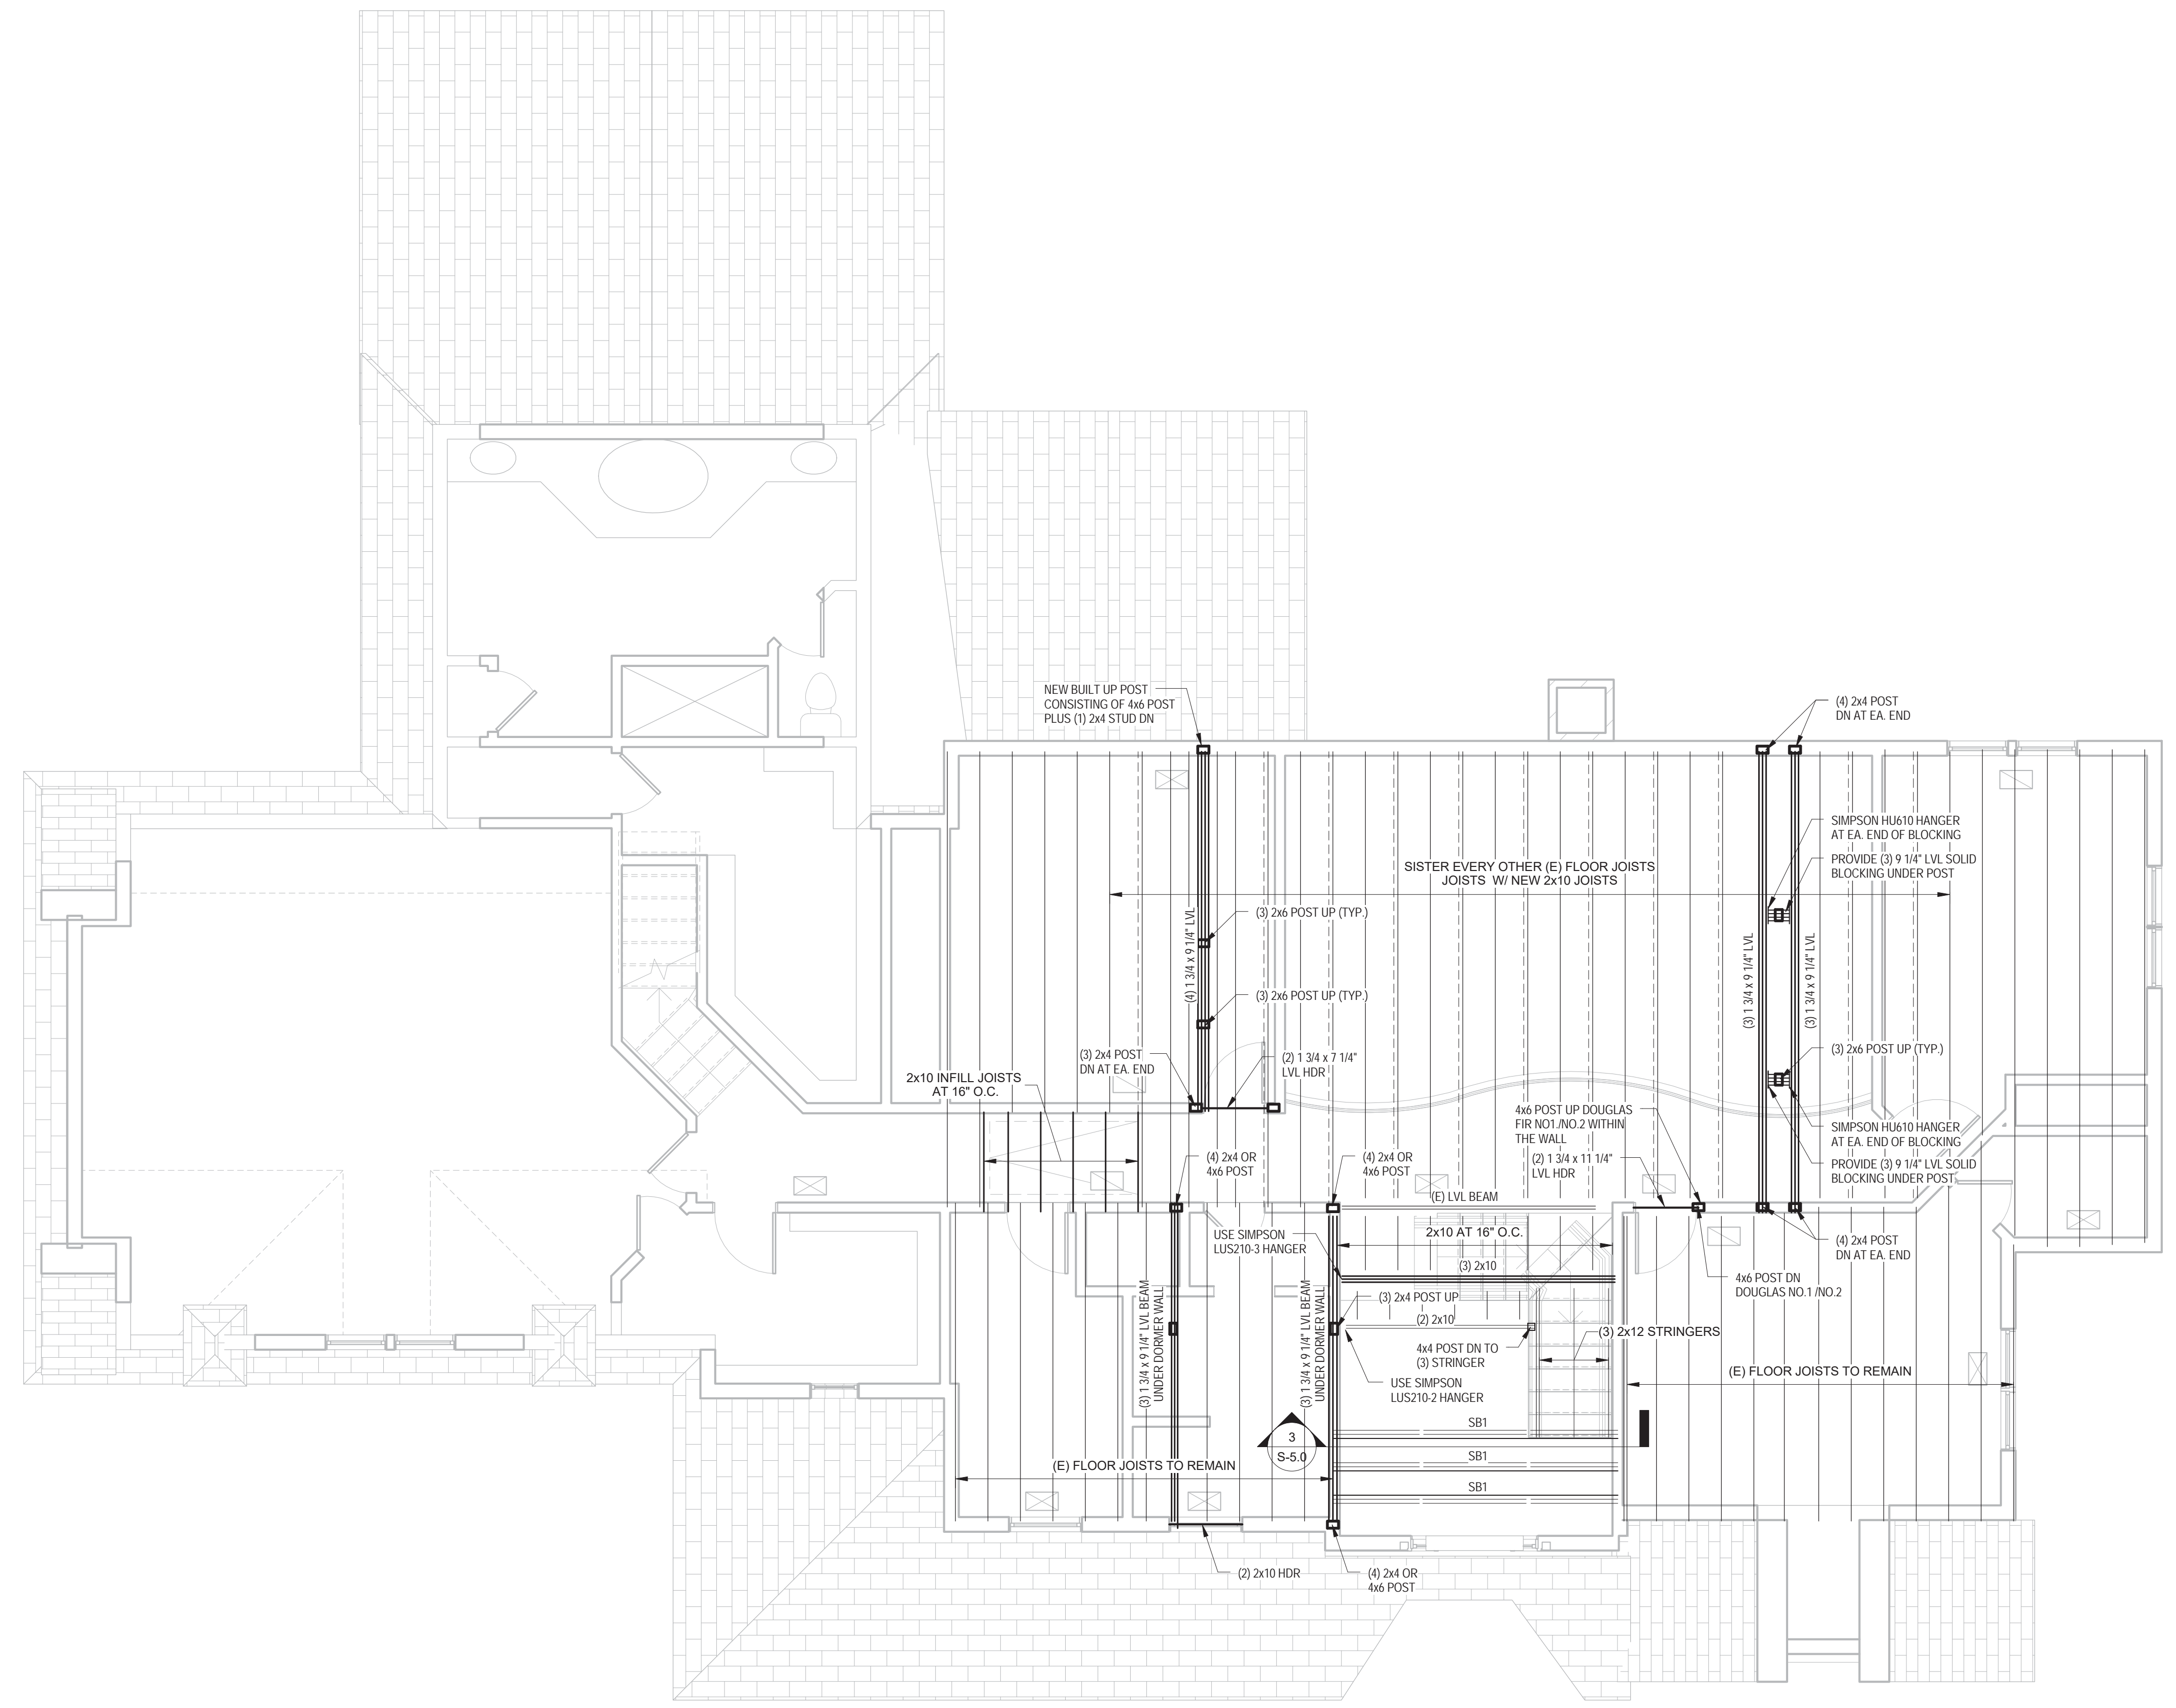

PLAN NOTES:
 1. SB1 = INDICATES STEEL BEAM AT STRINGERS

1 NEW ATTIC FRAMING PLAN
 1/4" = 1'-0"

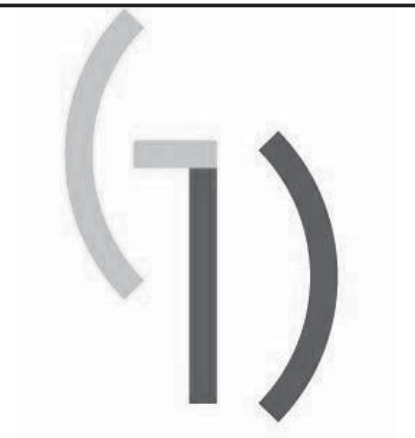

**GIENAPP
DESIGN**

ARCHITECTURE

20 Conant Street
Danvers, MA 01923
978.750.9062
gienappdesign.com



01/09/2017

Werth Residence Renovation 10 Cardinal Drive, Westwood, MA

© 2015 Gienapp Design Associates, LLC
ALL RIGHTS RESERVED. ALL IDEAS, DESIGNS, PLANS AND SPECIFICATIONS ARE THE PROPERTY OF GIENAPP DESIGN ASSOCIATES. RIGHTS OF USE ARE CONDITIONAL AND ARE LIMITED TO A ONE TIME USE TO CONSTRUCT A SINGLE PROJECT ON THE SITE SO INDICATED. USE OF THE WORK AND ANY DERIVATIVE WORK COVERED BY THIS AGREEMENT FOR OTHER PROJECTS IS PROHIBITED. THE USE OR REPRODUCTION OF THESE PLANS FOR ANY OTHER CONSTRUCTION OR PERMIT APPLICATION IS STRICTLY PROHIBITED WITHOUT WRITTEN PERMISSION OF GIENAPP DESIGN ASSOCIATES AND THE ARCHITECT WHOSE SIGNATURE AND SEAL MAY BE AFFIXED TO THESE DRAWINGS.

Revisions	Date


Project: 622.1
 Drawn by: MAB
 Check by: TLH
 Date: 01/09/17
 Scale: As indicated

Roof Framing Plan

S-4.0

IF THIS SHEET IS NOT 24 X 36 IT IS A REDUCED SCALE PRINT - SCALE ACCORDINGLY







SCALE 1"=1'-0"
 SCALE 1-1/2"=1'-0"
 SCALE 1"=1'-0"
 SCALE 1/2"=1'-0"
 SCALE 1/4"=1'-0"
 SCALE 1/8"=1'-0"

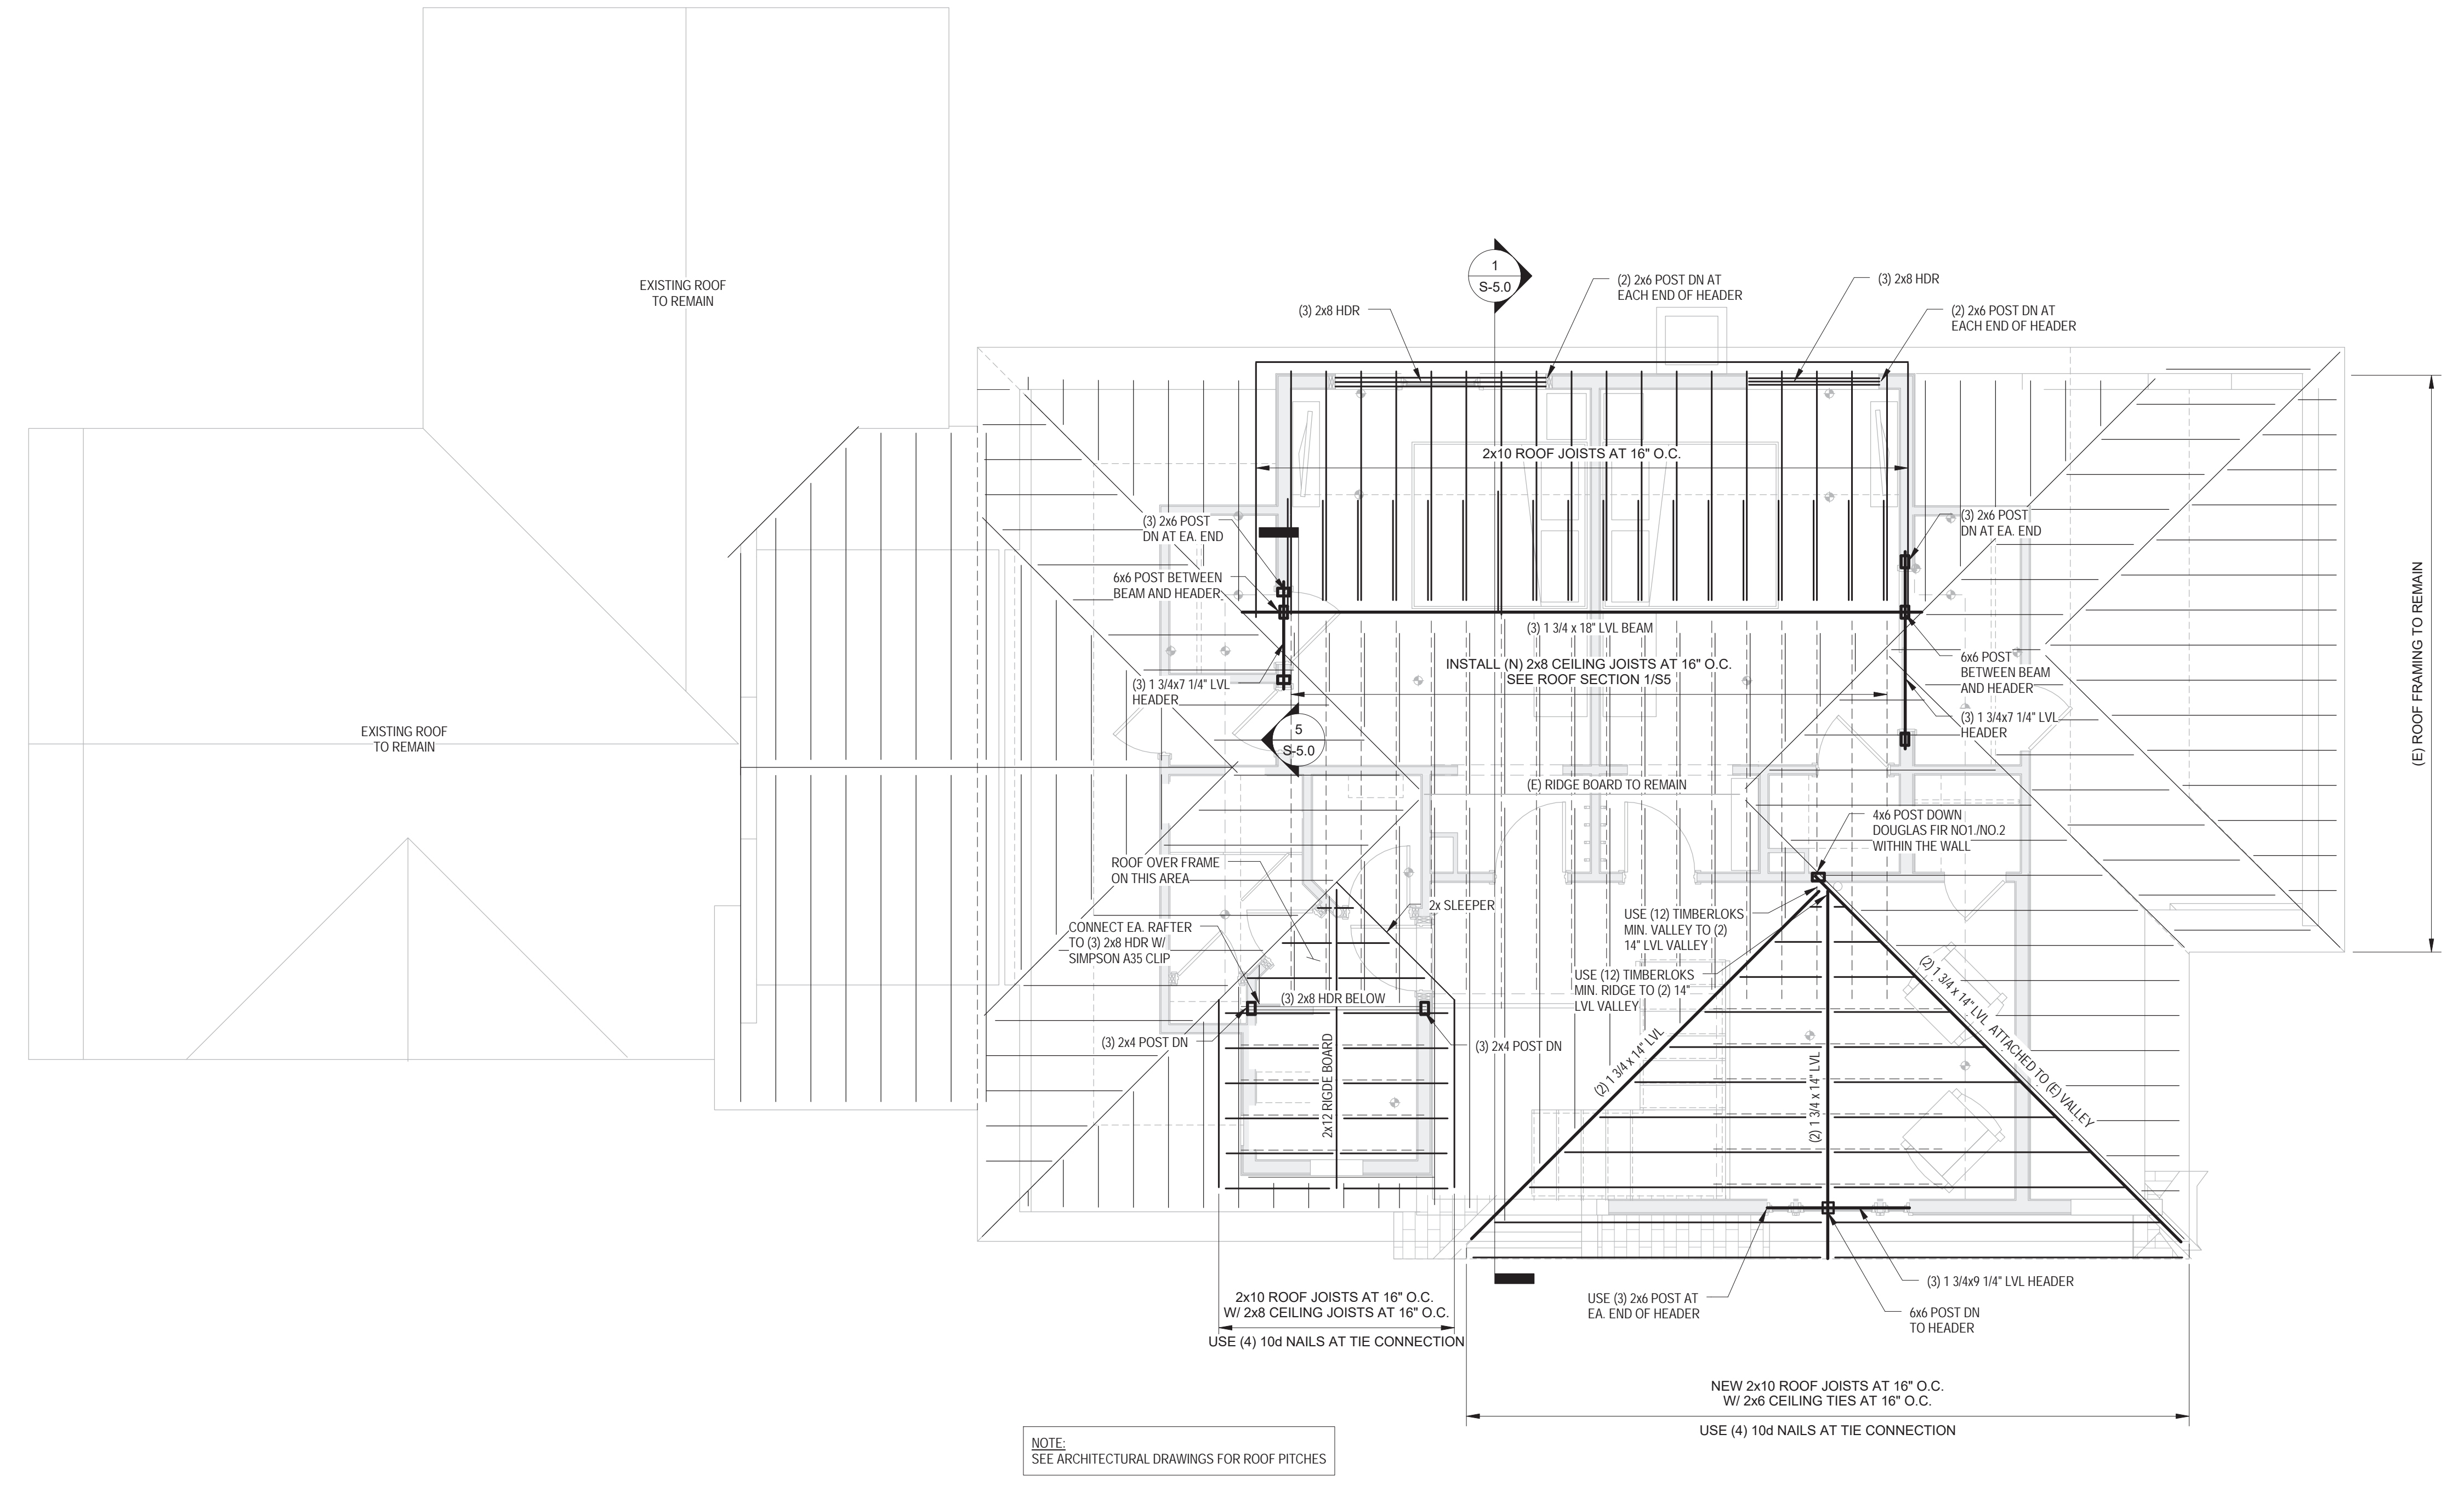

1 NEW PARTIAL ROOF FRAMING PLAN
1/4" = 1'-0"

C:\Users\gjenapp\Documents\031_Dwgs\Revit\Drawings\017_2016_01_09_17_S-4.0_Roof Framing Plan.dwg

IF THIS SHEET IS NOT 24 X 36 IT IS A REDUCED SCALE PRINT - SCALE ACCORDINGLY

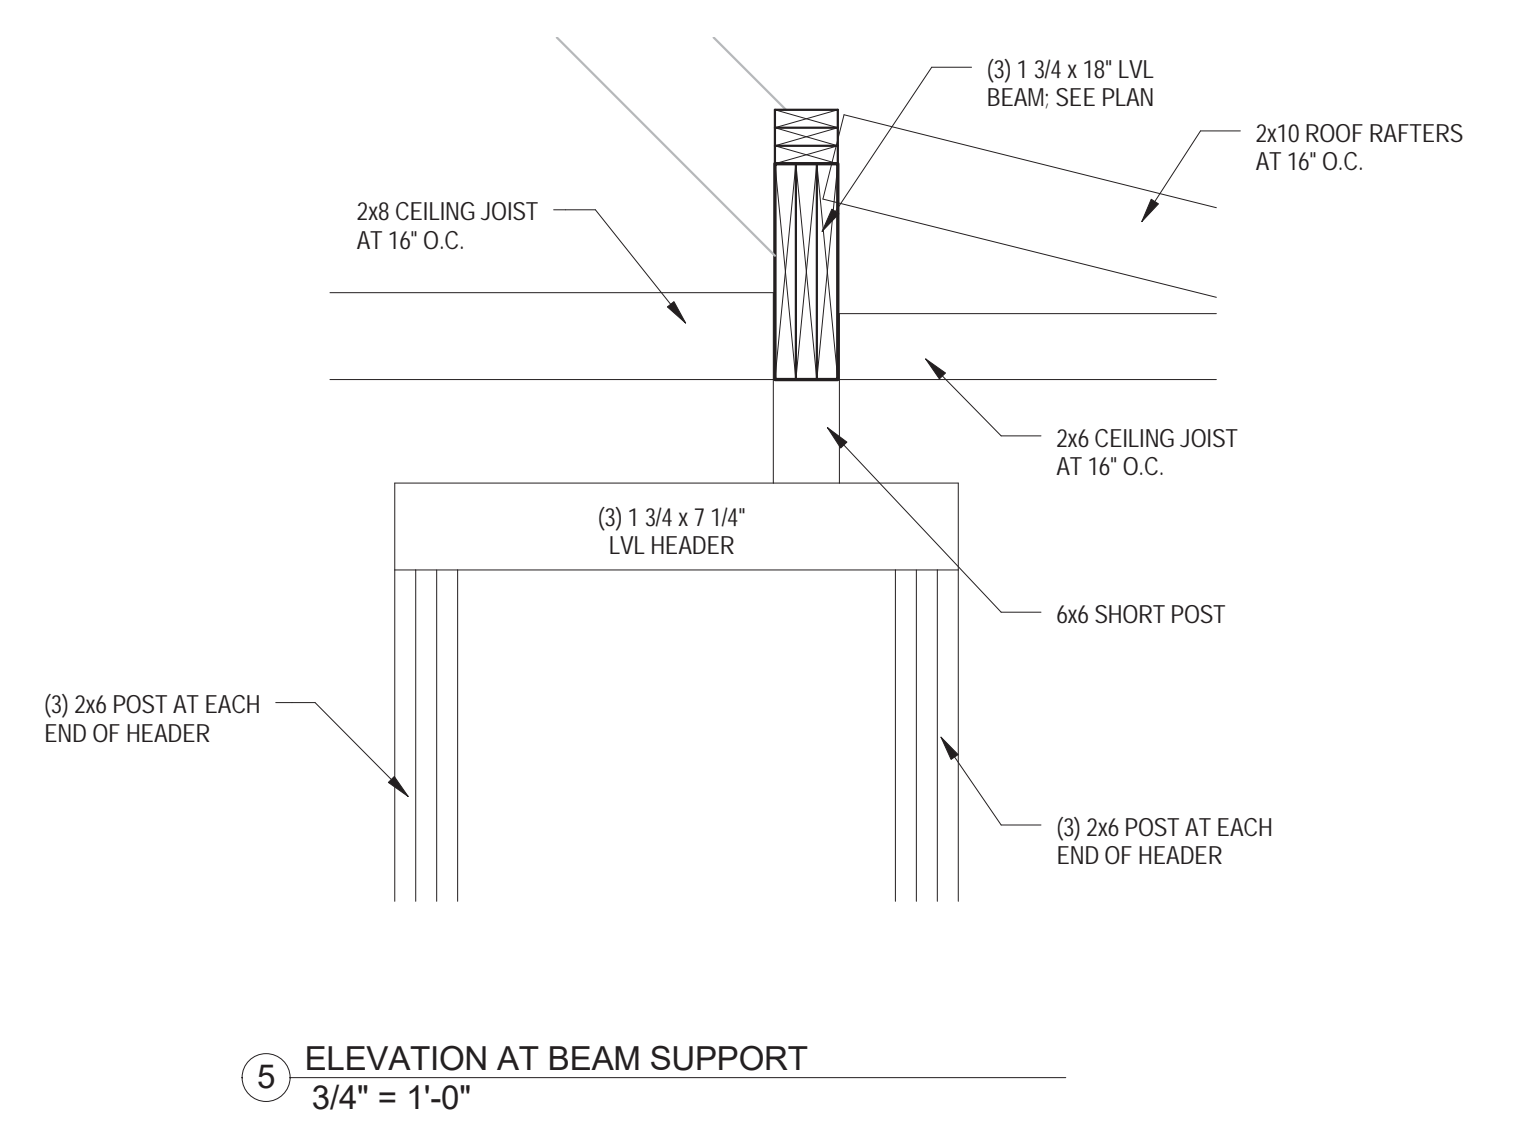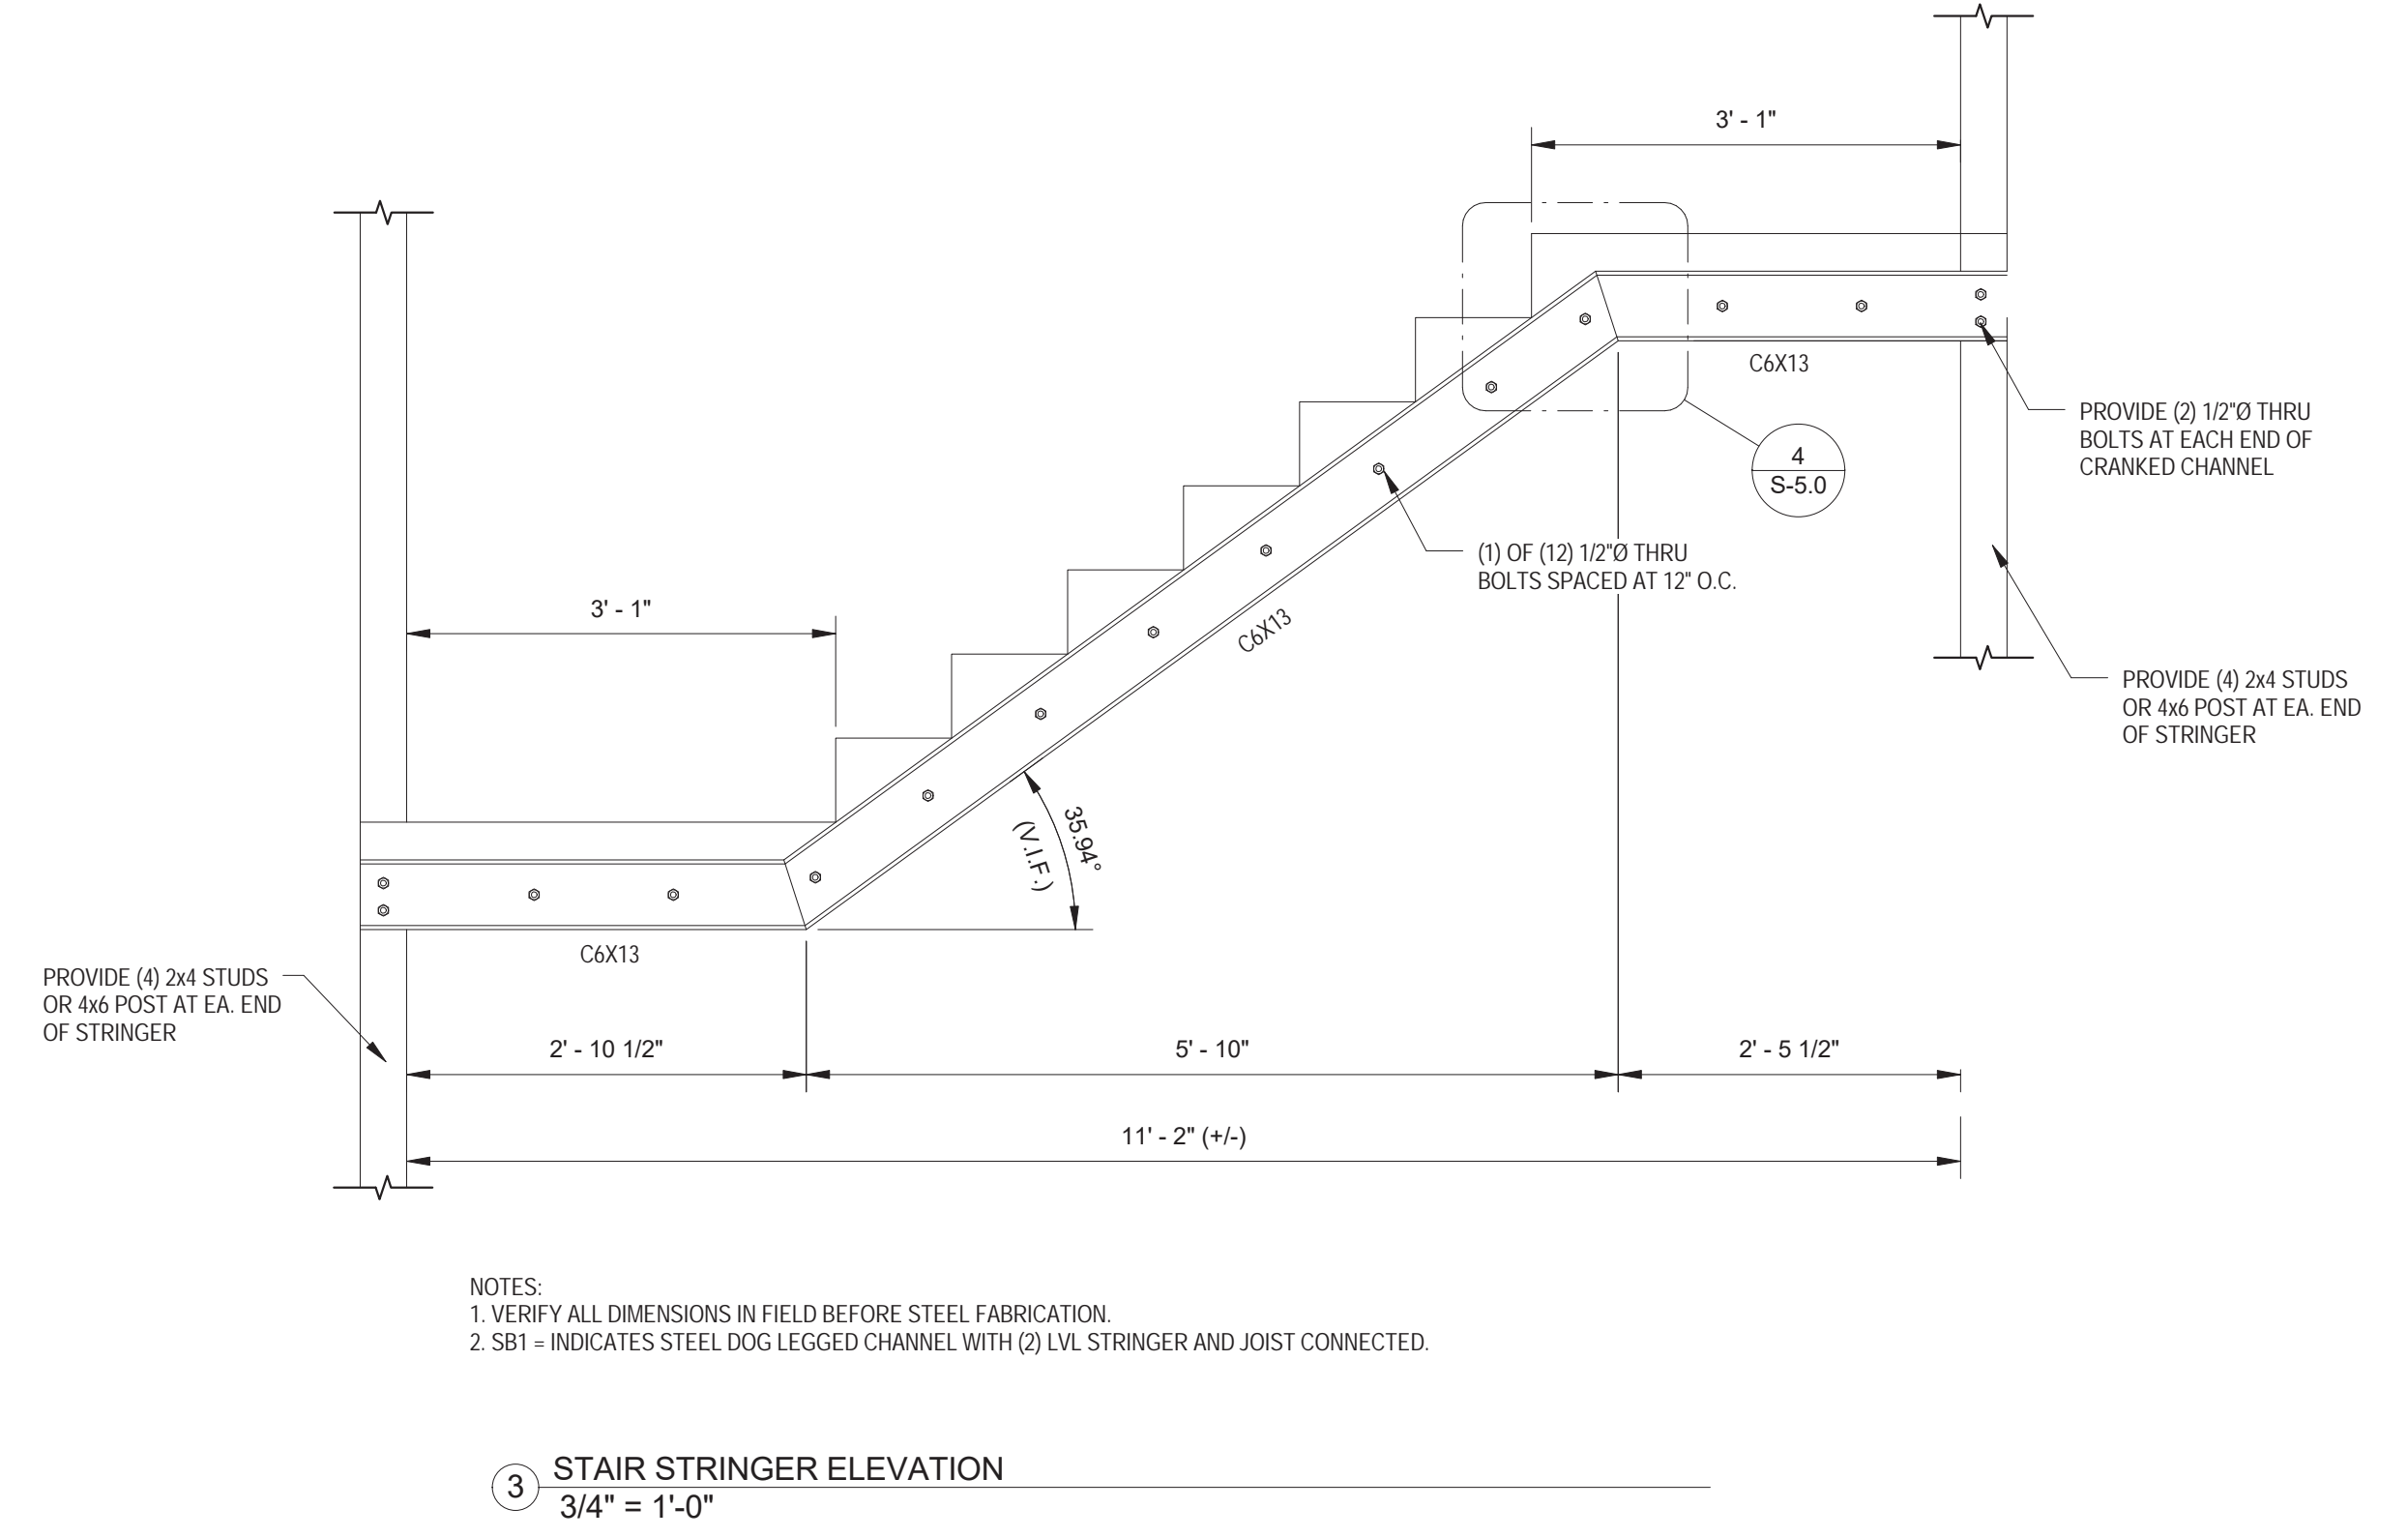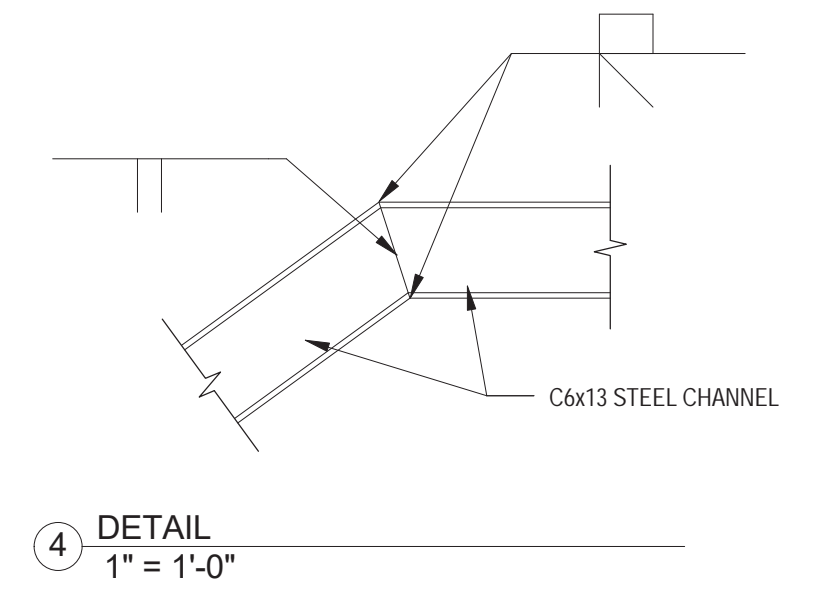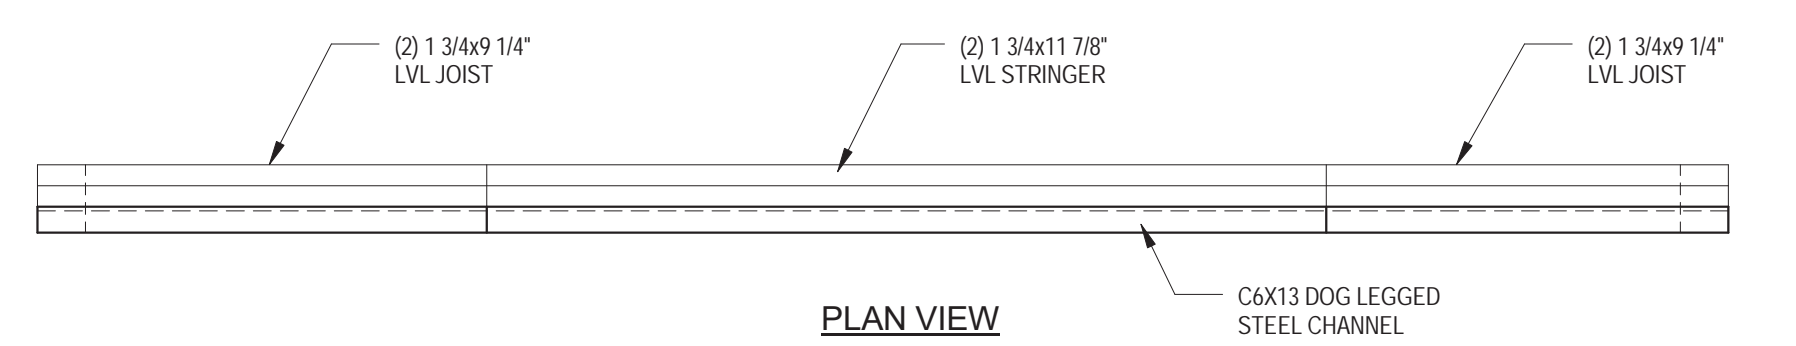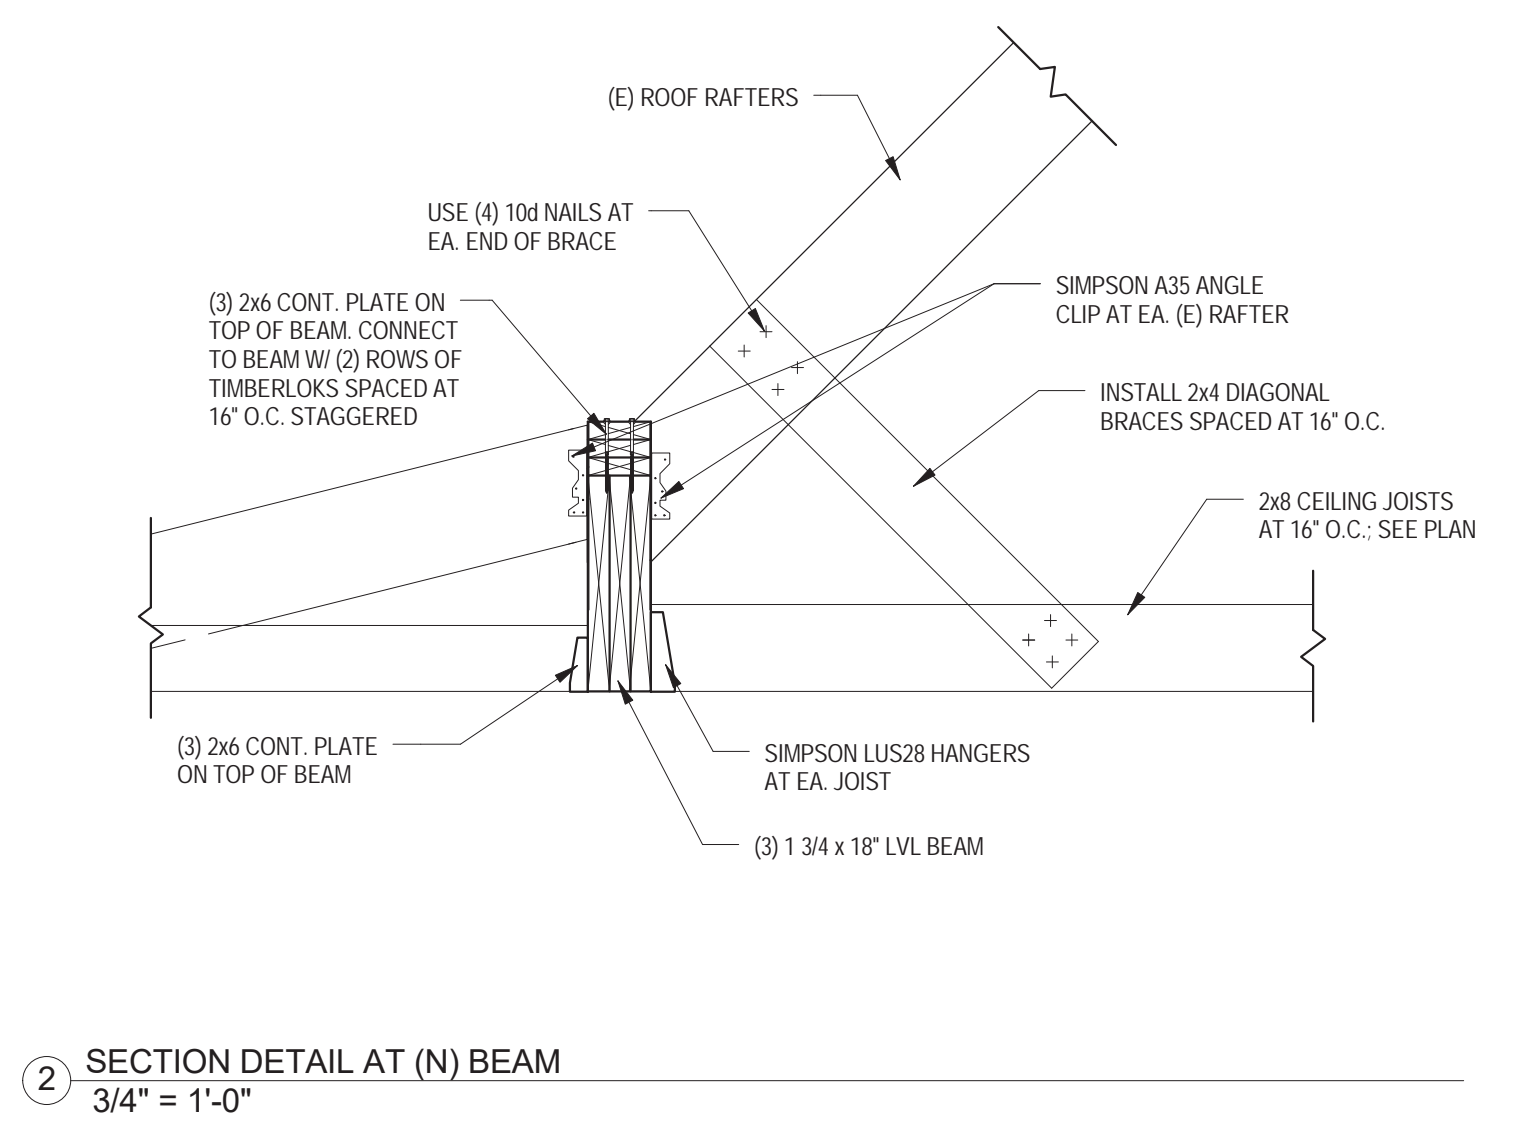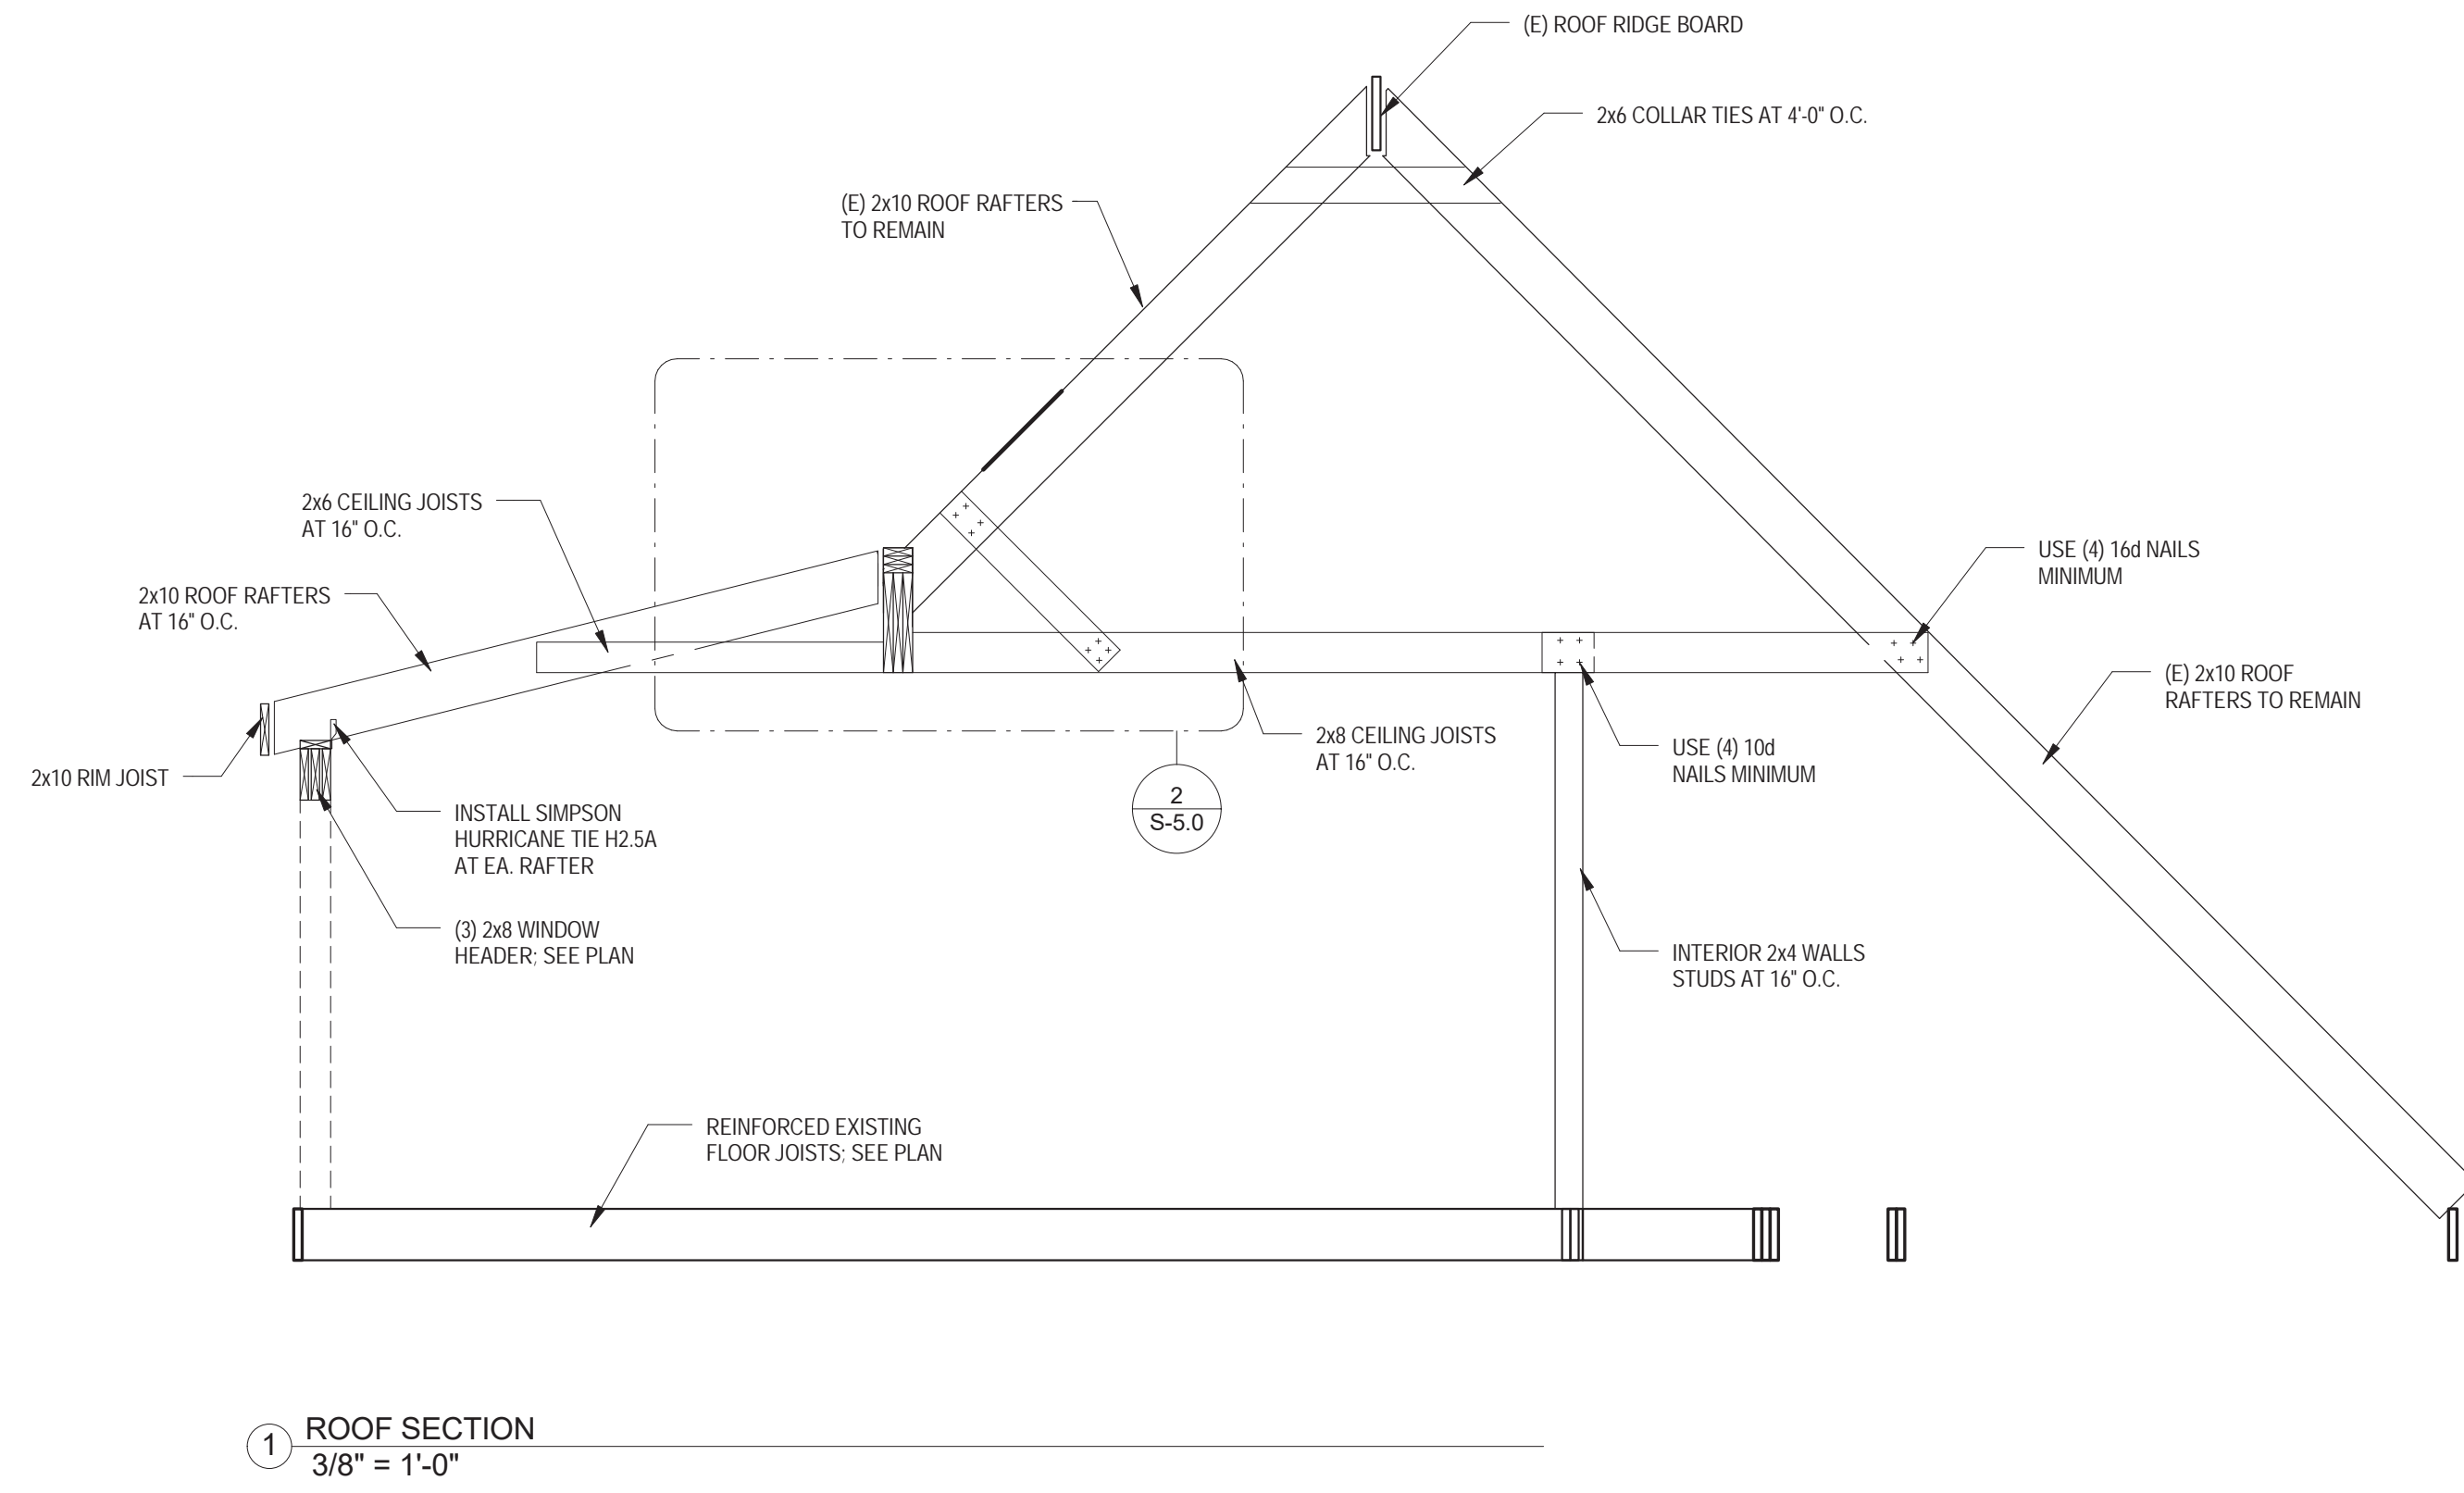

NOTES:
 1. VERIFY ALL DIMENSIONS IN FIELD BEFORE STEEL FABRICATION.
 2. SB1 = INDICATES STEEL DOG LEGGED CHANNEL WITH (2) LVL STRINGER AND JOIST CONNECTED.



Werth Residence
 Renovation
 10 Cardinal Drive, Westwood, MA

© 2015 Gienapp Design Associates, LLC
 ALL RIGHTS RESERVED. ALL IDEAS, DESIGNS, PLANS AND SPECIFICATIONS ARE THE PROPERTY OF GIENAPP DESIGN ASSOCIATES. RIGHTS OF USE ARE CONDITIONAL AND ARE LIMITED TO A ONE-TIME USE TO CONSTRUCT A SINGLE PROJECT ON THE SITE SO INDICATED. USE OF THE WORK AND ANY DERIVATIVE WORK COVERED UNDER THIS COPYRIGHT FOR OTHER PROJECTS IS PROHIBITED. THE USE OR REPRODUCTION OF THESE PLANS FOR ANY OTHER CONSTRUCTION OR PERMIT APPLICATION IS STRICTLY PROHIBITED WITHOUT PRIOR WRITTEN PERMISSION OF GIENAPP DESIGN ASSOCIATES AND THE ARCHITECT WHOSE SIGNATURE AND SEAL MAY BE AFFIXED TO THESE DRAWINGS.

Revisions	Date



Project: 622.1
 Drawn by: MAB
 Check by: TLH
 Date: 01/09/17
 Scale: As indicated

Section and Details


S-5.0

IF THIS SHEET IS NOT 24 X 36 IT IS A REDUCED SCALE PRINT - SCALE ACCORDINGLY

LEGEND

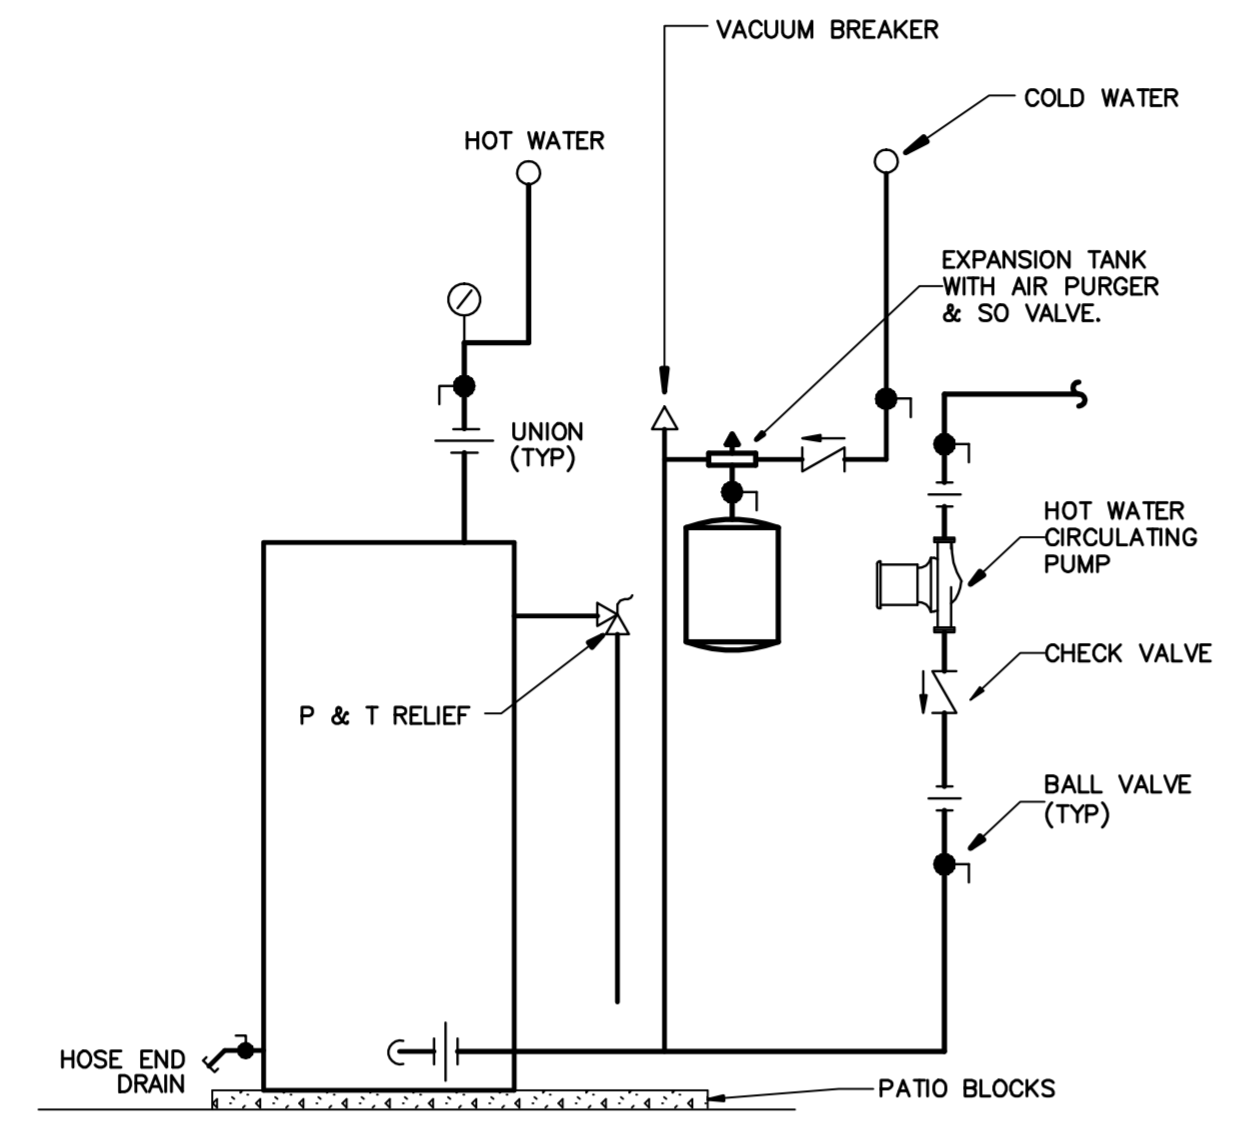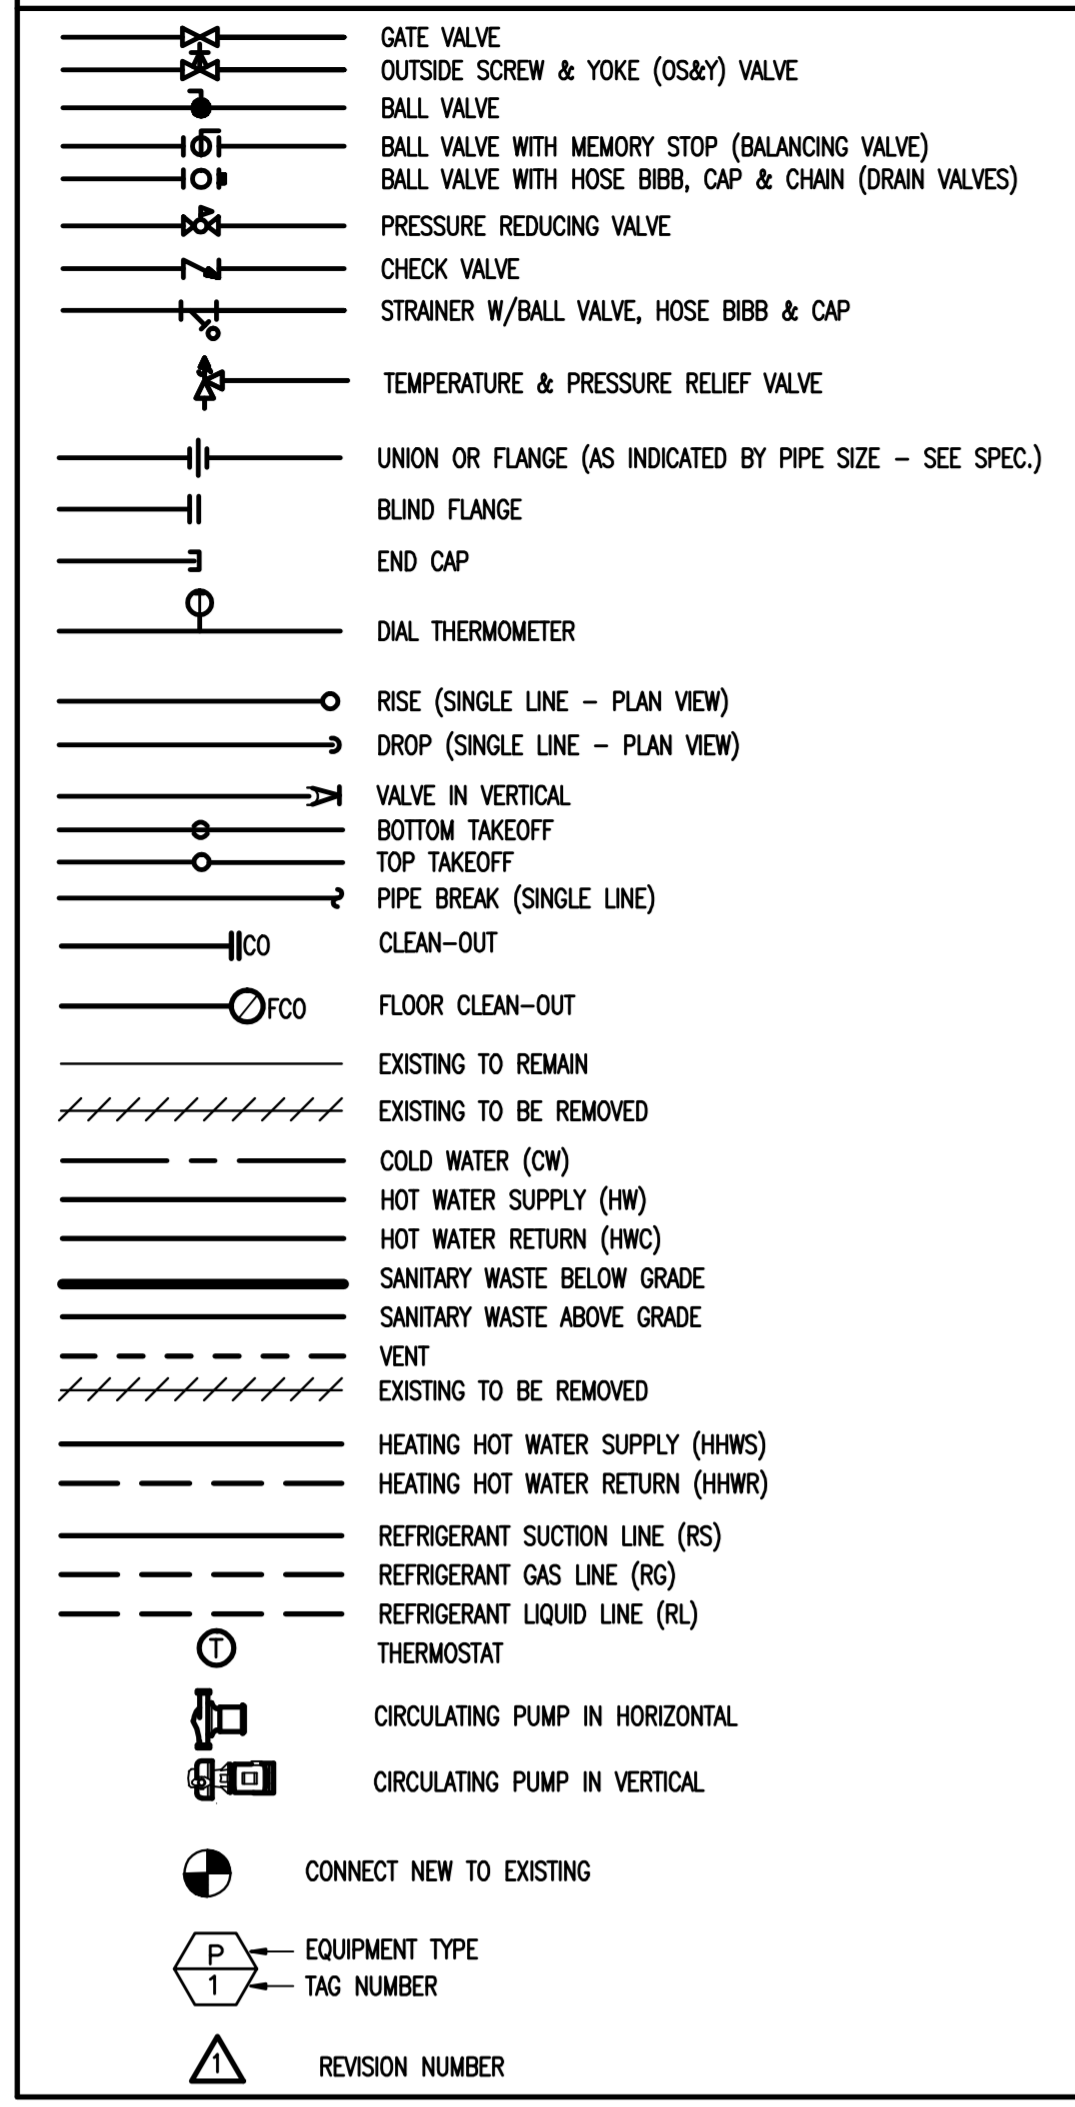

P 01 WATER HEATER DETAIL
N.T.S.

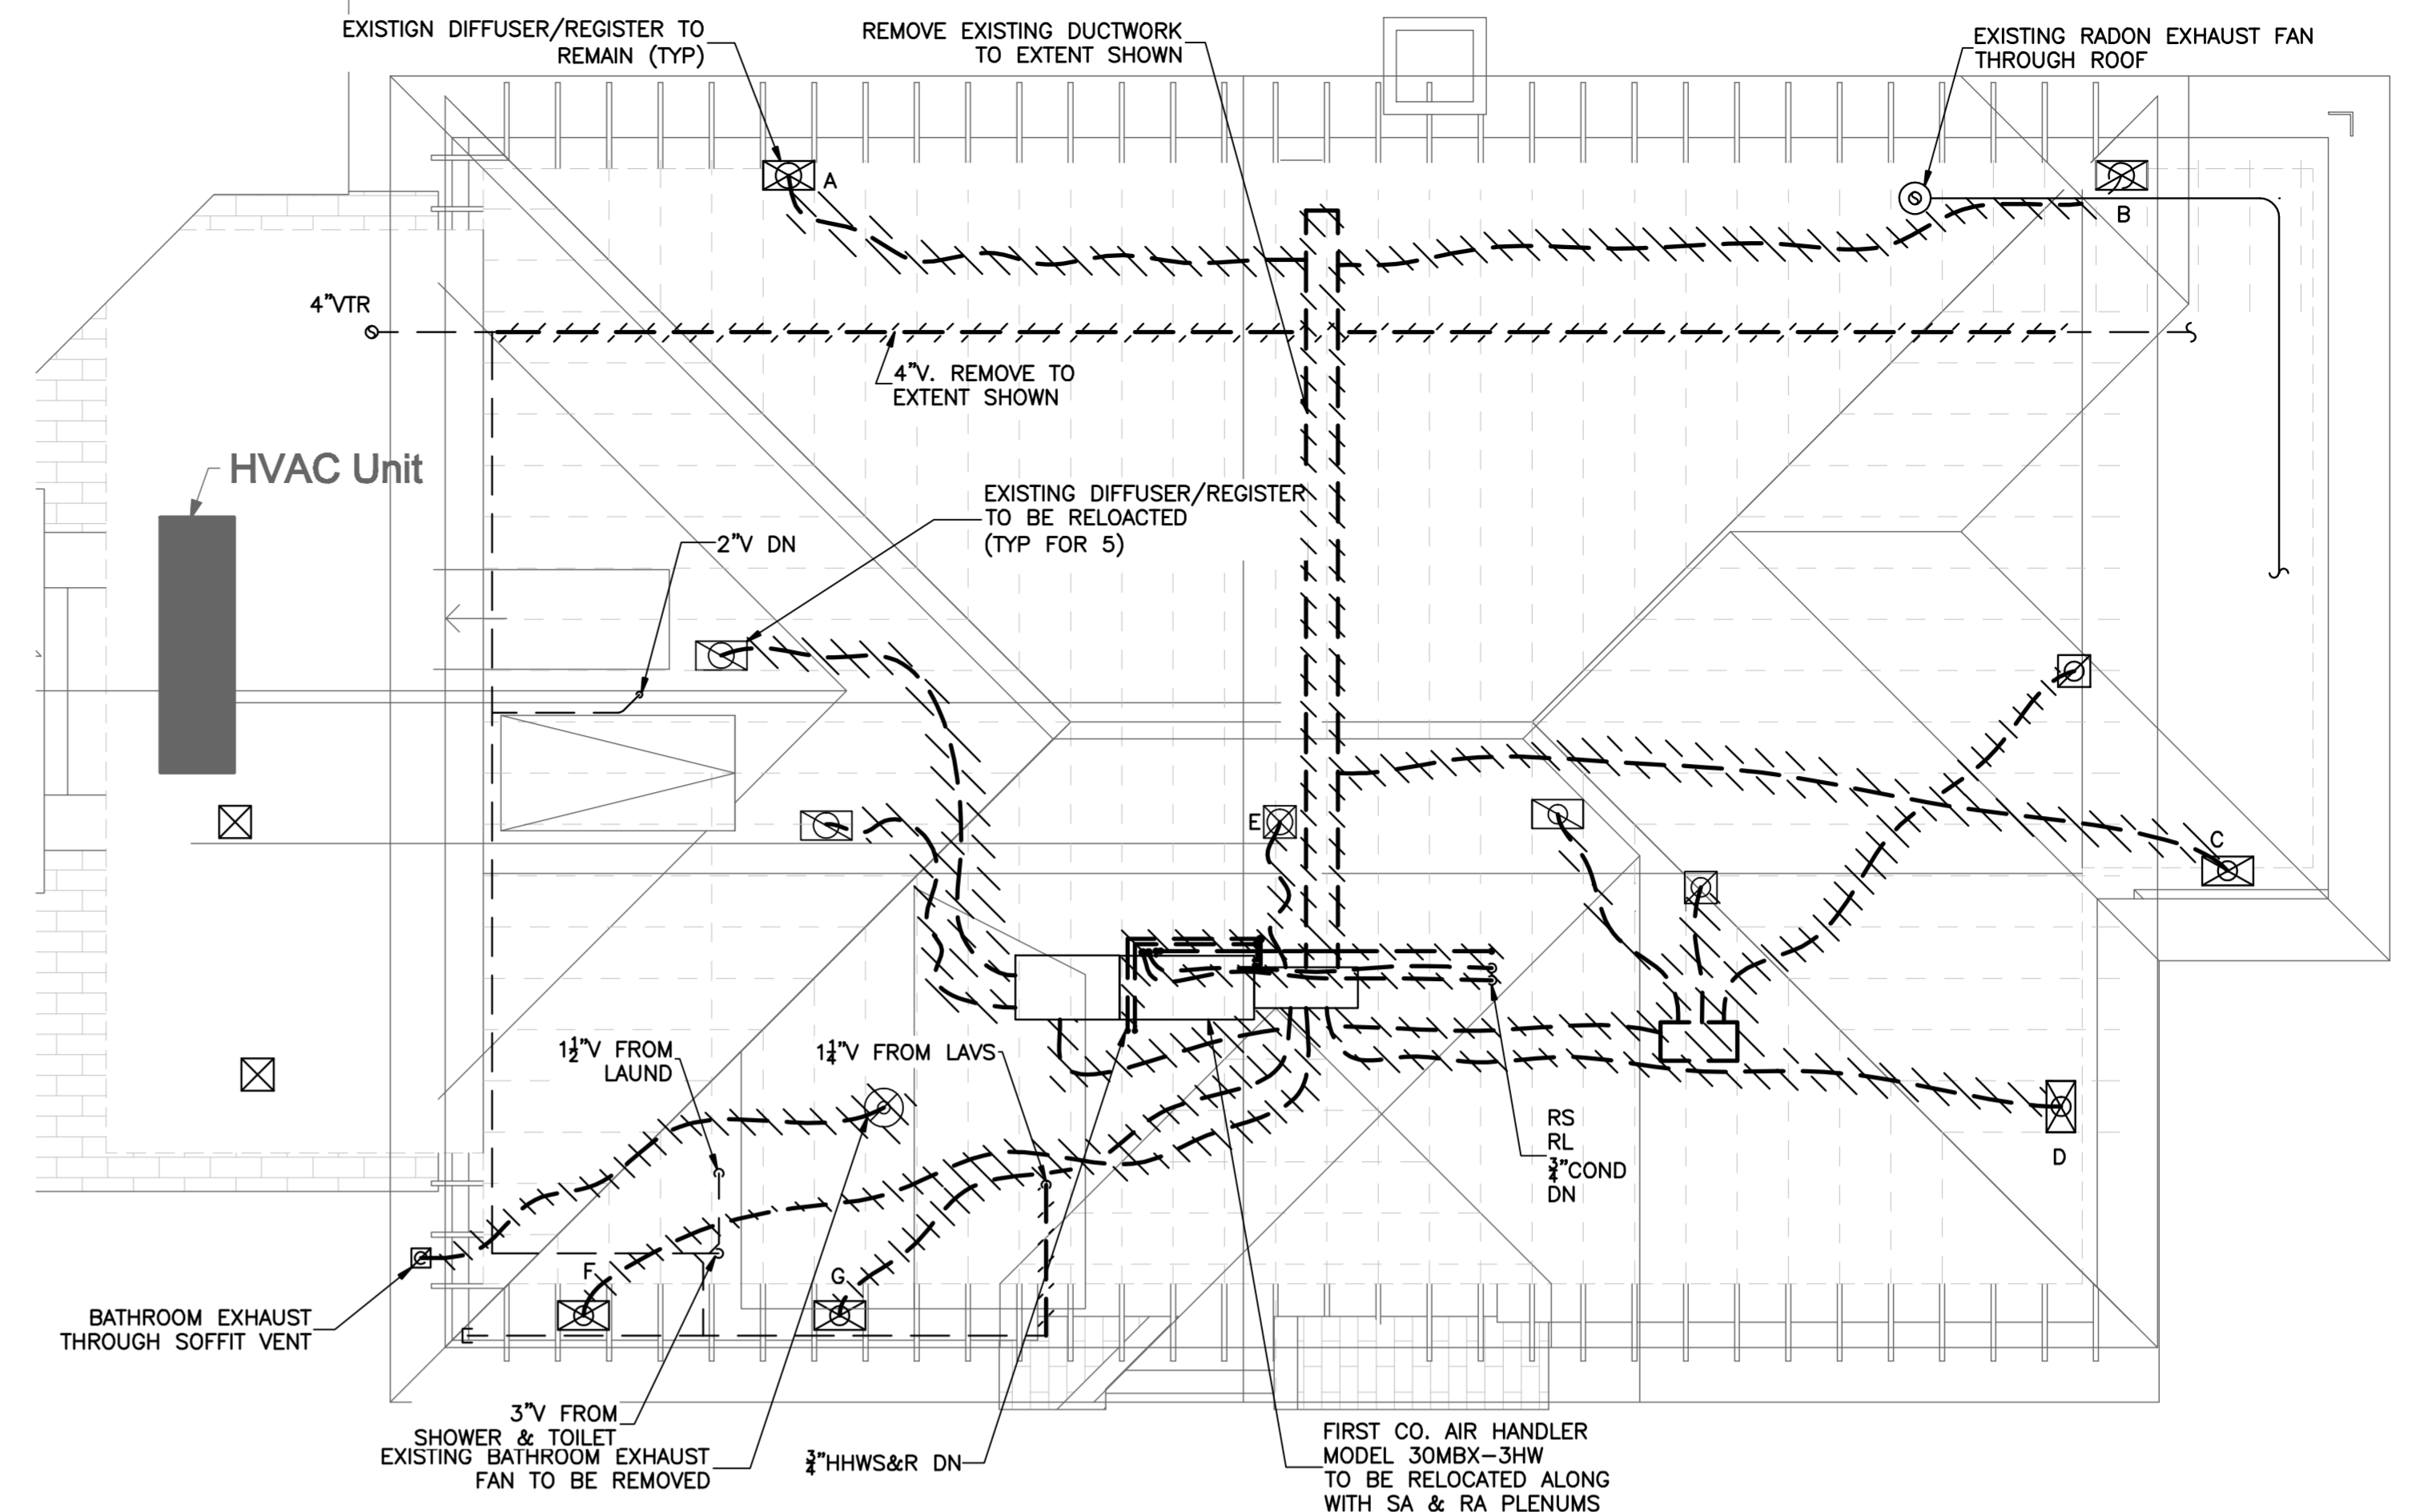

P 01 EXISTING ATTIC (3RD FLOOR)
1/4"=1'-0"

MINI SPLIT HEAT PUMP SYSTEM SCHEDULE

TAG No.	MANUFACTURER	MODEL No.	TOTAL CFM	SPEED	TOTAL MBH CLG	TOTAL MBH HTG	SEER	COMBINED RATINGS			COMMENTS
								V/PH/Hz	MCA	MOCP	
HP-1	MITSUBISHI	MXZ-3C24NHZ	NA	NA	22	25	20	230/208/1/60	29.9	40	
FC-1	MITSUBISHI	MSZ-GE06NA	170	MED	6	7.2	-	230/208/1/60	1	-	PROVIDE WITH ON-BOARD MINI CONDENSATE PUMP
FC-2	MITSUBISHI	MSZ-GE06NA	170	MED	6	7.2	-	230/208/1/60	1	-	PROVIDE WITH ON-BOARD MINI CONDENSATE PUMP
FC-3	MITSUBISHI	MSZ-GE06NA	170	MED	6	7.2	-	230/208/1/60	1	-	PROVIDE WITH ON-BOARD MINI CONDENSATE PUMP

COORDINATE INDOOR UNIT CONTROLS WITH ARCHITECT & OWNER PRIOR TO ACQUISITION.

EXHAUST FAN SCHEDULE

TAG No.	SERVES	MANUFACTURER & MODEL No.	TYPE	FAN DATA			ELECTRICAL DATA			SOUND DATA (SONES)	REMARKS
				CFM	RPM	SP(IN)	VOLTS	PHASE	WATTS		
EF-1	BATHROOM	FANTECH SERENITY DUET	DIRECT DRIVE IN-LINE	100	2491	0.4	120	1	74.2	-	
EF-2	BATHROOM	PANASONIC FV-08VSE3	DIRECT DRIVE CEILING W/ LIGHT	80	878	0.1	120	1	7.5	.3	OPERATE ON LIGHT SWITCH

DOMESTIC HOT WATER HEATER SCHEDULE


TAG No.	MANUFACTURER	MODEL No.	TYPE	INPUT	RECOVERY (GPH)	STORAGE (GAL)	ENERGY FACTOR	VOLTS	PHASE	A	REMARKS
WH-1	AO SMITH	PNT-30	ELECTRIC TANK	6 KW	27 @ 90"	30	.95	240	1	16.7	

EXPANSION TANK SCHEDULE

TAG No.	LOCATION	MANUFACTURER (AS STANDARD)	MODEL No. (AS STANDARD)	TYPE	TANK VOLUME (GAL)	MAX. ACCEPT. (GAL)	REMARKS
DET-1	BOILER ROOM	AMTROL	ST-12	BLADDER TYPE EXPANSION TANK	4.4	4.4	RATED FOR DOMESTIC SERVICE PRE-CHARGE TO MATCH INCOMING WATER PRESSURE

PUMP SCHEDULE

TAG No.	MANUFACTURER	MODEL No.	TYPE	SERVICE	LOCATION	PUMP DATA			ELECTRICAL DATA			REMARKS
						GPM	RPM	HEAD(FT)	VOLTS	PHASE	HP	
ZP-1	TACO	008	IN-LINE CIRCULATOR	HEATING ZONE 2ND FLR AHU	BOILER ROOM	4	3250	14	115	1	1/25	CONNECT TO EXISTING CONTROLS
CP-1	TACO	006-SF5	SS IN-LINE CIRCULATOR	HOT WATER RECIRC	BOILER ROOM	1	3250	8	115	1	1/40	STAINLESS STEEL CASING OPERATE ON AQUASTAT

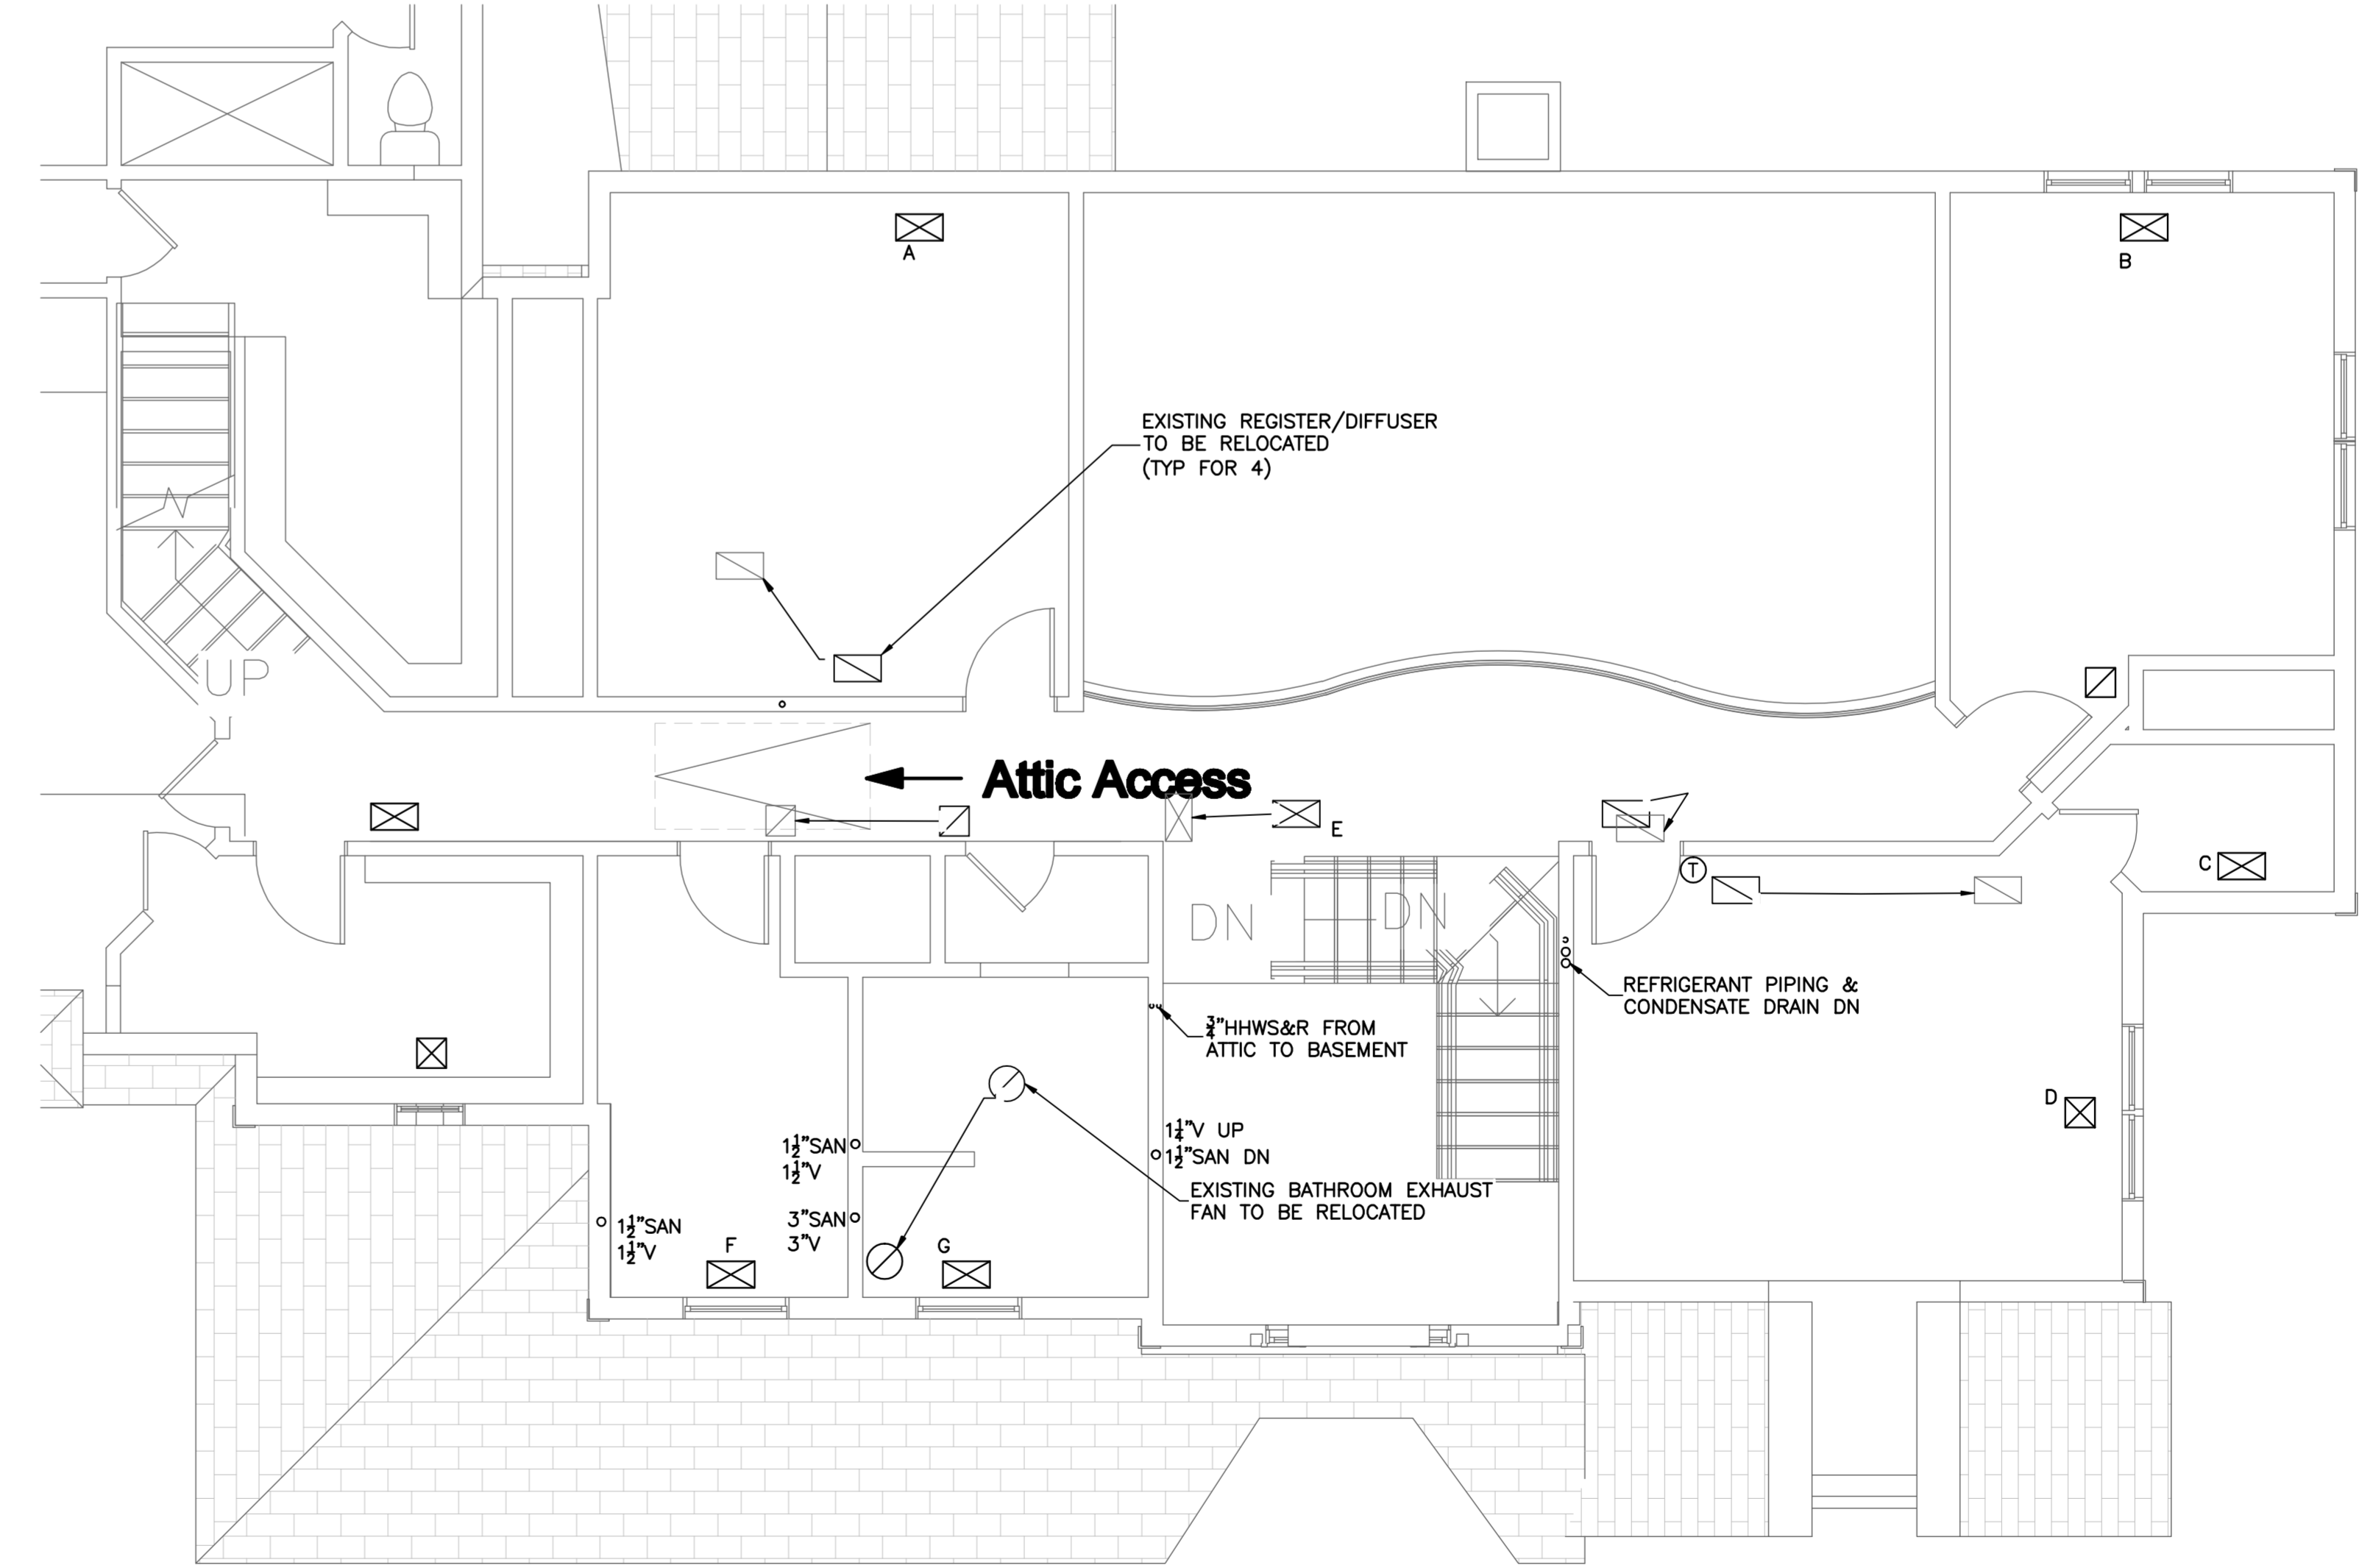

P 01 EXISTING 2ND FLOOR
1/4"=1'-0"

Werth Residence
Renovation
10 Cardinal Drive, Westwood, MA

Plot Date: 10/28/2016 4:08:18 PM

© 2016 Gierapp Design Associates, LLC
ALL RIGHTS RESERVED. ALL DESIGN, DRAWING, PLANS AND SPECIFICATIONS ARE THE PROPERTY OF GIERAPP DESIGN ASSOCIATES. RIGHTS OF USE ARE CONDITIONAL AND ARE LIMITED TO ONE TIME USE TO COMPLETE A SINGLE PROJECT ON THE SITE SO INDICATED. REUSE OF THE WORK AND ANY CONTENTS THEREOF COVERED UNDER THIS COPYRIGHT FOR OTHER PROJECTS IS PROHIBITED. THE USE OR REPRODUCTION OF THESE PLANS FOR ANY OTHER CONSTRUCTION OR PRIMARY APPLICATION IS EXPRESSLY PROHIBITED WITHOUT PRIOR WRITTEN PERMISSION OF GIERAPP DESIGN ASSOCIATES AND THE ARCHITECT. UNLESS OTHERWISE INDICATED, ALL SHALL BE APPLIED TO THESE DRAWINGS.


No.	Date	Description

Project: 682.1
 Drawn by: JRW
 Check by: JTW
 Date: 1/13/17
 Scale: As Indicated

2nd Flr & Attic Mechanical Demo Plans

M1.1

IF THIS SHEET IS NOT 24 X 36 IT IS A REDUCED SCALE PRINT - SCALE ACCORDINGLY

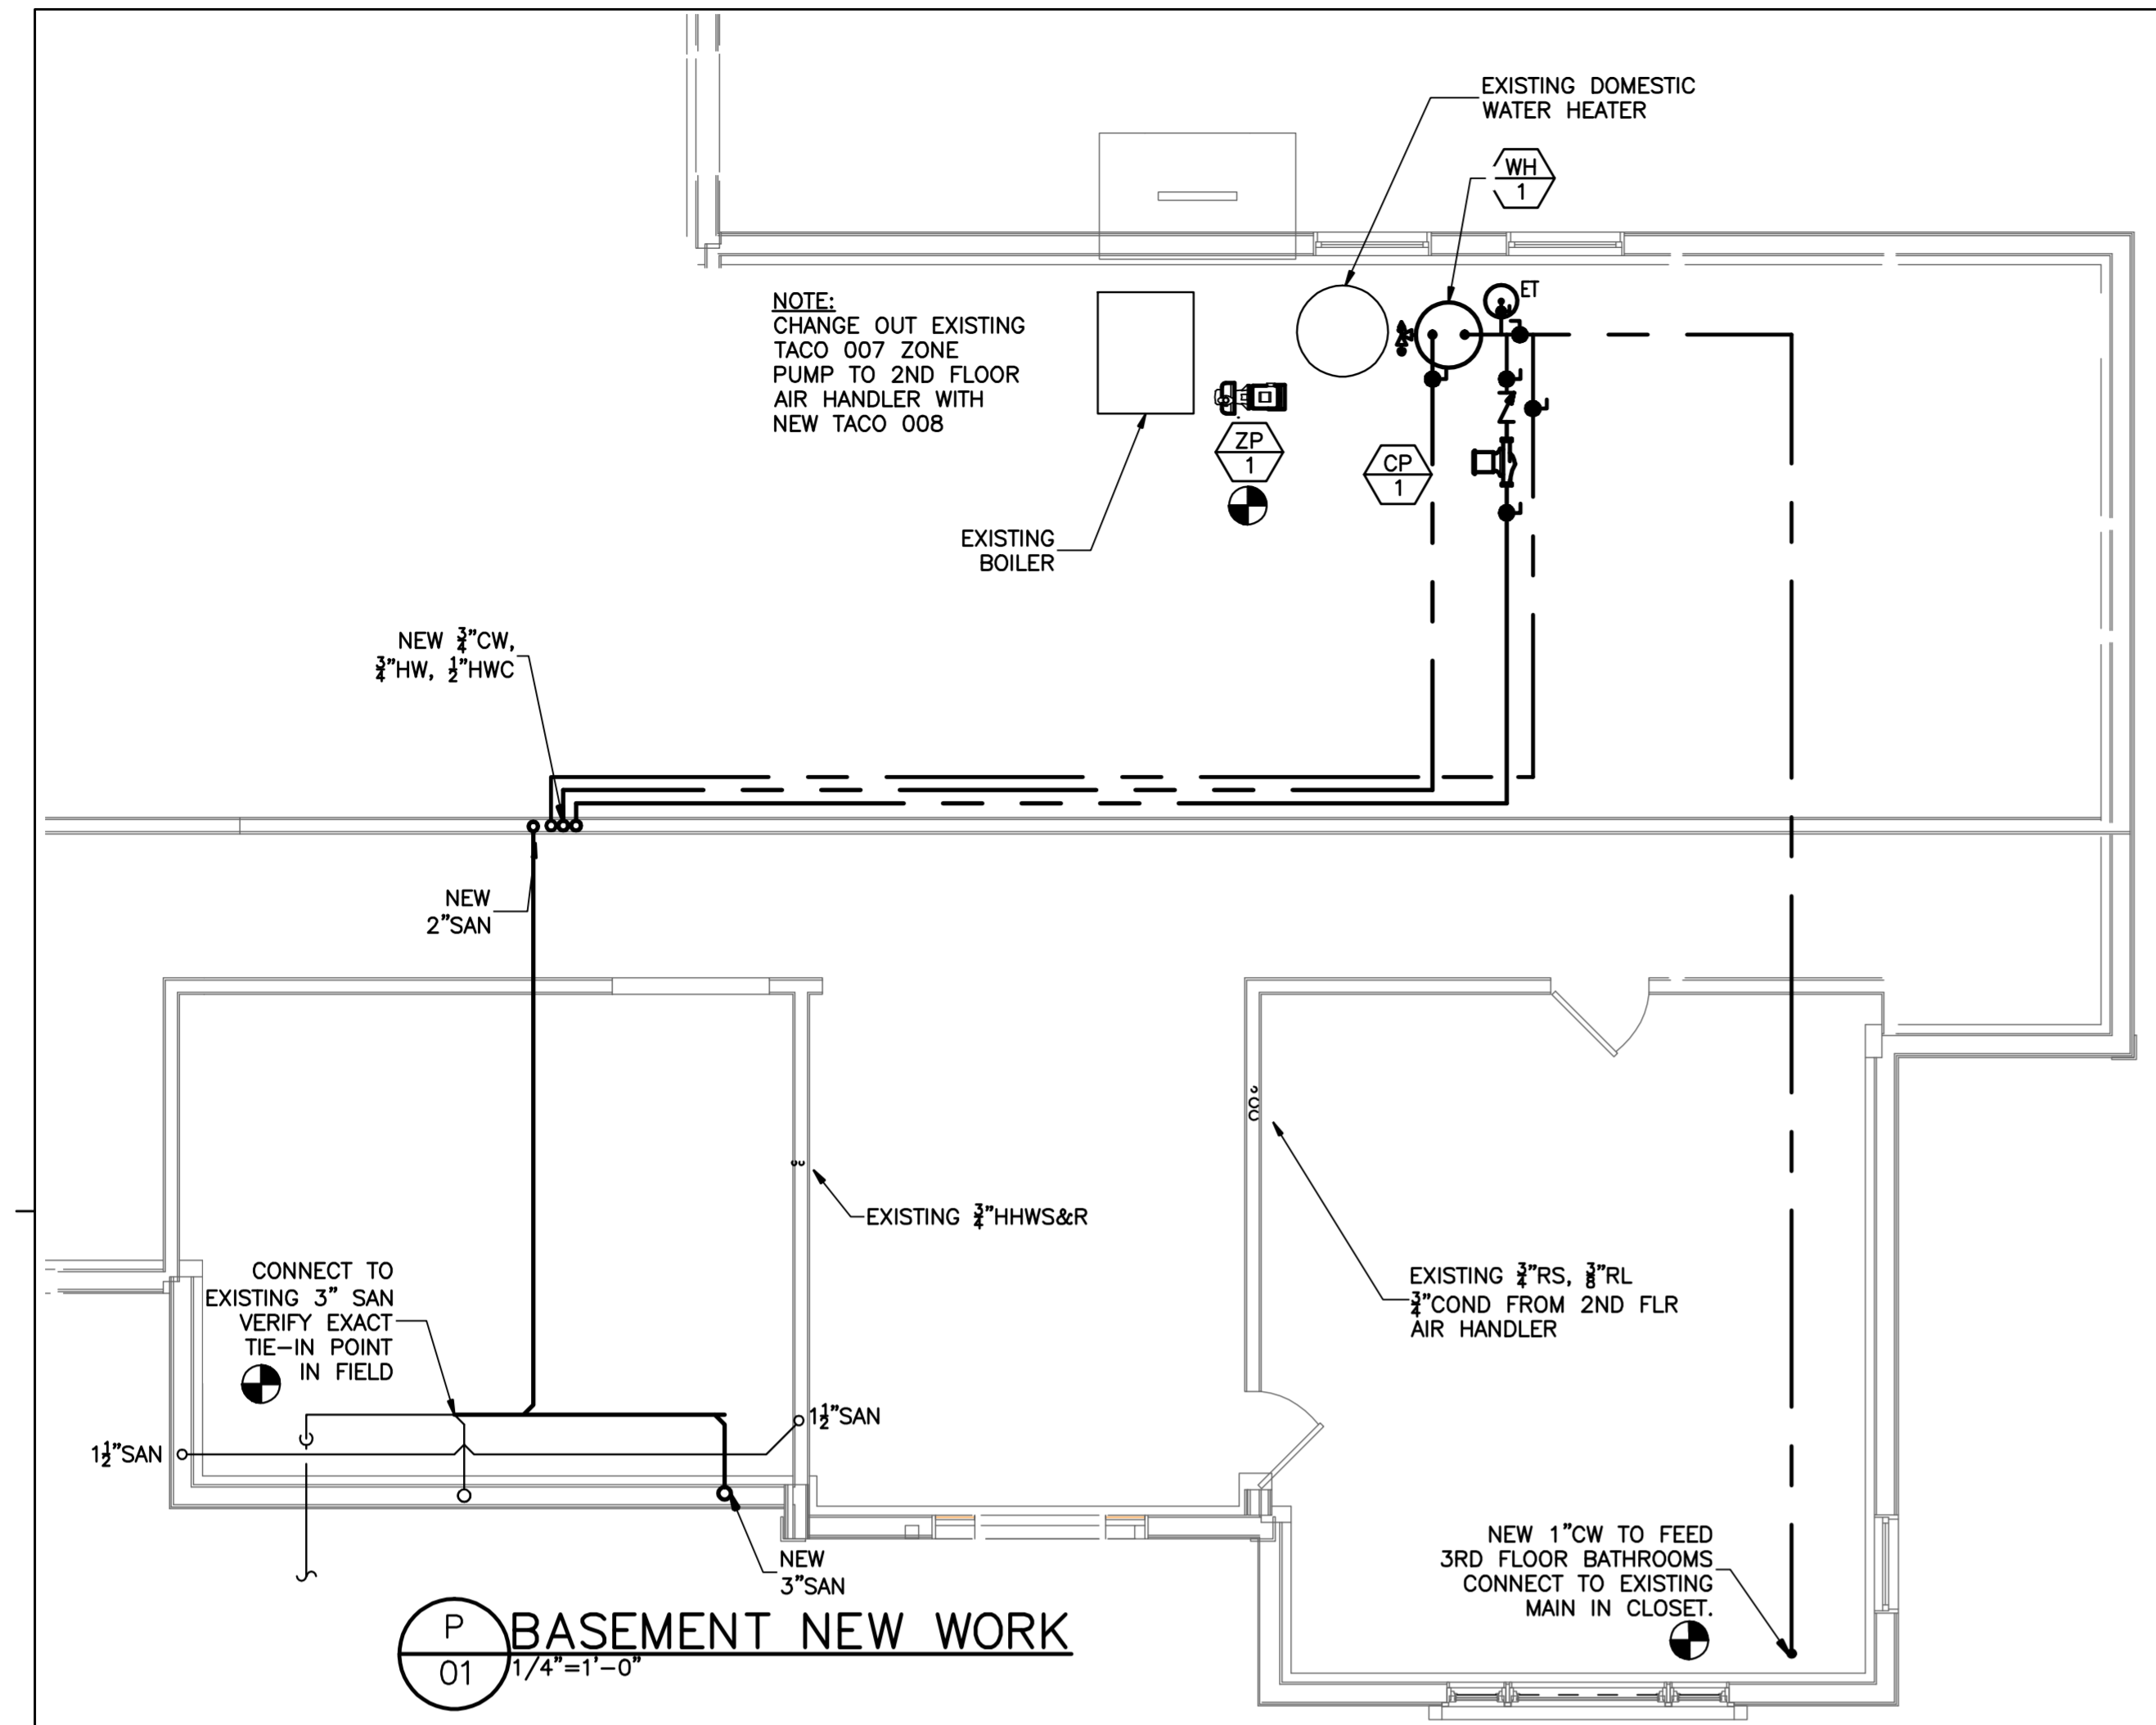

PLUMBING SPECIFICATIONS

PIPE & FITTINGS

- ABOVE GRADE HOT AND COLD WATER PIPING WITHIN 36" OF A WATER HEATER SHALL BE TYPE L COPPER WITH WROUGHT COPPER FITTINGS AND 95/5 LEAD FREE SOLDER.
- ABOVE GRADE BRANCH PIPING MAY BE PEX TUBING MEETING ASTM F876 & F877, WITH PEX REINFORCING RING COLD EXPANSION FITTINGS MEETING ASTM F1960-99. RUNS TO FIXTURES SHALL BE INSTALLED AS ONE LENGTH WITHOUT CONCEALED FITTINGS OR COUPLINGS. WHERE PEX IS USED ON THE DOMESTIC HOT WATER SYSTEM WITH HOME-RUNS TO THE BASEMENT, THE RECIRC SYSTEM SHALL ALSO BE PROVIDED WITH A HOME-RUN FROM EACH BRANCH. PROVIDE A CHECK AND BALANCING VALVE FOR EACH RECIRC LEG.
- SANITARY WASTE & VENT PIPING SHALL BE SCHEDULE 40 PVC WITH SOLVENT WELD DRAINAGE PATTERN FITTINGS
- CONDENSATE DRAIN PIPING SHALL BE SCHEDULE 40 PVC WITH SOLVENT WELD DRAINAGE FITTINGS.

VALVES

- DRAIN VALVES SHALL CONSIST OF HOSE END VALVE DESIGNED FOR 200 PSI WITH THREADED CAP AND CHAIN. PROVIDE AT ALL LOW POINTS IN WATER PIPING SYSTEM AND AT THE BASE OF ALL RISERS SO THAT ENTIRE SYSTEM MAY BE DRAINED. APOLLO 78 SERIES WITH 3/4" HOSE CONNECTION, CAP AND CHAIN.
- CHECK VALVES SHALL BE HORIZONTAL REGRINDING SWING 200#, MILWAUKEE 1509.
- BALL VALVES SHALL BE WITH STAINLESS STEEL STEM AND BALL, STANDARD PORT, BRONZE, SOLDER END, DESIGNED FOR 150 PSI, MILWAUKEE BA150S.

INSULATION

- INSULATION SHALL BE CONTINUOUS THROUGH SLEEVES, PENETRATIONS AND HANGERS. PENETRATIONS THROUGH FIRE RATED PARTITIONS SHALL BE FIREPROOFED WITH SPEC SEAL TYPE SSS OR EQUIVALENT.
- HOT AND COLD WATER PIPING SHALL BE INSULATED WITH 1" THICK FIBERGLASS INSULATION. INSULATION SHALL BE PROVIDED WITH A FACTORY APPLIED ALL SERVICE JACKET, K FACTOR OF 0.23 AT 75°F AND AN ASTM FIRE HAZARD RATING OF 25 FLAME, 50 SMOKE DEVELOPED.

INSTALLATION

- PIPES SHALL BE PLUMB AND PARALLEL TO BUILDING WALLS, BEAMS AND COLUMNS. ALL HORIZONTAL LINES SHALL BE EVENLY PITCHED AND PROPERLY SECURED WITH IRON OR STEEL HANGERS. A PITCH OF 1/4" PER LINEAL FOOT SHALL BE MAINTAINED ON ALL SOIL AND WASTE LINES, WHEREVER POSSIBLE. WHERE LONG RUNS OF PIPING REQUIRE LESS PITCH, DUE TO SPACE RESTRICTIONS, A LESSER PITCH SHALL BE ALLOWED ON MAIN LINES 4" AND OVER IN SIZE, BUT, IN NO EVENT, SHOULD ANY PIPELINE HAVE A SLOPE LESS THAN 1/8" PER LINEAL FOOT.
- INSTALL ALL EQUIPMENT AND FIXTURES IN ACCORDANCE WITH THE MANUFACTURER'S INSTRUCTIONS.

TESTING

- ALL PIPING SYSTEMS SHALL BE SUBJECT TO TESTING AS NOTED AND SHALL HOLD TIGHT AT THE PRESSURE HEAD STATED FOR THE TIME INTERVAL REQUIRED WITHOUT ADDING AIR OR WATER. WHILE ANY SYSTEM IS BEING TESTED, REQUIRED HEAD OR PRESSURE SHALL BE MAINTAINED UNTIL ALL JOINTS ARE INSPECTED.
- ALL EQUIPMENT, MATERIAL AND LABOR REQUIRED FOR TESTING ANY OF THE VARIOUS SYSTEMS OR ANY PART THEREOF SHALL BE PROVIDED BY THE PLUMBING SUBCONTRACTOR.

DISINFECTING OF WATER SYSTEMS

- THE ENTIRE NEW WATER PIPING SYSTEM SHALL BE THOROUGHLY DISINFECTED WITH A SOLUTION CONTAINING NOT LESS THAN 50 PARTS PER MILLION OF AVAILABLE CHLORINE. THE CHLORINATING MATERIAL SHALL BE EITHER LIQUID CHLORINE OR SODIUM HYPOCHLORITE SOLUTION, SHALL BE INTRODUCED INTO THE NEW SYSTEM AND DRAWN TO ALL POINTS IN THE NEW SYSTEM.
- THE DISINFECTING SOLUTION SHALL BE ALLOWED TO REMAIN IN THE SYSTEM FOR A PERIOD OF 8 HOURS, DURING WHICH PERIOD ALL VALVES AND FAUCETS SHALL BE OPENED AND CLOSED SEVERAL TIMES. AFTER DISINFECTING, THE SOLUTION SHALL BE FLUSHED FROM THE SYSTEM WITH CLEAR WATER UNTIL THE RESIDUAL CHLORINE CONTENT IS NOT GREATER THAN 0.2 PARTS PER MILLION.
- THIS WORK SHALL BE SUPERVISED OR DONE BY AN APPROVED CHEMICAL TESTING LABORATORY AND RESULTS SENT TO THE ENGINEER OR HIS REPRESENTATIVE FOR VERIFICATION.

HANGERS, INSERTS AND SUPPORTS

- ALL PIPING SHALL BE RIGIDLY SUPPORTED FROM THE BUILDING STRUCTURES BY MEANS OF APPROVED HANGERS AND SUPPORTS. PIPING SHALL BE SUPPORTED TO MAINTAIN REQUIRED GRADING AND PITCHING OF LINE, TO PREVENT VIBRATION AND TO SECURE PIPING IN PLACE, AND SHALL BE ARRANGED SO AS TO PROVIDE FOR EXPANSION AND CONTRACTION. IN NO CASE SHALL RISERS OR MAINS CONTACT BUILDING STRUCTURES.

HVAC SPECIFICATIONS

PIPE & FITTINGS

- REFRIGERANT PIPING SHALL BE TYPE "ACR" COPPER PIPING, WASHED AND CAPPED AT THE FACTORY. PROVIDE WITH COPPER BRAZED JOINTS & FITTINGS.
- CONDENSATE DRAIN PIPING SHALL BE SCHEDULE 40 PVC WITH SOLVENT WELD DRAINAGE FITTINGS.
- HEATING HOT WATER PIPING SHALL BE TYPE L COPPER WITH WROUGHT COPPER FITTINGS AND 95/5 LEAD FREE SOLDER. ABOVE GRADE PIPING MAY BE PEX TUBING WITH OXYGEN BARRIER MEETING ASTM F876, F877 WITH PEX REINFORCING RING COLD EXPANSION FITTINGS MEETING ASTM F1960-99. RUNS TO EQUIPMENT SHALL BE INSTALLED AS ONE LENGTH WITHOUT CONCEALED FITTINGS OR COUPLINGS.

DUCTWORK


- SHEET METAL DUCTWORK SHALL BE GALVANIZED STEEL, SMOOTH INSIDE AND TRUE TO SIZE. DUCT CONSTRUCTION, GAUGES, SPECIFICATIONS AND SUPPORTS SHALL BE IN ACCORDANCE WITH RECOMMENDATIONS OF THE 1995 EDITION OF SMACNA DUCT CONSTRUCTION STANDARDS. NO STANDARDS FOR DUCTWORK OTHER THAN SMACNA SHALL BE ACCEPTED. ALL DUCTWORK SHALL BE 1" WATER GAUGE PRESSURE CLASS.
- ALL JOINTS AND ALL SEAMS OF ALL DUCTWORK SHALL BE SEALED WITH UL LABELED SEALER AS MANUFACTURED BY 3M COMPANY OR UNITED STEEL METAL EQUAL TO 3M EC-900.
- SHEET METAL ELBOWS SHALL HAVE A RADIUS OF 1 1/2 TIMES THE DUCT WIDTH MEASURED BY DUCT CENTERLINES. WHERE CONDITIONS WILL NOT PERMIT OR WHERE INDICATED ON DRAWINGS USE MITER TURNS WITH DOUBLE WALL TURNING VANES. PROVIDE AIR SPLITTER DAMPERS WHERE INDICATED ON THE DRAWINGS AND WHERE REQUIRED FOR ADJUSTMENT OF AIR DISTRIBUTION TO RESPECTIVE DUCT BRANCHES. SPLITTER DAMPERS SHALL BE CONSTRUCTED IN ACCORDANCE WITH APPLICABLE SMACNA STANDARDS.
- PROVIDE FACTORY FABRICATED VOLUME DAMPERS IN ALL SUPPLY, RETURN BRANCH DUCTS, AT EACH SUPPLY AIR REGISTER AND WHERE INDICATED ON DRAWINGS. VOLUME DAMPERS SHALL BE CONSTRUCTED IN ACCORDANCE WITH APPLICABLE SMACNA STANDARDS.
- AFTER AND DURING ASSEMBLY OF DUCTS, CLEAN ALL DIRT, GREASE, DUST, RUBBISH, ETC. FROM BOTH THE INTERIOR AND EXTERIOR OF DUCTWORK.
- WHERE DUCTS ARE INSULATED, PROVISION SHALL BE MADE FOR A NEAT INSTALLATION FINISH AROUND DAMPER OPERATOR QUADRANT. TEST OPENINGS, ACCESS DOORS AND SIMILAR OPERATION DEVICES. ALL DUCT WORK AND EQUIPMENT SHALL BE SUPPORTED FROM THE TOP CORD OF JOISTS OR TRUSSES.
- PROVIDE FLEXIBLE CONNECTIONS AT CONNECTIONS TO AIR HANDLERS AND EXHAUST FANS.

INSULATION

- INSULATION MATERIALS, COATINGS AND OTHER ACCESSORIES SHALL INDIVIDUALLY HAVE A FIRE-HAZARD RATING NOT TO EXCEED 25 FOR FLAME SPREAD AND 50 FOR FUEL CONTRIBUTED AND SMOKE DEVELOPED. RATINGS SHALL BE DETERMINED ACCORDING TO U.L. "TEST METHOD FOR FIRE HAZARD CLASSIFICATION OF BUILDING MATERIALS," NO. 823 OR NFPA NO. 225 OR ASTM E84.
- ALL CONDENSATE DRAIN PIPING AND REFRIGERANT SUCTION PIPING SHALL BE INSULATED WITH 3/4" WALL CLOSED CELL FOAM PIPE INSULATION. PIPING OUTSIDE OF THE BUILDING SHALL HAVE ITS INSULATION COATED WITH BRUSH APPLIED PROTECTIVE COATING.
- ALL SUPPLY & RETURN AIR DUCTWORK, OUTDOOR AIR INTAKE DUCTWORK SHALL BE INSULATED WITH 1 1/2" THICK FOIL FACED FIBERGLASS DUCT WRAP, 1-1/2 LB. DENSITY. INSULATION SHALL BE KNAUF DUCT WRAP OR APPROVED EQUAL, TAPE ALL JOINTS WITH FOIL DUCT TAPE.

CONTROLS

- HEAT PUMP CONTROLS SHALL BE BY THE MANUFACTURER. OBTAIN APPROVAL FOR WALL MOUNT CONTROLLER FROM THE ARCHITECT & OWNER PRIOR TO ORDERING.

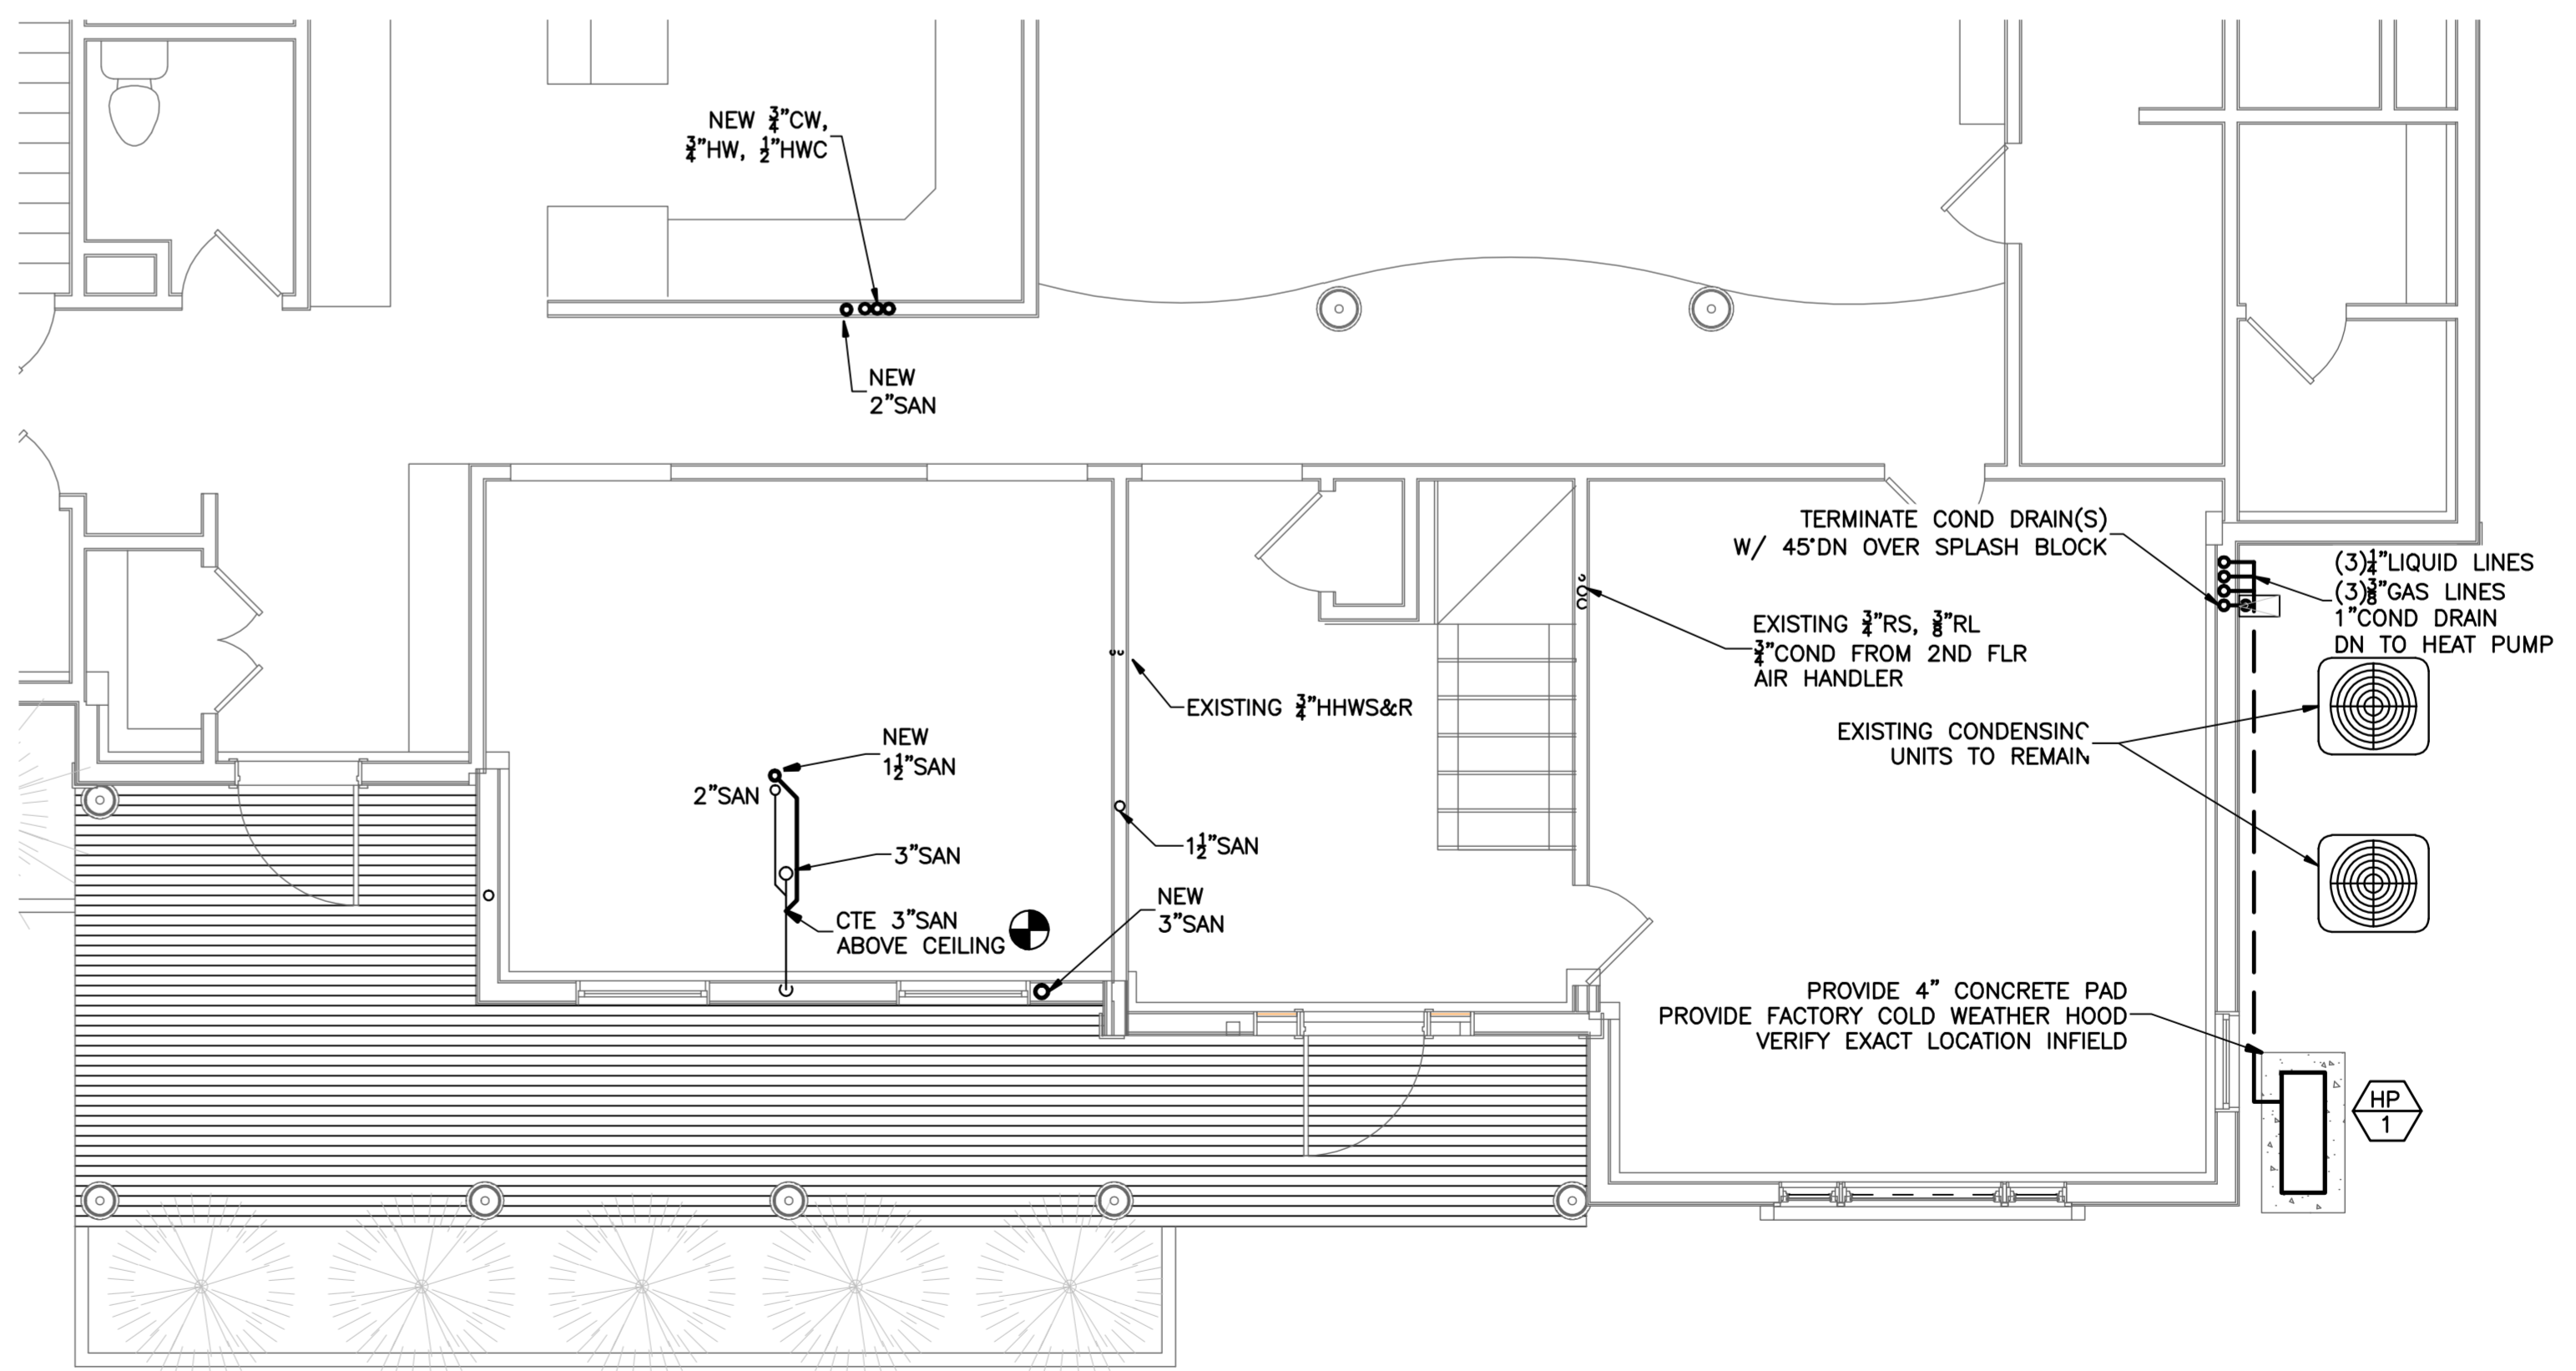

Werth Residence
 Renovation
 10 Cardinal Drive, Westwood, MA

© 2016 Glenapp Design Associates, LLC
 ALL RIGHTS RESERVED. ALL DESIGN, DRAWING, PLANS AND SPECIFICATIONS ARE THE PROPERTY OF GLENAPP DESIGN ASSOCIATES. RIGHTS OF USE ARE CONDITIONAL AND ARE LIMITED TO ONE TIME USE TO COMPLETE A SINGLE PROJECT ON THE SITE SO INDICATED. USE OF THE WORK AND ANY CONTINGENT WORK COVERED UNDER THE COPYRIGHT FOR OTHER PROJECTS IS PROHIBITED. THE USE OR REPRODUCTION OF THESE PLANS FOR ANY OTHER CONSTRUCTION OR PRIMARY APPLICATION IS EXPRESSLY PROHIBITED WITHOUT PRIOR WRITTEN PERMISSION OF GLENAPP DESIGN ASSOCIATES AND THE ARCHITECT. SCHEDULE CHANGES AND DELAYS MAY BE APPROVED TO THESE DRAWINGS.


No.	Date	Description

Project: 682.1
 Drawn by: JRW
 Check by:
 Date: 1/13/17
 Scale: As Indicated

Basement & 1st Flr. New Work Mechanical Plans & Specs


M1.2

IF THIS SHEET IS NOT 24 X 36 IT IS A REDUCED SCALE PRINT - SCALE ACCORDINGLY

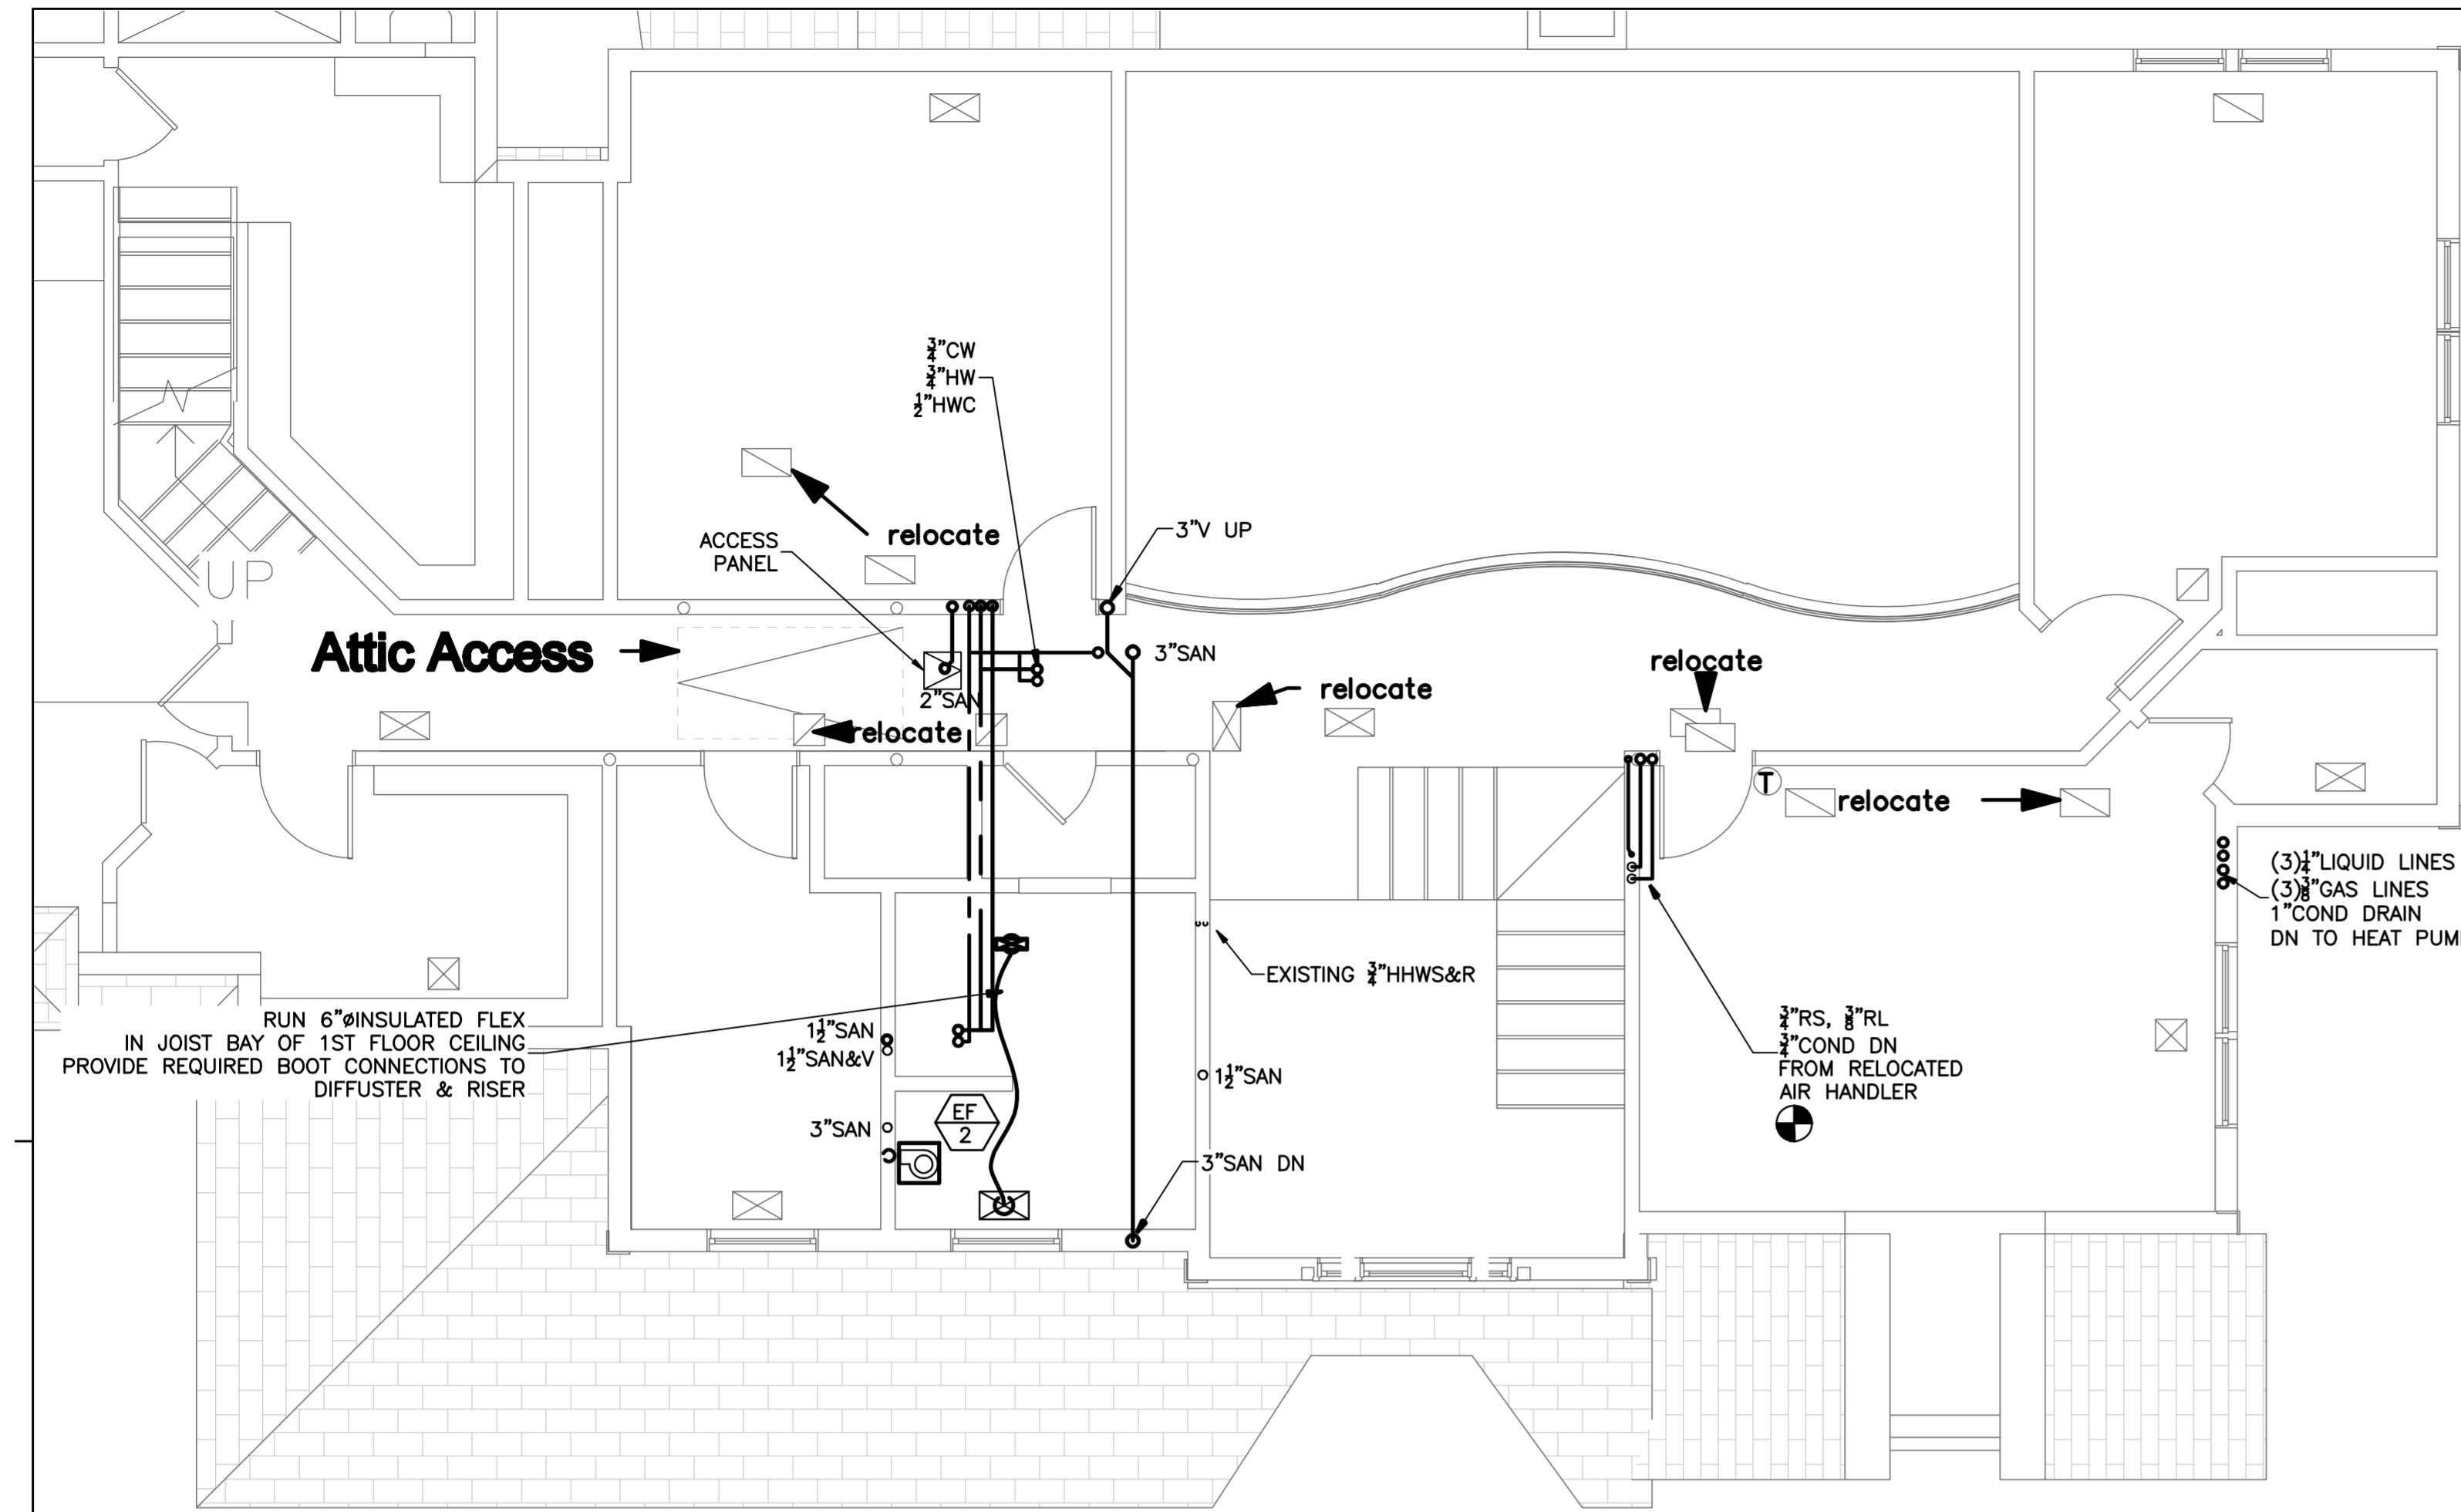


P 01 2ND FLOOR NEW WORK
1/4"=1'-0"

- NOTES:**
1. CHANGE OUT EXISTING TACO 007 ZONE PUMP IN BASEMENT WITH NEW TACO 008
 2. LOCATE ALL PLUMBING & HVAC ROOF PENETRATIONS BEHIND THE RIDGE.
 3. CONTRACTOR'S TO VERIFY AND DETERMINE FINAL ROUTING OF PIPING & DUCTWORK

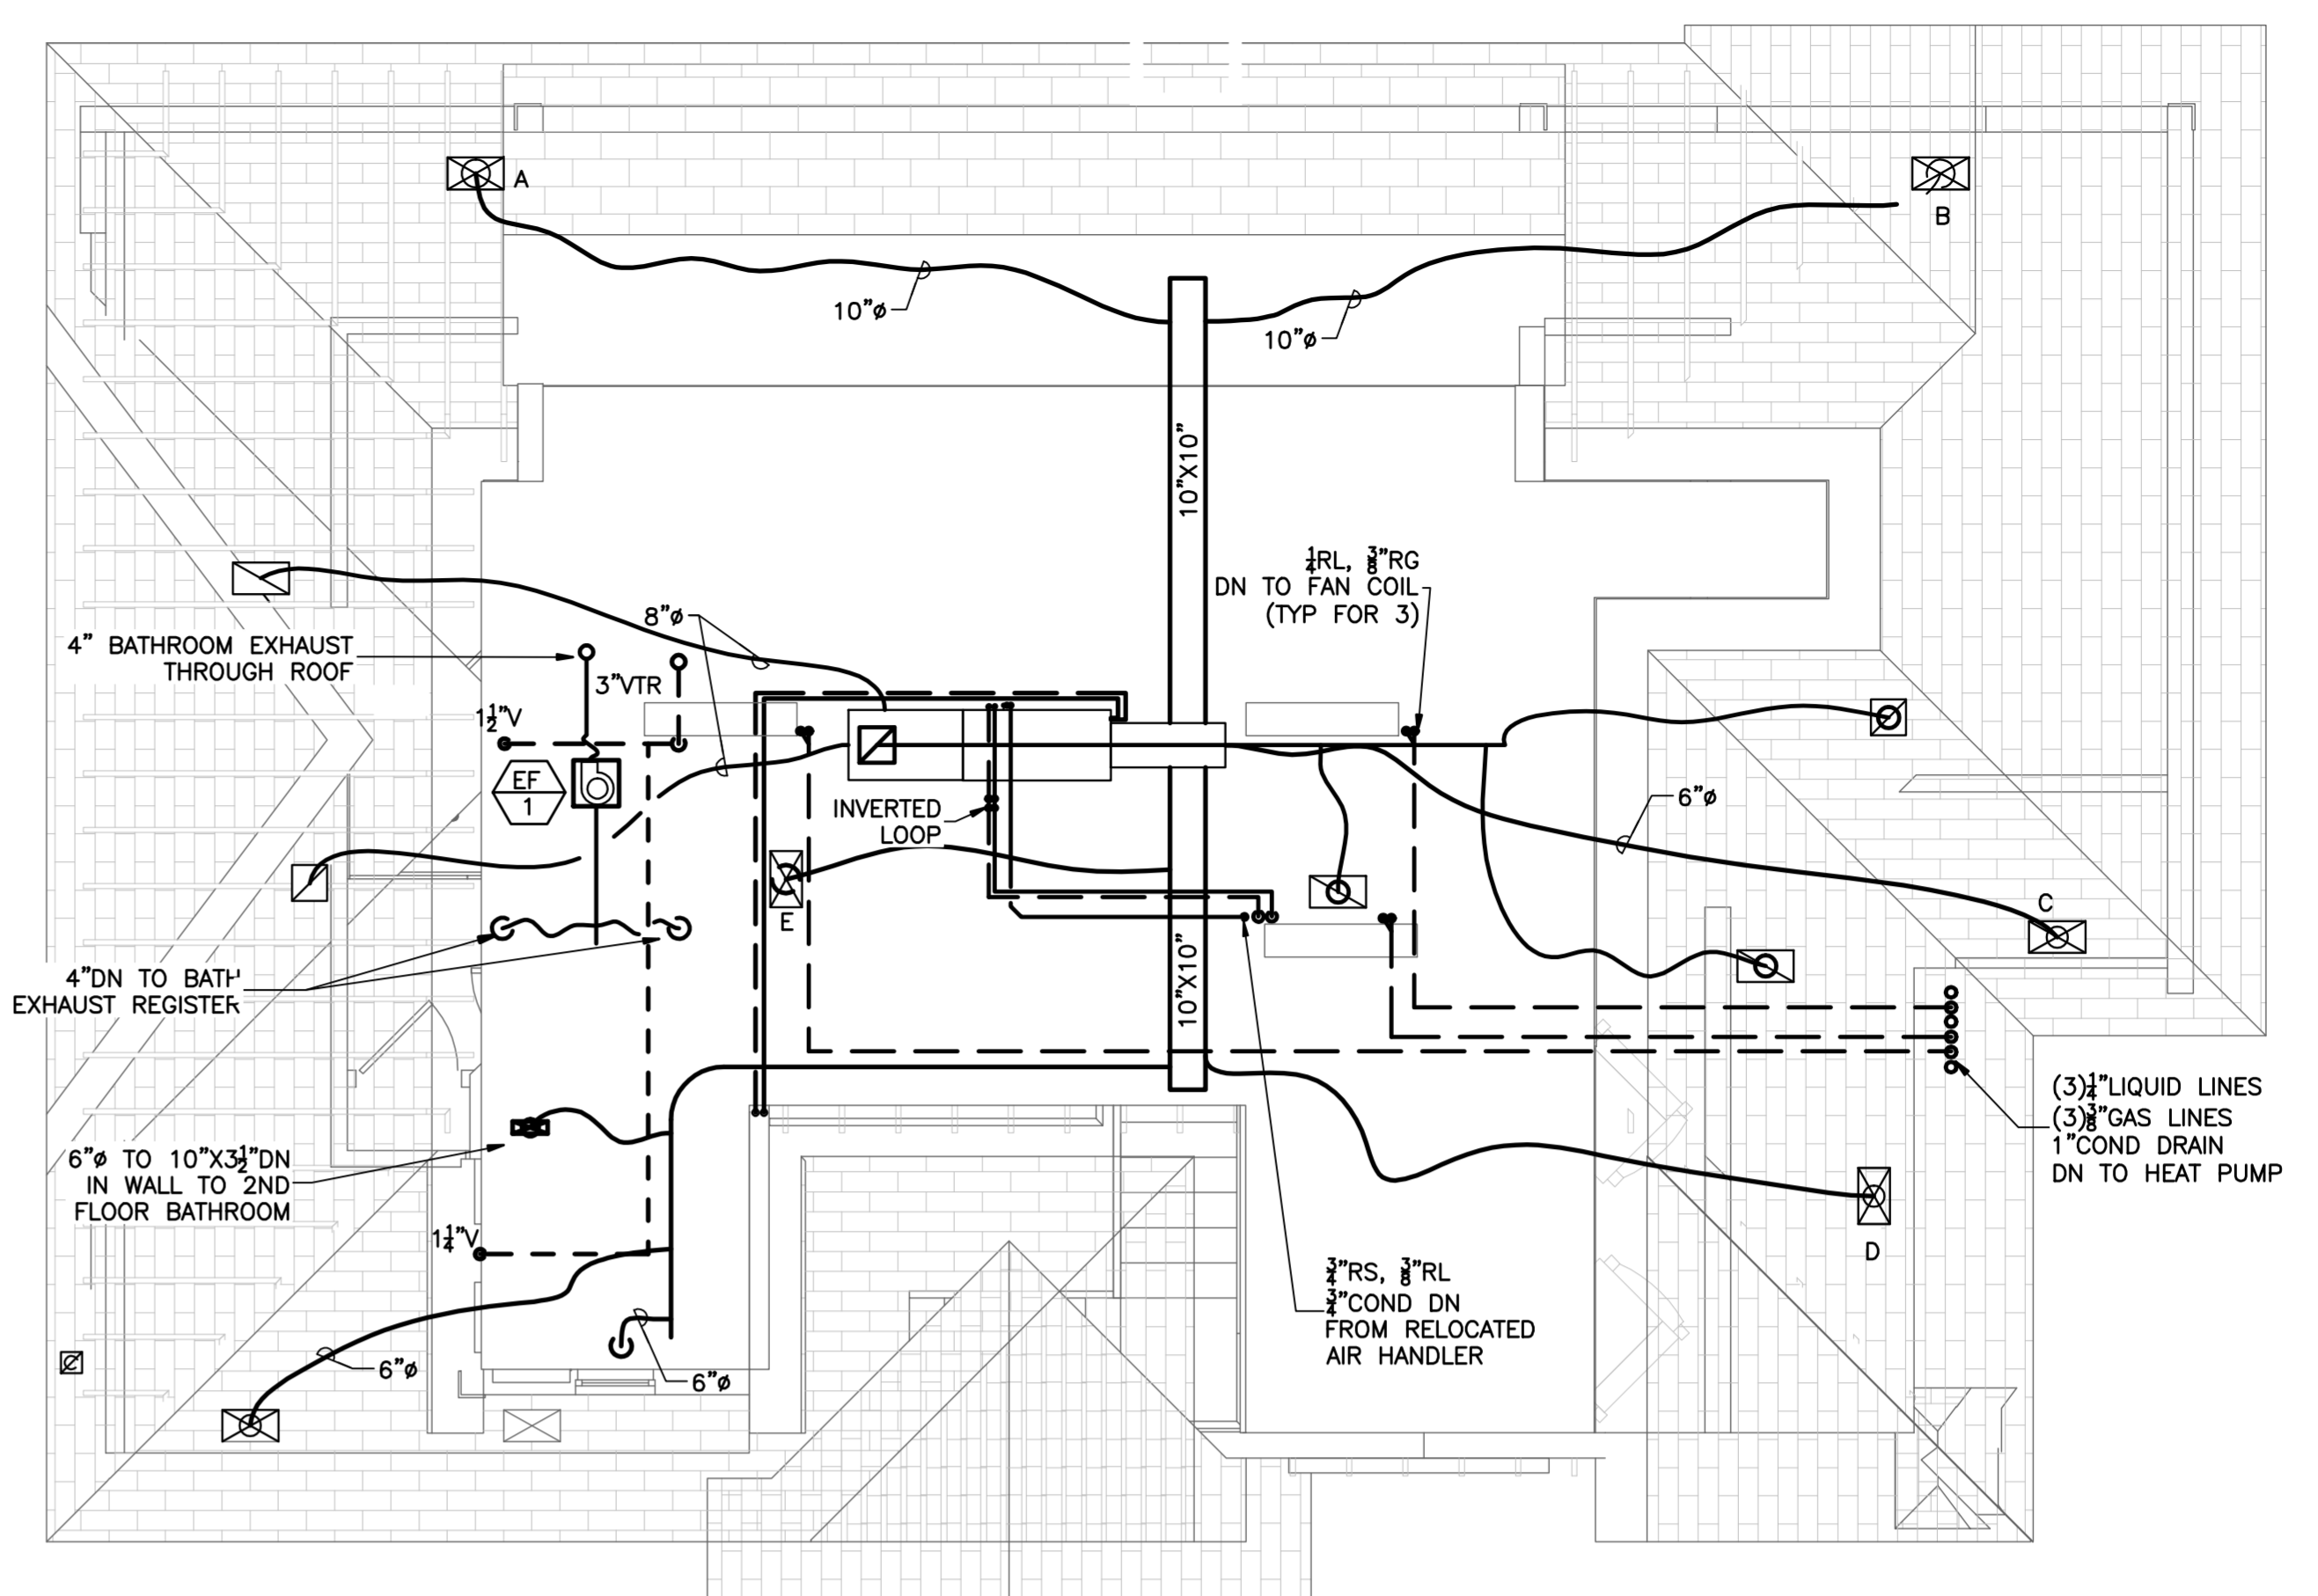

P 01 ATTIC NEW WORK PLAN
1/4"=1'-0"

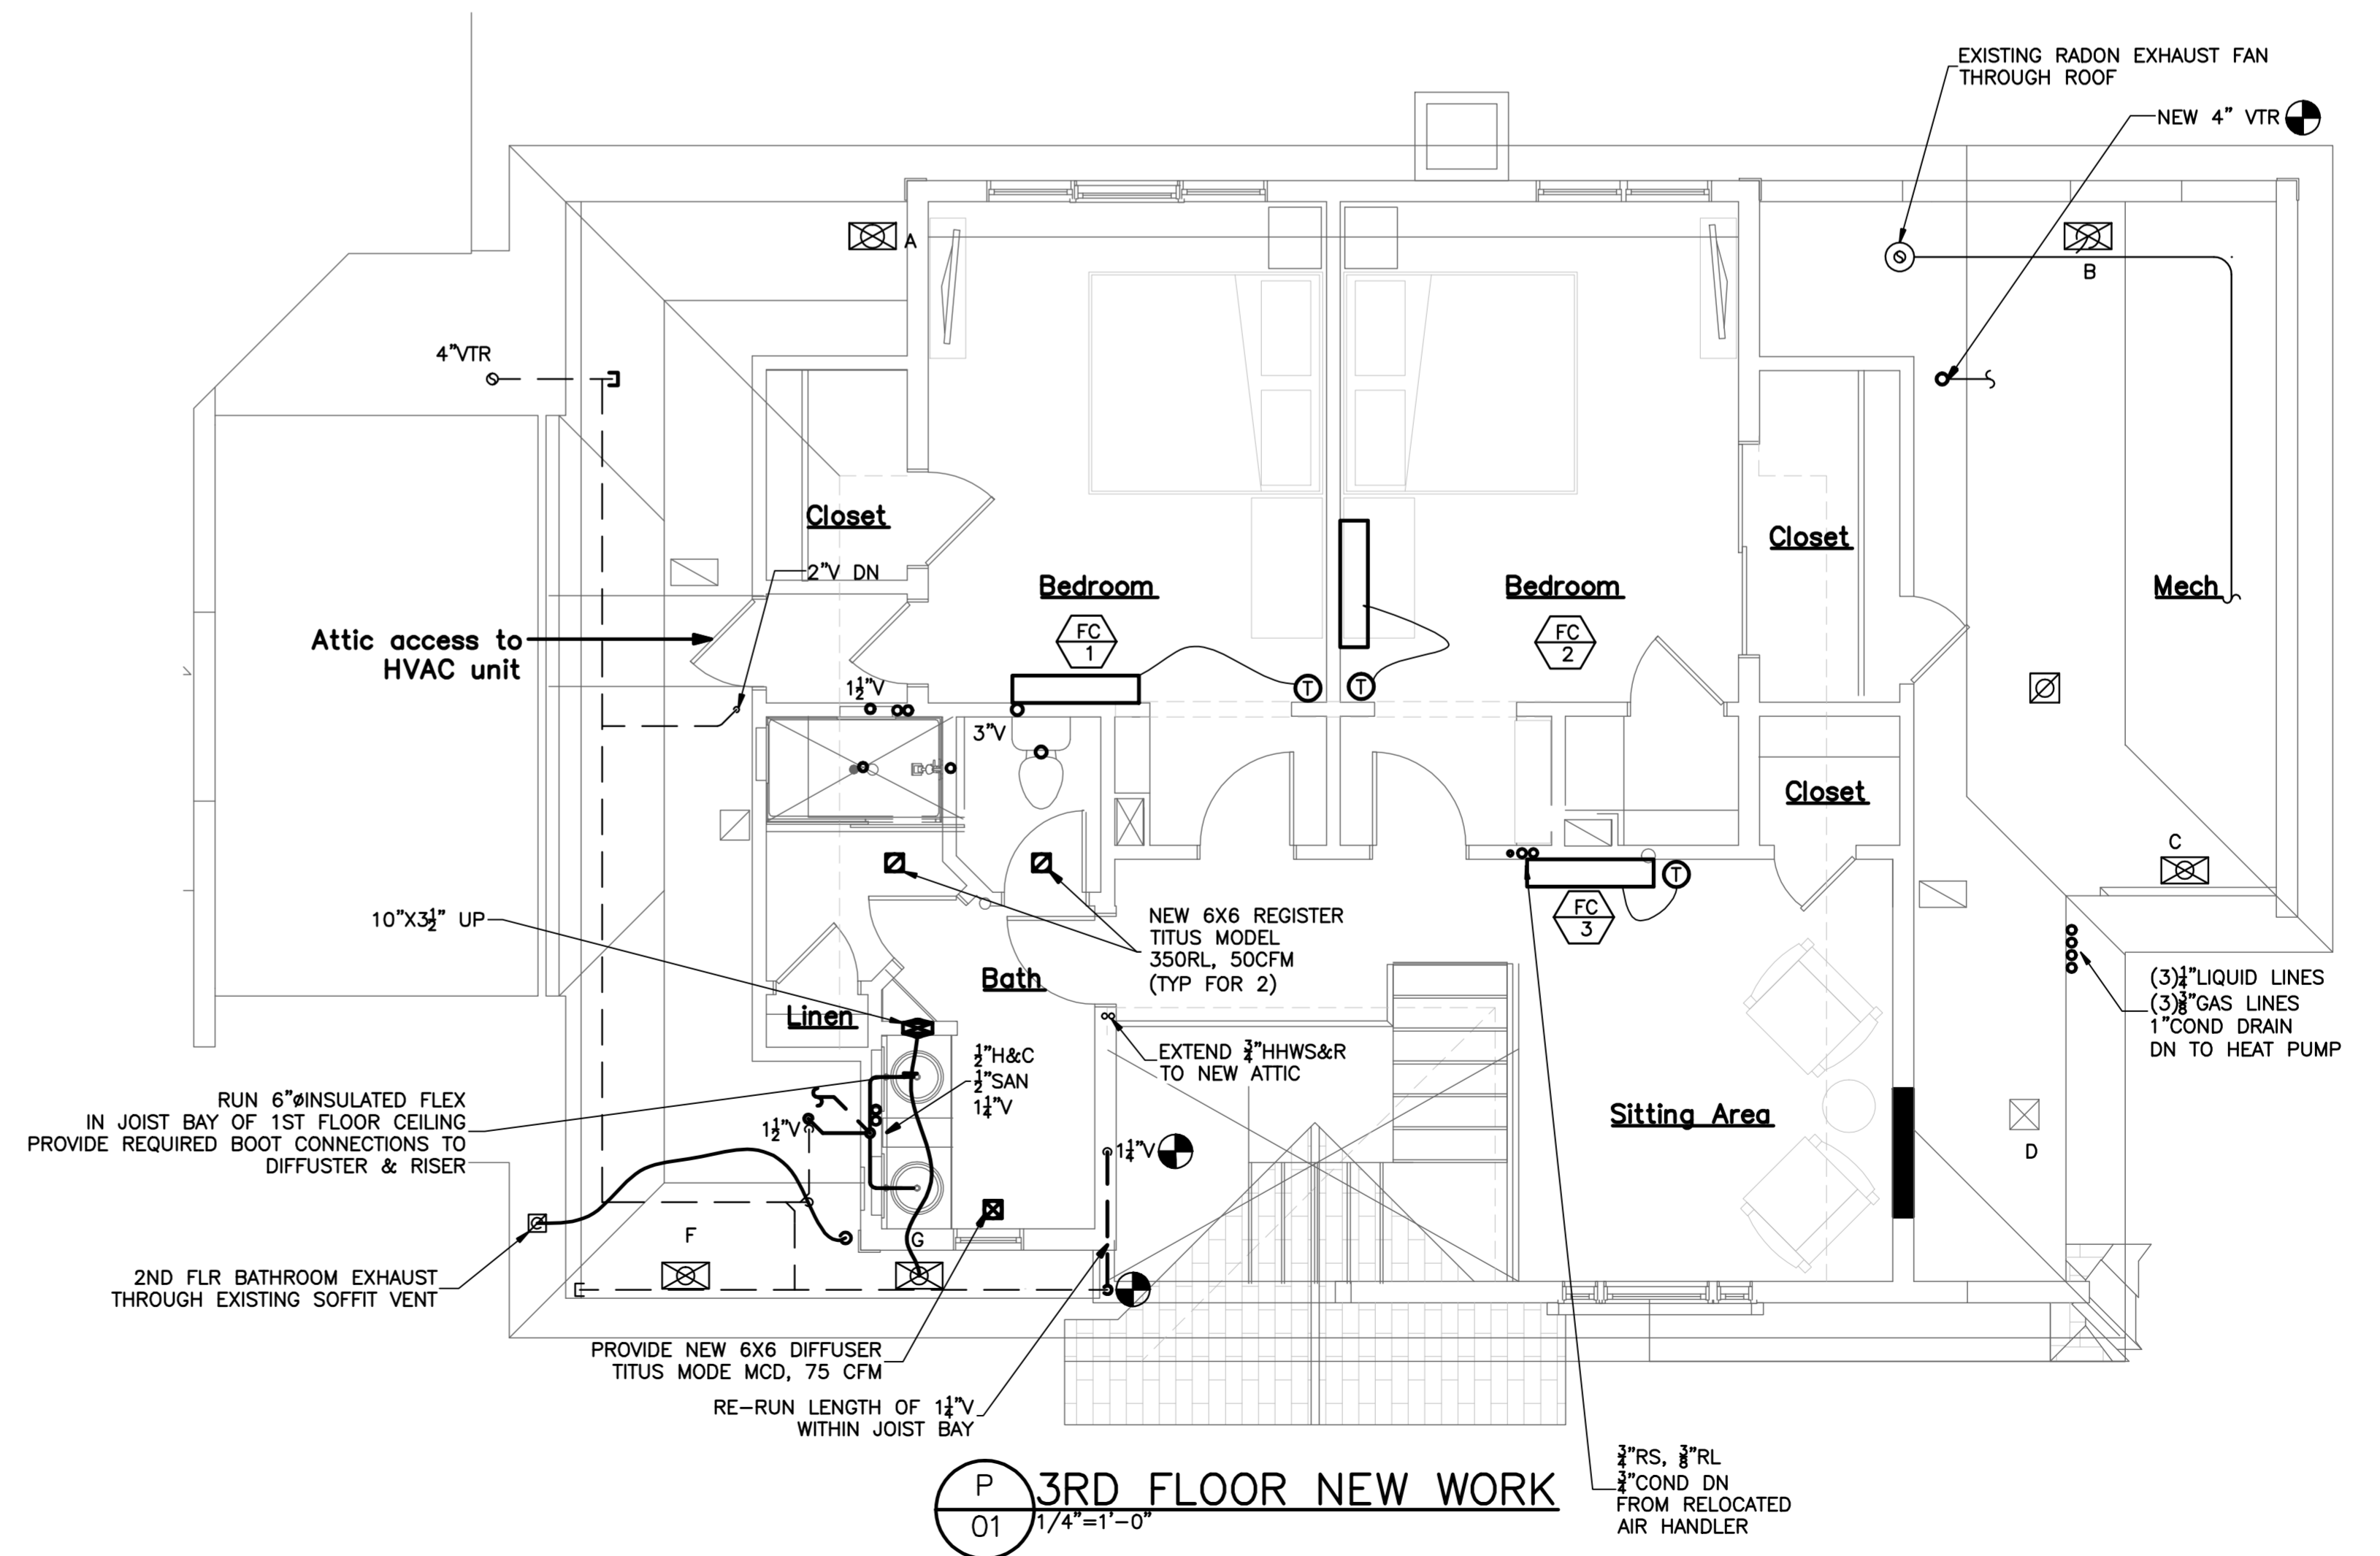

P 01 3RD FLOOR NEW WORK
1/4"=1'-0"

Werth Residence
Renovation
10 Cardinal Drive, Westwood, MA

© 2016 Glenapp Design Associates, LLC
ALL RIGHTS RESERVED. ALL DESIGN, DRAWING, PLANS AND SPECIFICATIONS ARE THE PROPERTY OF GLENAPP DESIGN ASSOCIATES. RIGHTS OF USE ARE CONDITIONAL AND ARE LIMITED TO A ONE-TIME USE TO COMPLETE A SINGLE PROJECT ON THE SITE SO INDICATED. REUSE OF THE WORK AND OR REPRODUCTION OF THESE PLANS FOR ANY OTHER CONSTRUCTION OR PRIMARY APPLICATION IS EXPRESSLY PROHIBITED WITHOUT PRIOR WRITTEN PERMISSION OF GLENAPP DESIGN ASSOCIATES AND THE ARCHITECT. WHOLE OR PARTIAL REUSE OF THESE DRAWINGS IS PROHIBITED.

No.	Date	Description

Project: 682.1
Drawn by: JRW
Check by:
Date: 1/13/17
Scale: As Indicated

**2nd, 3rd, & Attic
New Work
Mechanical
Plans**

M1.3

LEGEND

- LIGHT FIXTURES ARE INDICATED BY VARIOUS SYMBOLS ON THE PLANS, WITH A CAPITAL "TYPE" LETTER AT EACH REFER TO FLOOR PLANS AND LIGHT FIXTURE SCHEDULE.
- ☑ BATHROOM FAN, BY MC.
 - S 20 AMPERE, 120/277 VOLT, SINGLE POLE SWITCH
 - S₃ 20 AMPERE, 120/277 VOLT, THREE WAY SWITCH
 - S₀ 120 VOLT, OCCUPANCY SENSOR WALL SWITCH WITH USER ADJUSTABLE 1-20 MINUTES TIMEOUT
 - ☉ 120 VOLT DUAL TECHNOLOGY CEILING MOUNTED OCCUPANCY SENSOR WITH 360° FIELD OF VIEW AND MINIMUM 1200SF COVERAGE
 - ⌚ NEMA 5-20R DUPLEX RECEPTACLE, TR
 - ⌚ FLOOR MOUNTED NEMA 5-20R DUPLEX RECEPTACLE
 - ▽ VOICE OUTLET JACK, (1) RJ45 WITH CAT 5 CABLE TO NIC IN BASEMENT
 - ◊ CABLE TV OUTLET, (1) TYPE F CONNECTOR WITH RG6/U CABLE TO NIC IN BASEMENT
 - F MOTOR, NUMERAL INDICATES HP, F INDICATES FRACTIONAL HP
 - S_M MANUAL MOTOR STARTER, W/OL PROTECTION 20 AMP, 3 POLE, UNO
 - ⊏ FUSED DISCONNECT, 60 AMP FRAME, 40 AMP TRIP, 2 POLE, UNO
 - ▨ LOADCENTER, AS SCHEDULED.
 - P-1,3 HOMERUN TO PANEL 'P', CIRCUITS 1 AND 3. CIRCUIT WIRING AS BELOW.
 - ⊃ CIRCUIT WIRING, NO HASHES INDICATES (2)#12AWG, (1)#12AWG GND, (1)3/4"C. QTY. OF HASHES INDICATES QTY. OF WIRES IF MORE THAN 2 PLUS GND.
 - ⊚ SMOKE DETECTOR, PHOTO TYPE UNO 'C' DENOTES COMBINATION SMOKE/CARBON MONOXIDE DETECTOR
 - ⊞ EQUIPMENT TAG
 - LINEWEIGHT DENOTES EXISTING
 - LINEWEIGHT DENOTES PROPOSED

ABBREVIATIONS


- | | | | |
|-------|-----------------------------------|------|---|
| A | AMPERE(S) | MEC | MASSACHUSETTS ELECTRIC CODE |
| AFCI | ARC-FAULT CIRCUIT INTERRUPTING | MIN | MINIMUM |
| AFF | ABOVE FINISH FLOOR | MTD | MOUNTED |
| AHU | AIR HANDLING UNIT | NEMA | NATIONAL ELECTRICAL MANUFACTURERS ASSOCIATION |
| AWG | AMERICAN WIRE GAUGE | NIC | NETWORK INTERFACE |
| C | CONDUIT | P | POLE(S) |
| CB | CIRCUIT BREAKER | PH | PHASE(S) |
| CP | CIRCULATOR PUMP | QTY | QUANTITY |
| CU | COPPER | SBA | SELECTED BY ARCHITECT |
| EF | EXHAUST FAN | SBO | SELECTED BY OWNER |
| FBO | FURNISHED BY OWNER | TR | TAMPER RESISTANT |
| FC | FAN COIL UNIT | TYP | TYPICAL |
| G,GND | GROUND | UL | UNDERWRITERS LABORATORY |
| GC | GENERAL CONTRACTOR | UNO | UNLESS NOTED OTHERWISE |
| GF | GROUND FAULT CIRCUIT INTERRUPTING | V | VOLT(S) |
| HP | HORSE POWER, HEAT PUMP | VA | VOLT AMPERE |
| KVA | KILOVOLT AMPERE | W | WIRE |
| LED | LIGHT EMITTING DIODE | WH | WATER HEATER |
| MC | METAL CLAD, MECHANICAL CONTRACTOR | WP | WEATHERPROOF |
| | | WR | WEATHER RESISTANT |
| | | ZP | ZONE PUMP |

GENERAL NOTES

- ALL WORK SHALL COMPLY COMPLETELY WITH THE MASSACHUSETTS ELECTRICAL CODE, AND ALL LOCAL ORDINANCES AND REQUIREMENTS.
- THE DRAWINGS ARE GENERALLY DIAGRAMMATIC. PROVIDE ALL MATERIAL, LABOR AND EQUIPMENT FOR COMPLETE AND OPERATIONAL SYSTEMS.
- APPLY FOR, OBTAIN AND PAY FOR ALL REQUIRED PERMITS, REQUEST, SCHEDULE, AND ATTEND ALL REQUIRED INSPECTIONS BY THE LOCAL AUTHORITY HAVING JURISDICTION.
- REFER TO DRAWINGS OF OTHER TRADES AND CONFIRM EQUIPMENT LOCATIONS PRIOR TO ROUGH-IN. ADJUST ELECTRICAL WORK AS REQUIRED BASED ON EQUIPMENT PURCHASED/INSTALLED.
- PROVIDE A ONE YEAR MATERIAL AND LABOR GUARANTEE AGAINST DEFECTS IN MATERIAL AND WORKMANSHIP.
- ALL MATERIAL INCORPORATED IN THE WORK SHALL BE LISTED FOR THE INTENDED USE.
- VISIT THE SITE PRIOR TO SUBMITTING BID TO REVIEW SCOPE OF WORK AND CONDITIONS UNDER WHICH NEW WORK MUST BE PROVIDED.

NOTES

- PROVIDE #8/3 TYPE MC CABLE FROM NEW 40A/2P CIRCUIT BREAKER AT PANEL P1/P2 TO SERVE NEW ATTIC LOADCENTER PA.
- CONNECT NEW SMOKE DETECTORS AND COMBINATION SMOKE/CARBON MONOXIDE DETECTORS TO EXISTING SECURITY/ALARM SYSTEM. NEW DEVICES SHALL BE LISTED COMPATIBLE WITH ADT SAFEWATCH PRO 3000EN SECURITY/ALARM SYSTEM. PROVIDE ALL REQUIRED WIRING AND APPURTENANCES REQUIRED FOR A COMPLETE, OPERATIONAL SYSTEM.
- DISCONNECT, REMOVE AND SAFELY STORE EXISTING CHANDELIER TO ALLOW NEW CONSTRUCTION. RE-LAMP AND RE-INSTALL CHANDELIER AS INDICATED.

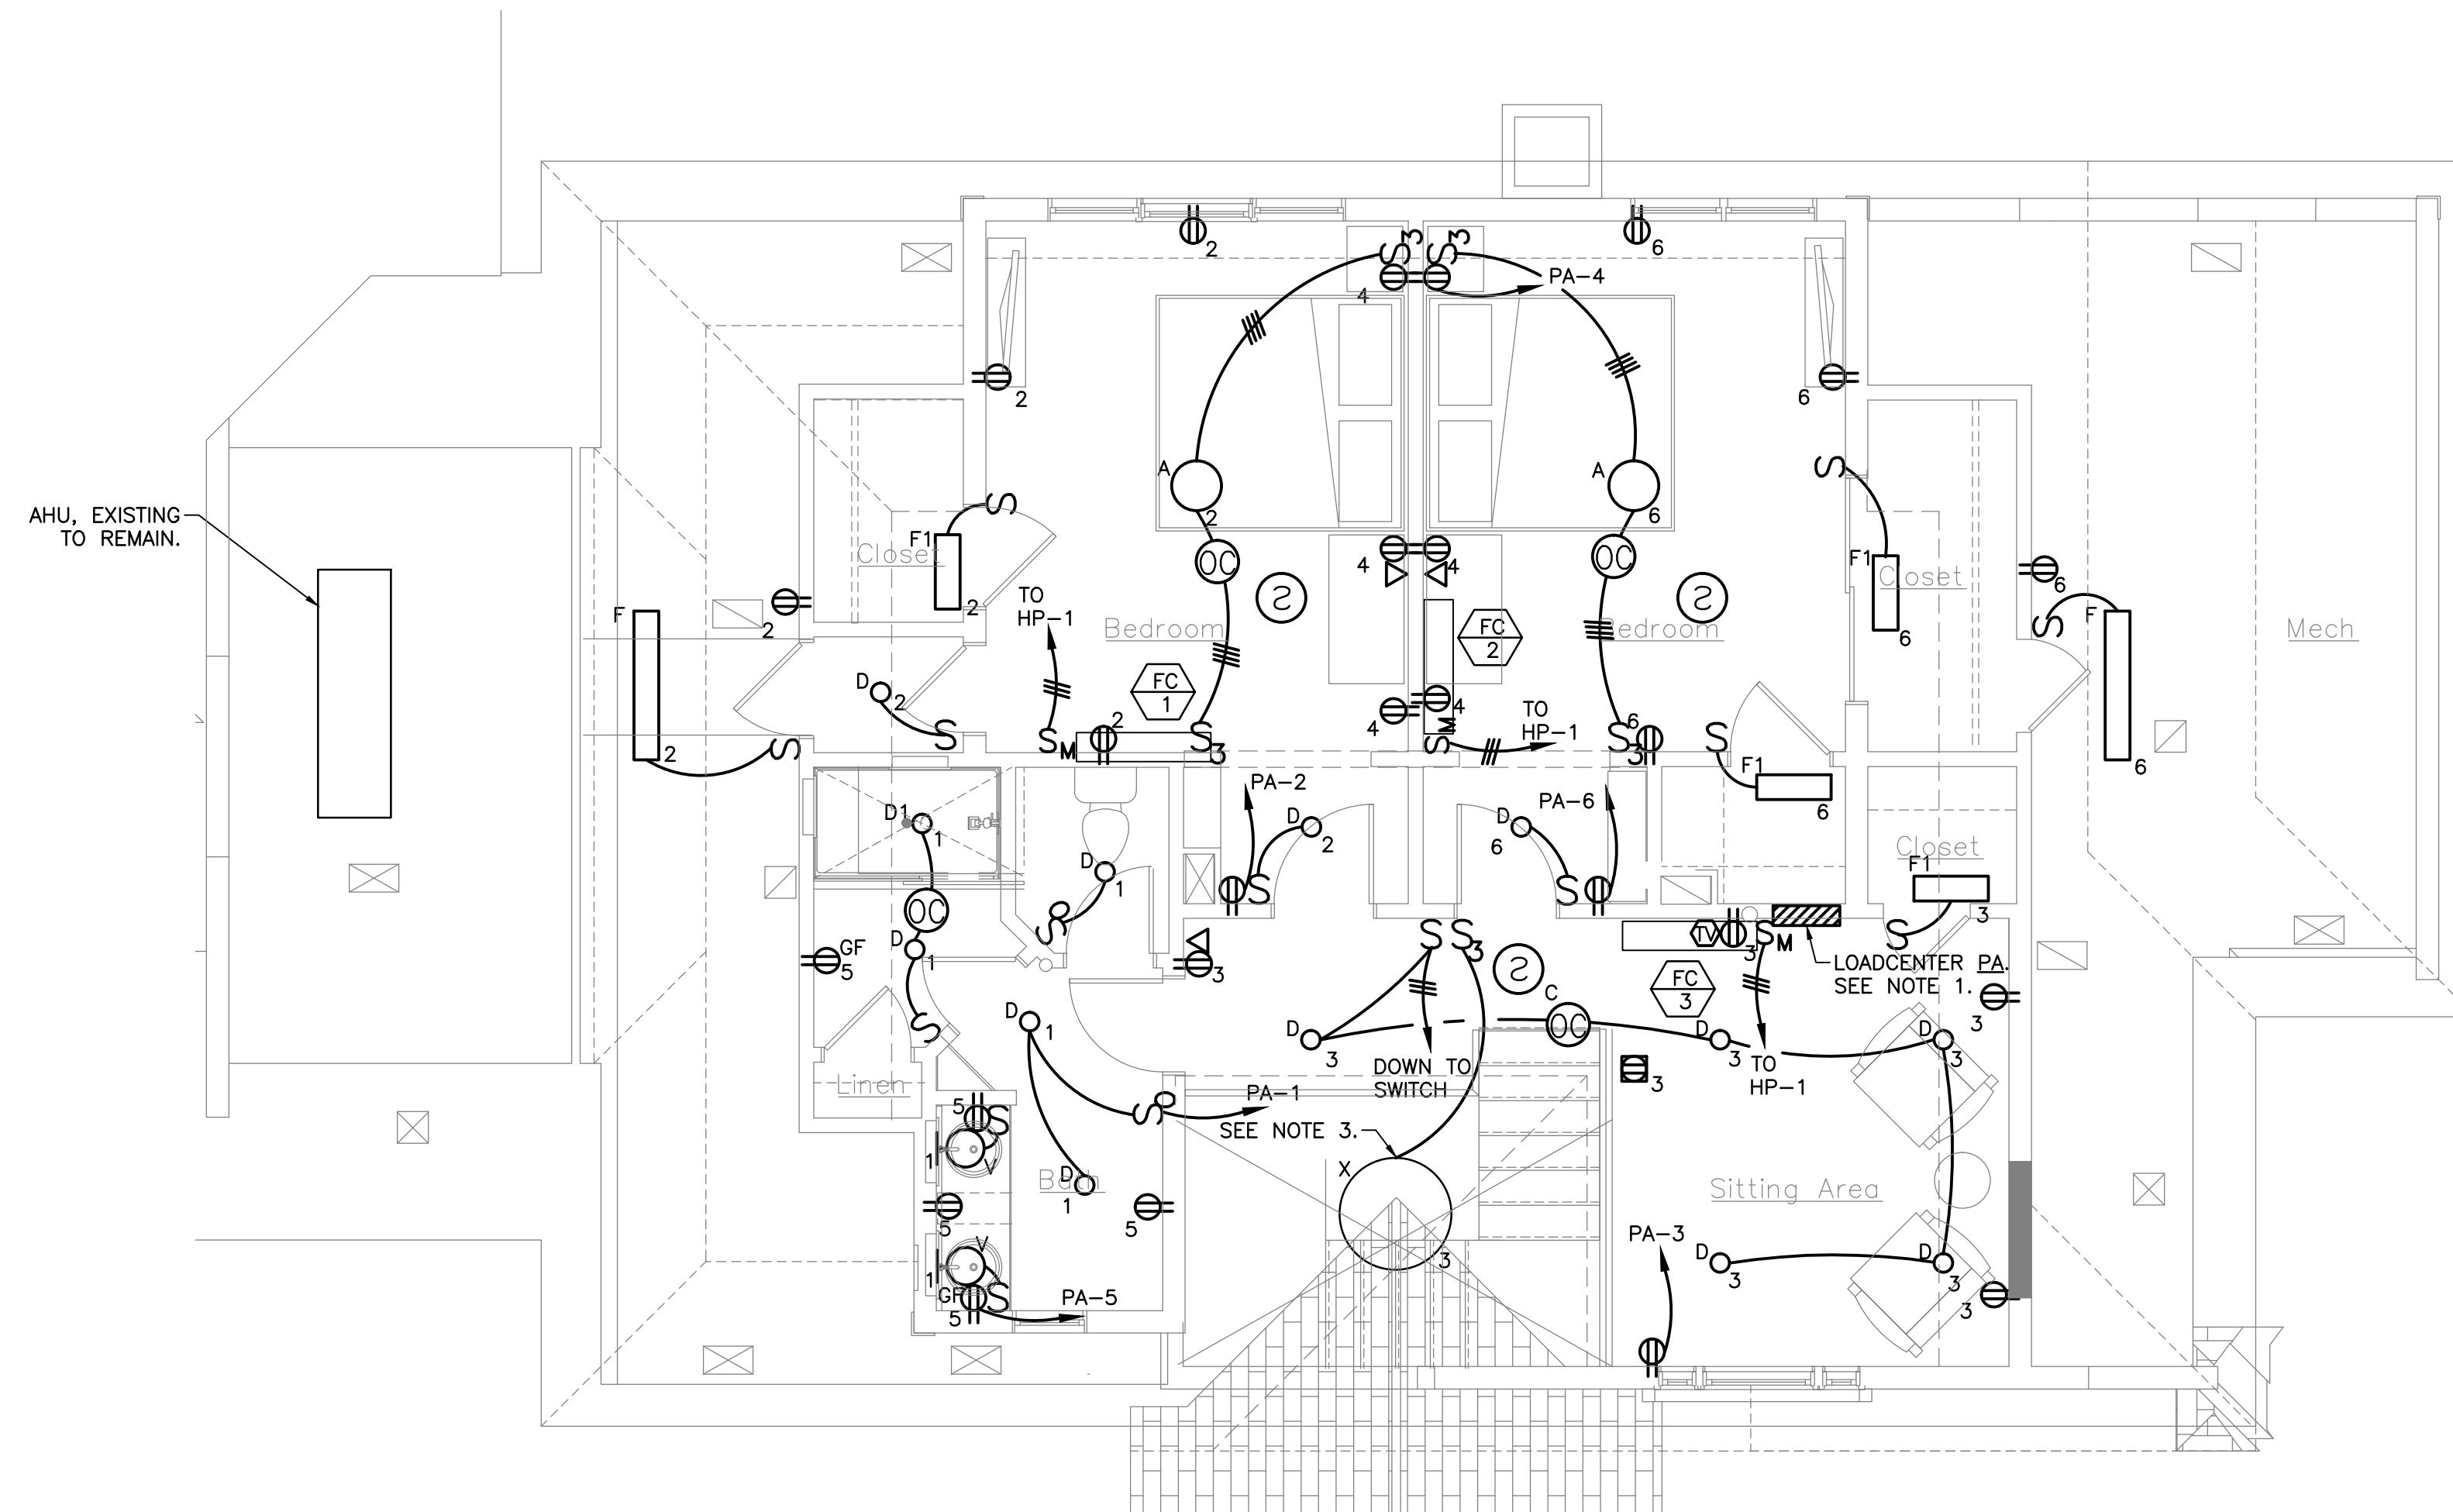

PROPOSED THIRD FLOOR PLAN
SCALE: 1/4"=1'-0"

LIGHTING FIXTURE SCHEDULE

TYPE	MANUFACTURER	CATALOG NUMBER	LAMP TYPE	NO. OF LAMPS	INPUT VOLTS	WATTS	REMARKS
A	SBA		LED	-	120		LED CEILING MOUNTED LIGHT, SBA.
B	SBA		LED	-	120		LED BATHROOM CEILING MOUNTED LIGHT, SBA.
D	LITON	LHFRLD609C35/LRLDH642C	LED	-	120	9	LED 6" 700 LUMEN DOWN LIGHT.
D1	LITON	LHFRLD609C35/LRLDH642C-WL	LED	-	120	9	LED 6" 700 LUMEN DOWN LIGHT, SUITABLE FOR WET LOCATIONS.
F	COLUMBIA	LCL4-35ML-EU	LED	-	120	48	4' 5000 LUMEN LED LENSED STRIP LIGHT.
F1	COLUMBIA	LBIL2-35MW-EU	LED	-	120	21	2' 2000 LUMEN LED LENSED STRIP LIGHT WITH INTEGRAL OCCUPANCY SENSOR. WALL MOUNTED ABOVE DOOR.
X	EXISTING			-	120	-	EXISTING CHANDELIER
V	SBA		LED	-	120	-	LED VANITY LIGHT, SBA, WALL MOUNTED ABOVE VANITY MIRROR.

SPECIFICATIONS

- WIRING DEVICES SHALL BE SPECIFICATION GRADE, 20A, WITH SMOOTH PLASTIC DEVICE PLATES AS MANUFACTURED BY LEGRAND. COLOR AS SBA.
- ALL RECEPTACLES SHALL BE TAMPER RESISTANT. OUTDOOR SHALL BE WR, WP RECEPTACLES SHALL HAVE METALLIC COVERS RATED WEATHERPROOF WHILE IN USE.
- RECEPTACLES IN BATHS SHALL BE DECORA STYLE TO MATCH OF RECEPTACLES.
- CONDUCTORS AND CABLE SHALL BE MINIMUM #12 AWG, 600V, COPPER WITH TYPE THWN-THHN INSULATION. PROVIDE SEPARATE GREEN GROUND IN ALL FEEDERS. WIRE SHALL BE STRANDED. COLOR CODE CONDUCTORS BLACK, RED, BLUE, WITH WHITE NEUTRAL AND GREEN GROUND EXCEPT AS NOTED FOR 120 VOLT.
 - NEC TYPE MC: UL 1569, WITH FULL SIZE GROUNDING CONDUCTOR, AND STEEL OR ALUMINUM INTERLOCKED ARMOR SHEATH. MC CABLE SHALL BE USED IN CONCEALED LOCATIONS ONLY.
 - NEC TYPE NM-B: UL 719, WITH GROUNDING CONDUCTOR. USE FOR GENERAL PURPOSE BRANCH CIRCUIT WIRING THROUGHOUT, EXCEPT WHERE OTHER WIRING METHODS ARE REQUIRED ELSEWHERE IN THIS SPECIFICATION OR BY CODE.
- BOXES - UL LISTED NEMA OS1, WITH MARKED VOLUME. SIZE BOXES IN ACCORDANCE WITH VOLUME REQUIREMENTS OF MEC.
 - OUTLET BOXES SHALL BE SPECIFICALLY DESIGNED FOR THE CONSTRUCTION ENCOUNTERED, WITH SUITABLE SUPPORTS AND ATTACHMENTS.
 - OUTLET BOXES SHALL BE NON-METALLIC, IN GANGS AND CONFIGURATIONS TO SUIT THE APPLICATION, WITH SUITABLE WIRE/CABLE CLAMPS AS REQUIRED. OUTLET BOXES SHALL BE FLUSH MOUNTED IN ALL FINISHED AREAS. CEILING OUTLET BOXES SHALL BE LISTED AND RATED FOR SUPPORT OF LIGHT FIXTURES UP TO 50 POUNDS. OUTLET BOXES SHALL BE REINFORCED FIBERGLASS AS MANUFACTURED BY ALLIED MOULDED, RIGID THERMOPLASTIC AS MANUFACTURED BY CARLON ("SUPERBLUE"), OR REINFORCED PHENOLIC AS MANUFACTURED BY UNION, STEEL CITY.
- SURFACE MOUNTED OUTLET BOXES SHALL BE SPECIFICALLY DESIGNED FOR THE CONSTRUCTION ENCOUNTERED, WITH SUITABLE SUPPORTS AND ATTACHMENTS. OUTLET BOXES SHALL BE METALLIC, IN GANGS AND CONFIGURATIONS TO SUIT THE APPLICATION. OUTLET BOXES MAY BE SURFACE MOUNTED IN UNFINISHED AREAS.
- FLOOR BOXES: UL LISTED, CAST IRON, WATER TIGHT CONSTRUCTION FOR ANY GRADE APPLICATION, WITH SCREW ANCHORAGE FLANGES AT EACH CORNER.
- FLOOR BOX COVER PLATE: FLIP LID, PIN HINGED, ¼ INCH (6 MM) THICK, FABRICATED FOR SEAMLESS ATTACHMENT TO FLOOR BOX WITH SCREWS OF SAME MATERIAL AS COVER PLATE. MATERIAL: BRASS.
- LOADCENTERS SHALL BE PLUG-ON CIRCUIT BREAKER TYPE WITH COPPER LOAD, NEUTRAL AND GROUND BUS. MINIMUM INTERRUPTING CAPACITY SHALL BE 10,000 AMPS SYMMETRICAL AT 240 VOLTS. PROVIDED WITH NEMA 1 ENCLOSURE WITH LOCKING DOOR. LOADCENTER AND BREAKERS SHALL BE SQUARE D QO TYPE. PROVIDE TYPED IDENTIFICATION DIRECTORY IN LOADCENTERS INDICATING CIRCUIT FUNCTION OR EQUIPMENT SERVED.
- MOUNTING HEIGHTS OF ELECTRICAL EQUIPMENT SHALL BE AS FOLLOWS UNLESS OTHERWISE NOTED:
 - LOADCENTERS - 6"-6" FROM FLOOR TO TOP.
 - LIGHT SWITCHES & LIGHTING CONTROLS - 4'-0" FROM FLOOR TO CENTERLINE.
 - LIGHTING FIXTURES - SEE LTG. FIXTURE SCHEDULE.
 - CONVENIENCE RECEPTACLE - 1'-6" FROM FLOOR TO CENTERLINE, UNO.
 - TELEPHONE & CABLE TV OUTLETS - 1'-6" FROM FLOOR TO CENTERLINE, UNO BY ARCHITECT.
- PROVIDE ALL GROUNDING AND BONDING AS REQUIRED BY THE MEC. GREEN EQUIPMENT GROUNDING CONDUCTORS SHALL BE INSTALLED IN ALL RACEWAYS.

LOADCENTER SCHEDULE

PANEL NO. PA

120/240 VOLTS 1 PH W 3 G# MAIN CB MLO BUS100A MIN. AIC 10K SYMM.

CKT NO.	TRIP AMPS	DESCRIPTION OF LOAD	PER PHASE		LOAD (KVA)	DESCRIPTION OF LOAD	TRIP AMPS	CKT NO.
			A	B				
1	20/1	BATHROOM LIGHTING & FAN	-	-	-	BEDROOM LIGHTING AND RECEPT	20/1	2
3	20/1	SITTING AREA LIGHTING AND RECEPT	-	-	-	BEDROOM RECEPT	20/1	4
5	20/1	BATHROOM RECEPTACLE	-	-	-	BEDROOM LIGHTING AND RECEPT	20/1	6
7	20/1	SPARE	-	-	-	SPARE	20/1	8
9	20/1	SPARE	-	-	-	SPARE	20/1	10
11	20/1	SPARE	-	-	-	SPARE	20/1	12
11	20/1	SPARE	-	-	-	SPARE	20/1	12
TOTAL VA BY PHASE						TOTAL LOAD	KVA	AMPS

NOTE: ALL 20A/1P CIRCUIT BREAKERS SHALL BY AFCI TYPE.

BRANCH CIRCUIT AND FEEDER SCHEDULE

INDICATES NOMINAL AMPACITY
INDICATES QUANTITY OF PHASE AND/OR NEUTRAL CONDUCTORS

NOM. AMPACITY	QTY. OF COND.	PHASE AND/OR NEUTRAL CONDUCTORS AND GROUND	RACEWAY SIZE	
			EMT	RGS
20	2	(2)#12 & 1#12 GND.	3/4"	3/4"
	3	(3)#12 & 1#12 GND.	3/4"	3/4"
	4	(4)#12 & 1#12 GND.	3/4"	3/4"
30	2	(2)#10 & 1#10 GND.	3/4"	3/4"
	3	(3)#10 & 1#10 GND.	3/4"	3/4"
40	2	(2)#8 & 1#10 GND.	3/4"	3/4"
	3	(3)#8 & 1#10 GND.	3/4"	3/4"
50	2	(2)#8 & 1#10 GND.	3/4"	3/4"
	3	(3)#8 & 1#10 GND.	3/4"	3/4"
60	2	(2)#8 & 1#10 GND.	3/4"	3/4"
	3	(3)#8 & 1#10 GND.	3/4"	3/4"
70	2	(2)#4 & 1#8 GND.	1"	1"
	3	(3)#4 & 1#8 GND.	1"	1"
100	2	(2)#3 & 1#8 GND.	1 1/4"	1 1/4"
	3	(3)#3 & 1#8 GND.	1"	1"
	4	(4)#3 & 1#8 GND.	1 1/4"	1 1/4"

- NOTES -
- RACEWAY SIZE BASED ON EMT/RGS TYPE THWN COPPER CONDUCTORS. ADJUST AS REQUIRED FOR OTHER RACEWAY OR CONDUCTOR TYPES.
 - BASED ON 75°C TERMINATIONS. ADJUST FOR OTHER TERMINATION TEMPERATURE LIMITATIONS AS REQUIRED.

© 2015 Gienapp Design Associates, LLC
ALL RIGHTS RESERVED. ALL IDEAS, DESIGNS, PLANS AND SPECIFICATIONS ARE THE PROPERTY OF GIENAPP DESIGN ASSOCIATES. RIGHTS OF USE ARE CONDITIONAL AND ARE LIMITED TO A ONE-TIME USE TO CONSTRUCT A SINGLE PROJECT ON THE SITE SO INDICATED. USE OF THE WORK AND ANY DERIVATIVE WORK COVERED UNDER THIS COPYRIGHT FOR OTHER PROJECTS IS PROHIBITED. THE USE OR REPRODUCTION OF THESE PLANS FOR ANY OTHER CONSTRUCTION OR PERMIT APPLICATION IS STRICTLY PROHIBITED WITHOUT PRIOR WRITTEN PERMISSION OF GIENAPP DESIGN ASSOCIATES AND THE ARCHITECT. THESE PLANS AND SEALS MAY BE REPRODUCED BY THESE DRAWINGS.

Revisions	Date

Project: 622.1
Drawn by: CWN
Check by: GPN
Date: 1/17/17
Scale: 1/4" = 1'-0"

ELECTRICAL LEGEND, NOTES AND PLANS


E-1

P:\01-050021-Werthwood\Werth Residence Area Rev02-17\DWG\LEGEND AND SPECIFICATIONS\02-17 Werth Residence_101.rvt

IF THIS SHEET IS NOT 24 X 36 IT IS A REDUCED SCALE PRINT - SCALE ACCORDINGLY

NANGLE ENGINEERING INCORPORATED

32 Prince Street
 Danvers, MA 01923
 Tel. (978) 777-7650
 www.nangleengineering.com

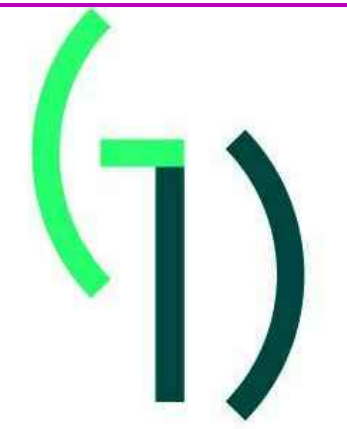

GIENAPP DESIGN
 ARCHITECTURE

20 Conant Street
 Danvers, MA 01923
 978.750.9062
 gienappdesign.com

Werth Residence
 Renovation
 10 Cardinal Drive, Westwood, MA

Plot Date: 11/23/2016 10:09:47 AM


© 2015 Gienapp Design Associates, LLC
 ALL RIGHTS RESERVED. ALL IDEAS, DESIGNS, PLANS AND SPECIFICATIONS ARE THE PROPERTY OF GIENAPP DESIGN ASSOCIATES. RIGHTS OF USE ARE CONDITIONAL AND ARE LIMITED TO A ONE-TIME USE TO CONSTRUCT A SINGLE PROJECT ON THE SITE SO INDICATED. USE OF THE WORK AND ANY DERIVATIVE WORK COVERED UNDER THIS COPYRIGHT FOR OTHER PROJECTS IS PROHIBITED. THE USE OR REPRODUCTION OF THESE PLANS FOR ANY OTHER CONSTRUCTION OR PERMIT APPLICATION IS STRICTLY PROHIBITED WITHOUT PRIOR WRITTEN PERMISSION OF GIENAPP DESIGN ASSOCIATES AND THE ARCHITECT WHOSE SIGNATURE AND SEAL MAY BE REQUIRED FOR THESE DRAWINGS.

Revisions	Date


Project: 622.1
 Drawn by: CWN
 Check by: GPN
 Date: 1/17/17
 Scale: 1/4" = 1'-0"

ELECTRICAL PART PLANS


E-2

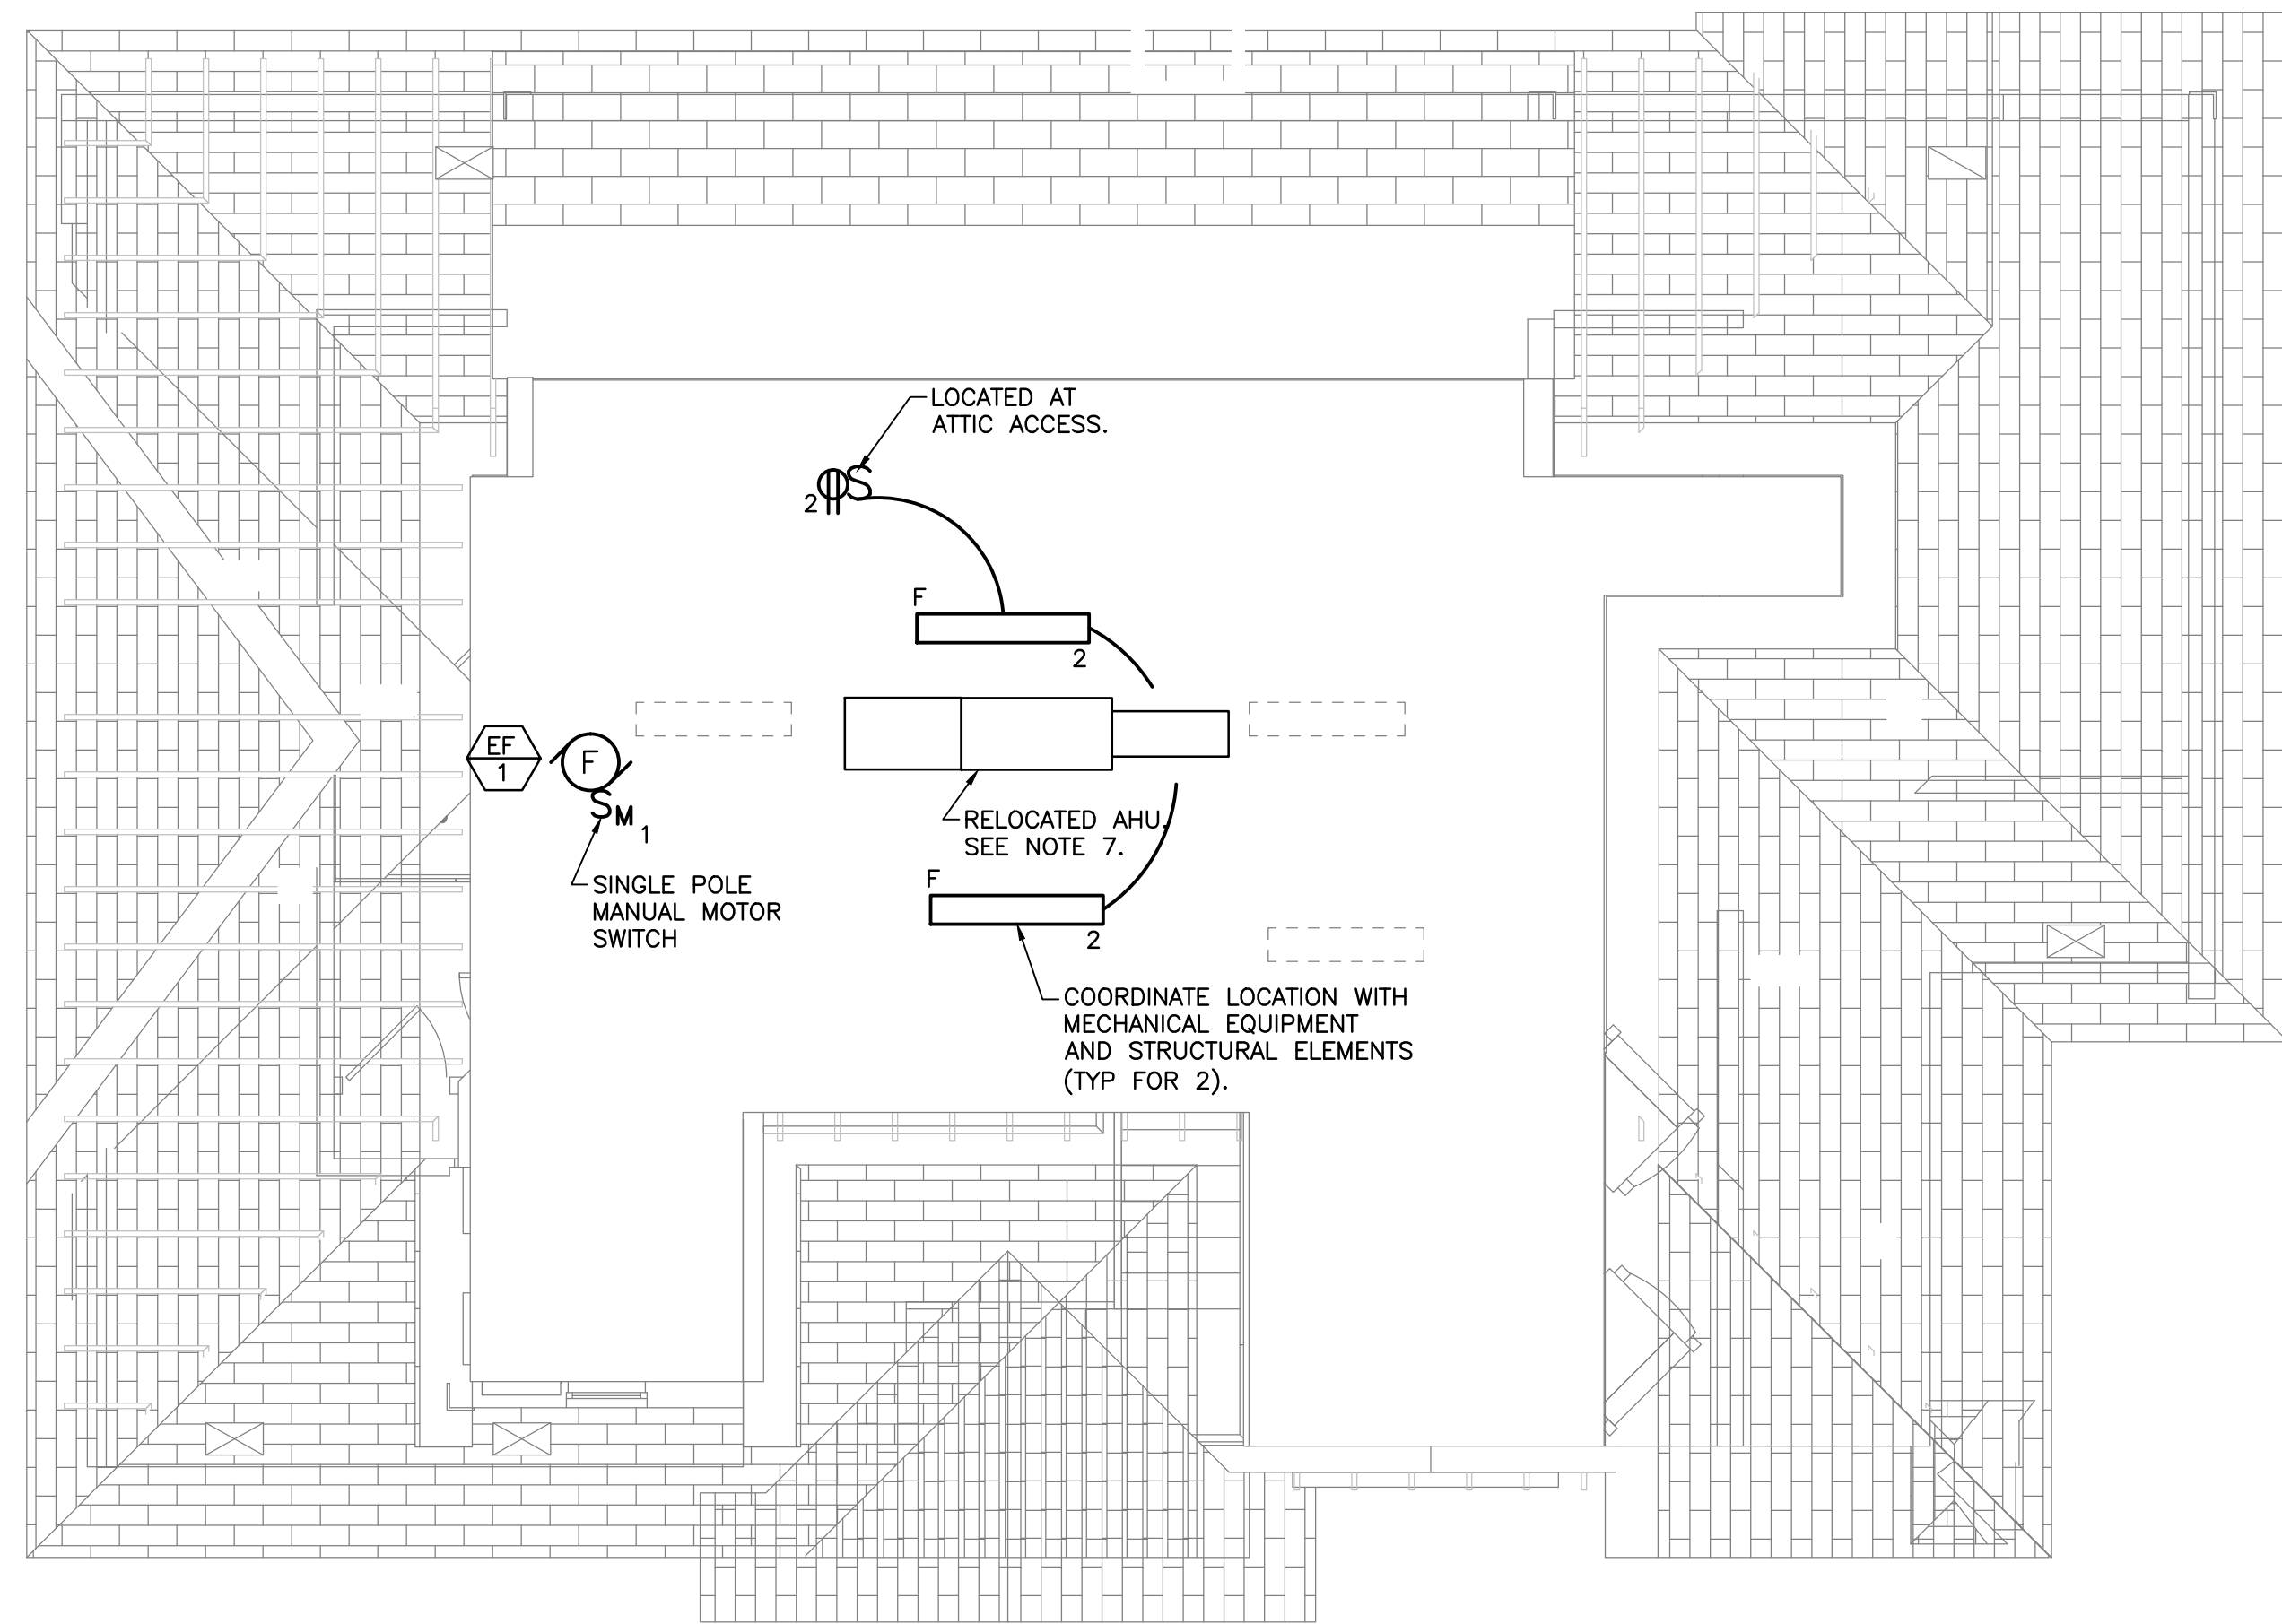

PROPOSED ATTIC PLAN
 SCALE: 1/4"=1'-0"

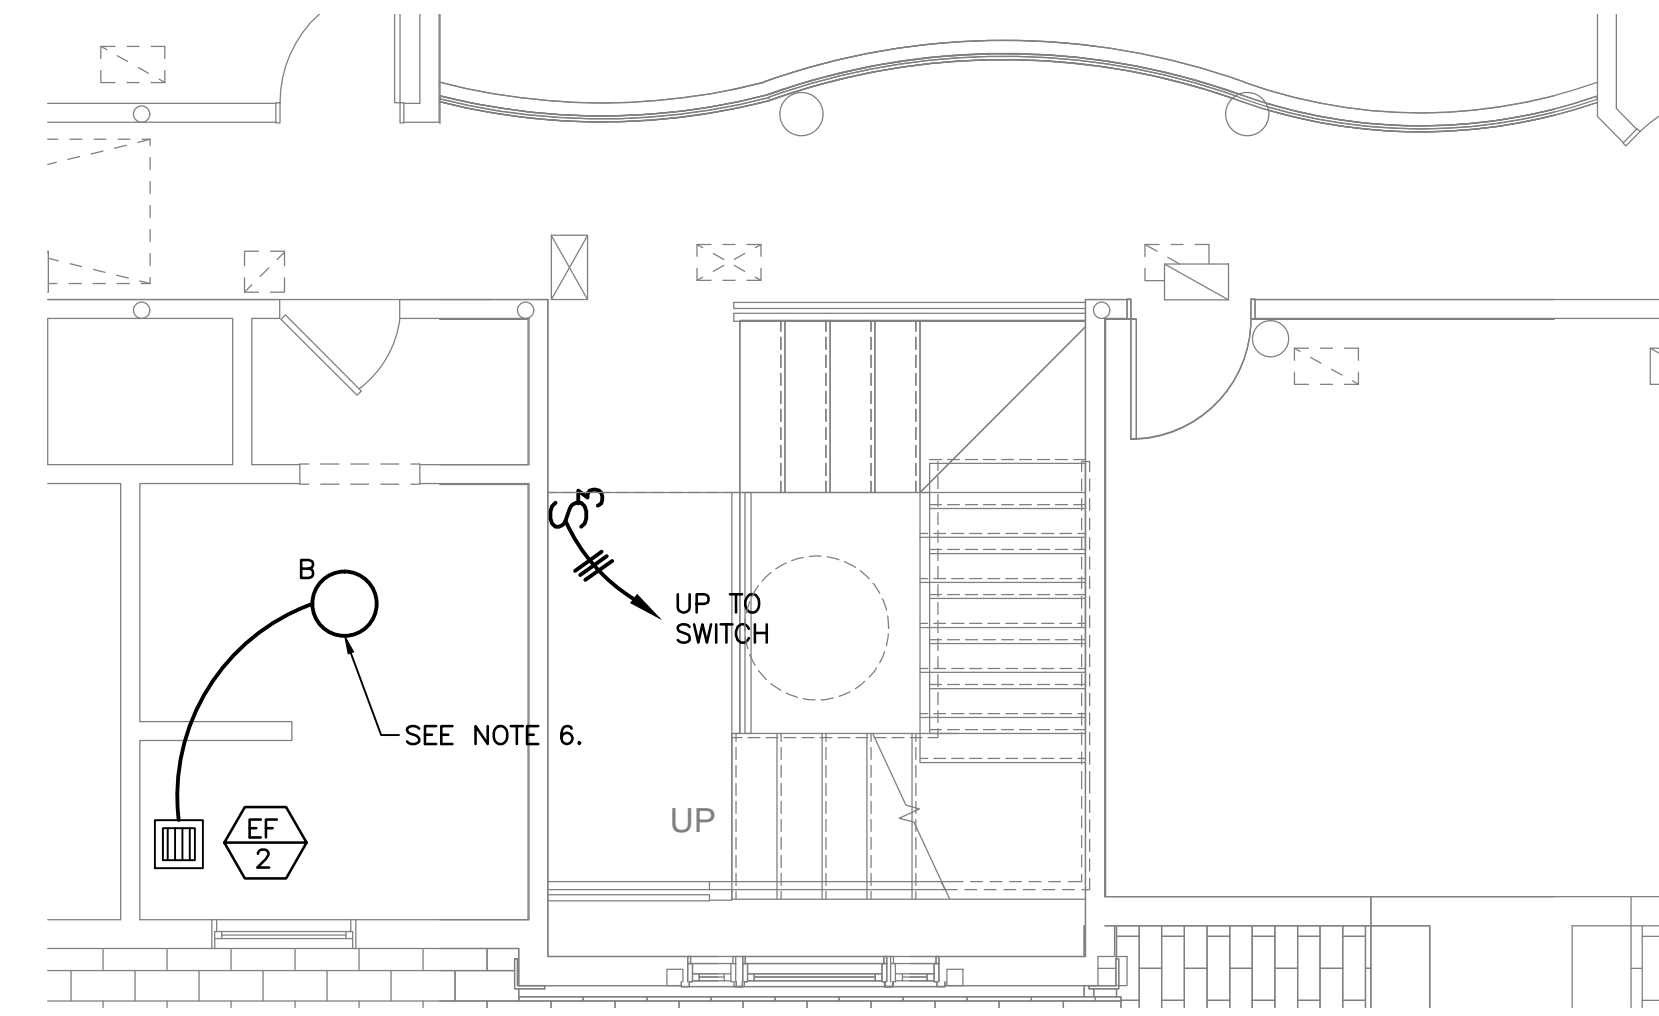


SECOND FLOOR PART PLAN
 SCALE: 1/4"=1'-0"

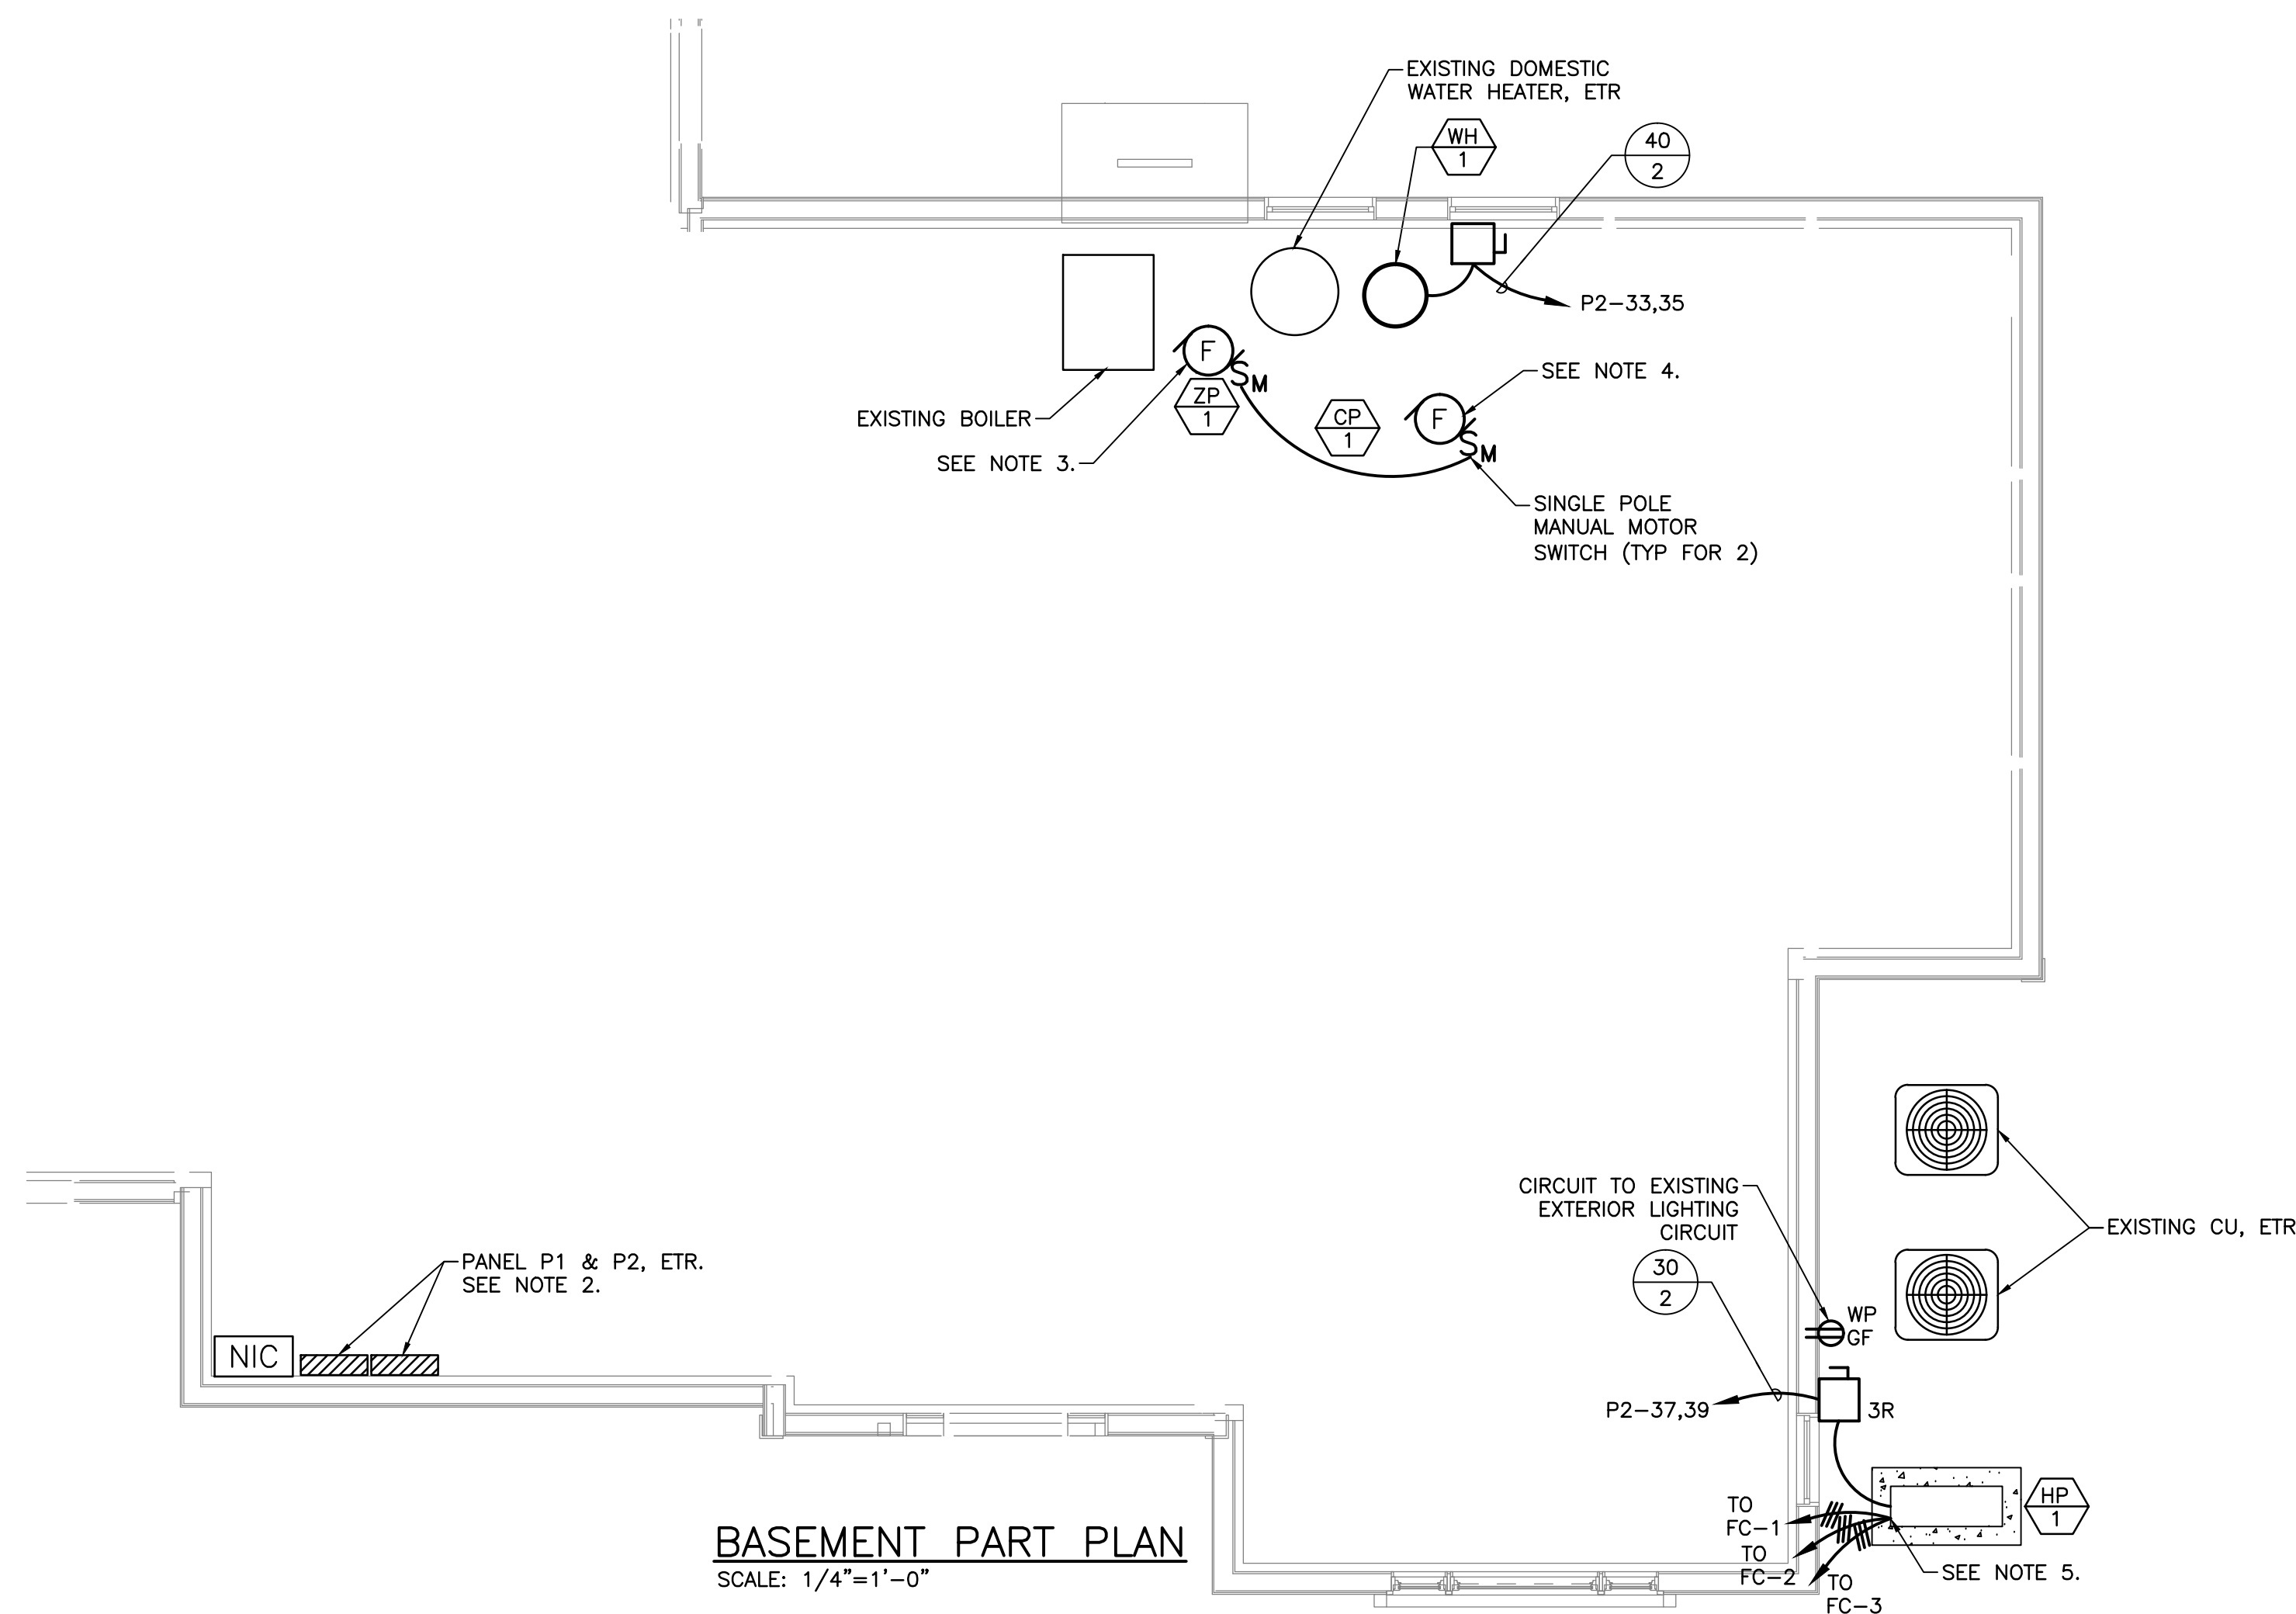

BASEMENT PART PLAN
 SCALE: 1/4"=1'-0"



NOTES:

- REFER TO DRAWING E-1 FOR LEGEND AND GENERAL NOTES.
- REARRANGE CIRCUIT BREAKERS TO PROVIDE 2 ADJACENT SPACES. PROVIDE (3)40A/2P CIRCUIT BREAKER IN SPACES IN LOADCENTER P1 & P2 TO SERVE NEW ATTIC LOADCENTER EA, WH-1 AND HP-1. NEW CIRCUIT BREAKERS SHALL BE LISTED COMPATIBLE WITH EXISTING SIEMENS LOADCENTERS.
- DISCONNECT AND MAKE SAFE EXISTING SECOND FLOOR ZONE PUMP TO BE REPLACED BY MC. CONNECT NEW ZONE PUMP ZP-1 TO EXISTING CIRCUIT.
- EXTEND EXISTING ZONE PUMP BRANCH CIRCUIT TO POWER NEW HOT WATER CIRCULATOR PUMP CP-1.
- WIRING FROM HP-1 TO FC-1, FC-2 & FC-3 SHALL BE MC CABLE FOLLOWING THE ROUTE OF THE PIPING BY MC. COORDINATE WORK WITH MC.
- DISCONNECT AND MAKE SAFE EXISTING BATH FAN TO BE REMOVED BY MC. RETAIN BRANCH CIRCUIT WIRING FOR REUSE. PROVIDE NEW JUNCTION BOX AND LIGHT AT LOCATION OF FORMER FAN. EXTEND EXISTING FAN WIRING TO NEW FAN. FAN AND LIGHT TO BE CONTROLLED BY EXISTING SWITCHING/CONTROLS.
- DISCONNECT AND MAKE SAFE EXISTING AHU IN ATTIC TO ALLOW RELOCATION BY MC. EXTEND BRANCH CIRCUIT WIRE AND CONDUIT TO NEW LOCATION AND RECONNECT UNIT VIA EXISTING SWITCH.

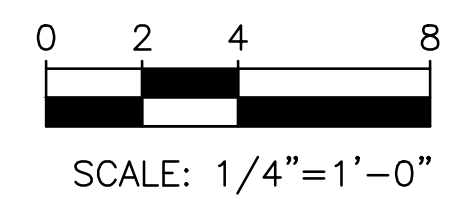

IF THIS SHEET IS NOT 24 X 36 IT IS A REDUCED SCALE PRINT - SCALE ACCORDINGLY



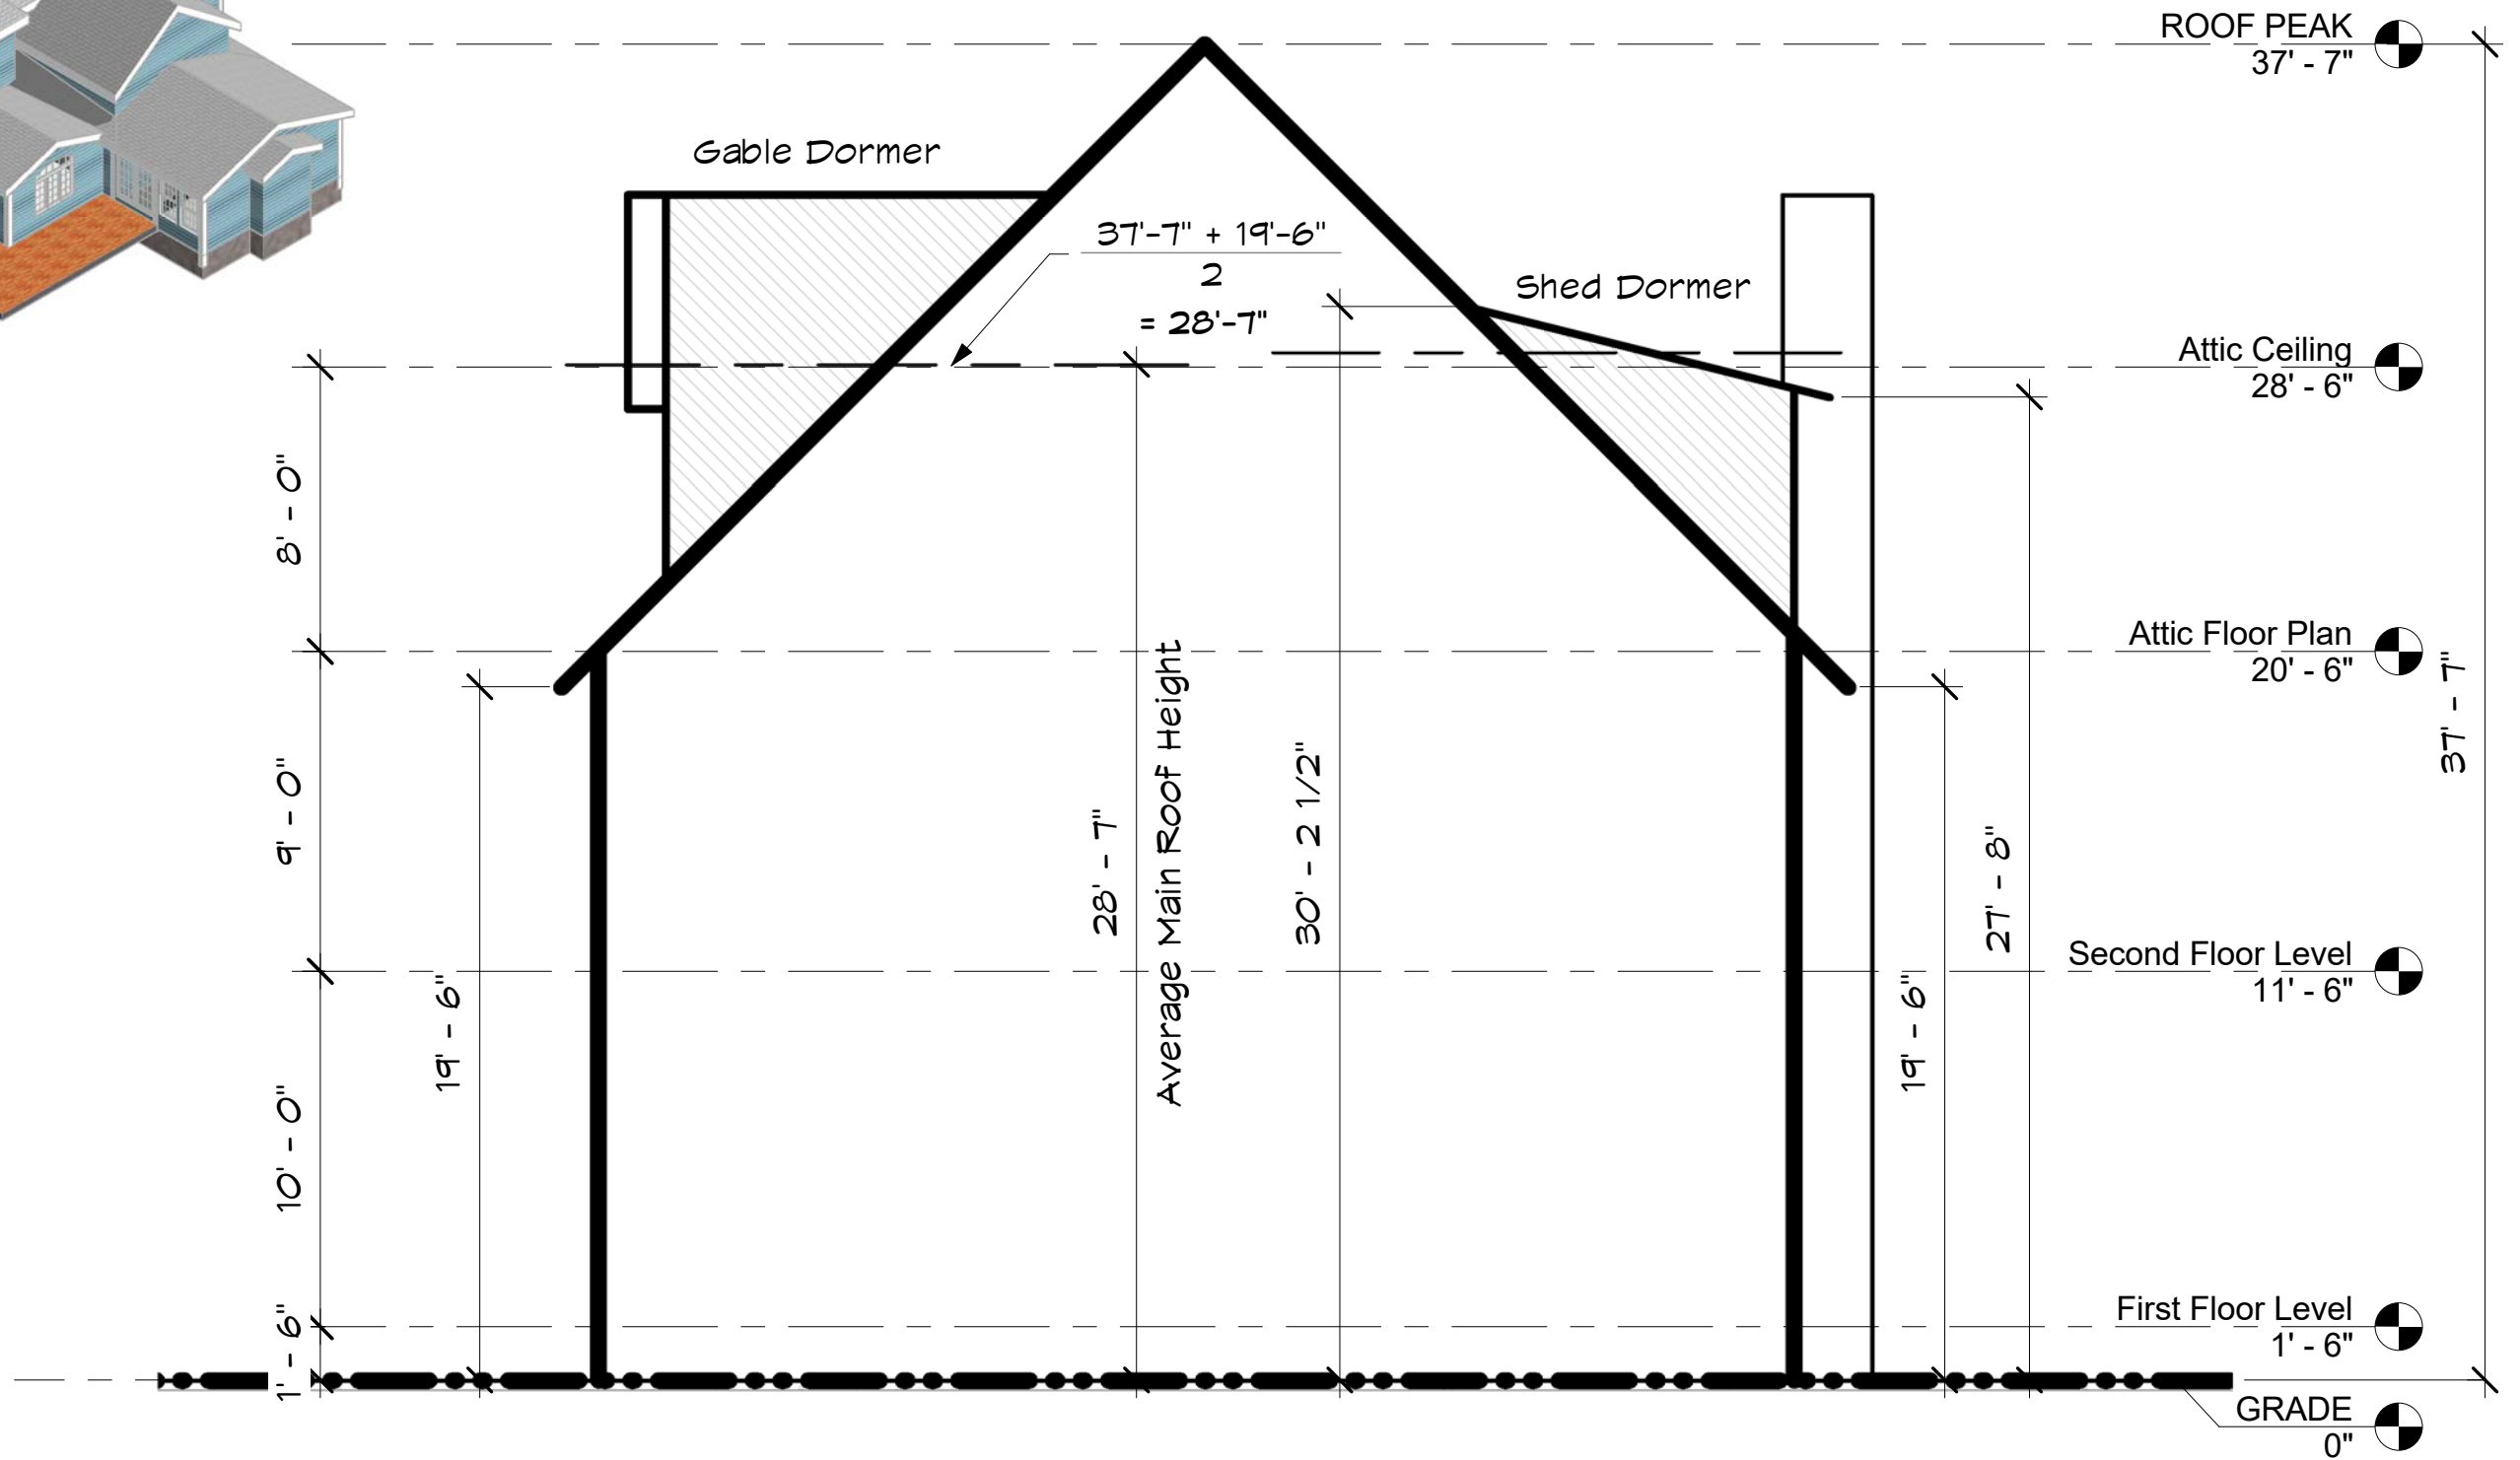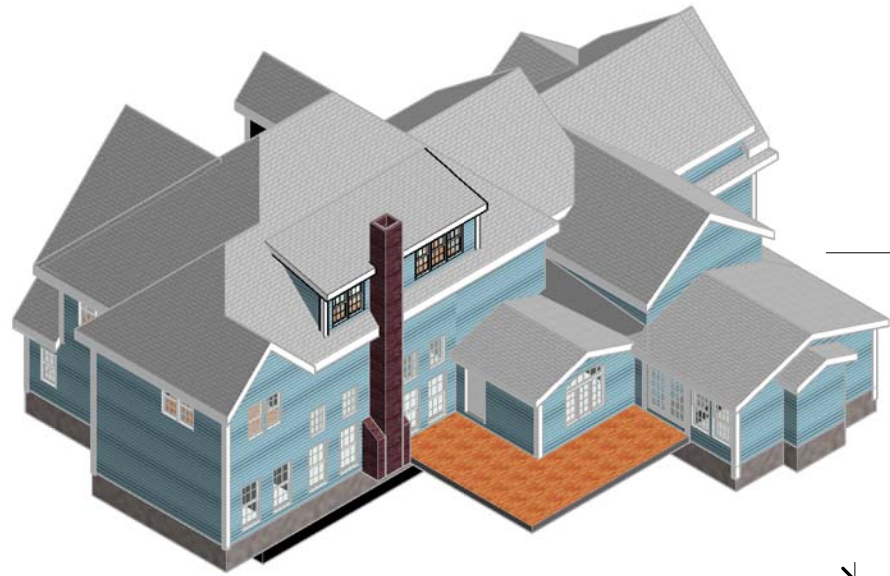

House Section

2 Section Through House
 3/16" = 1'-0"

10 Cardinal Drive, Westwood, MA