ISLINGTON VILLAGE SITE PLANS WASHINGTON, EAST AND SCHOOL STREETS WESTWOOD, MASSACHUSETTS


DECEMBER 12, 2017 REVISION 8 - 4/25/18

APPLICANT

PETRUZZIELLO PROPERTIES, LLC DEDHAM, MA 02026

CIVIL ENGINEER

GCG ASSOCIATES, INC. 84 MAIN STREET WILMINGTON, MA 01887

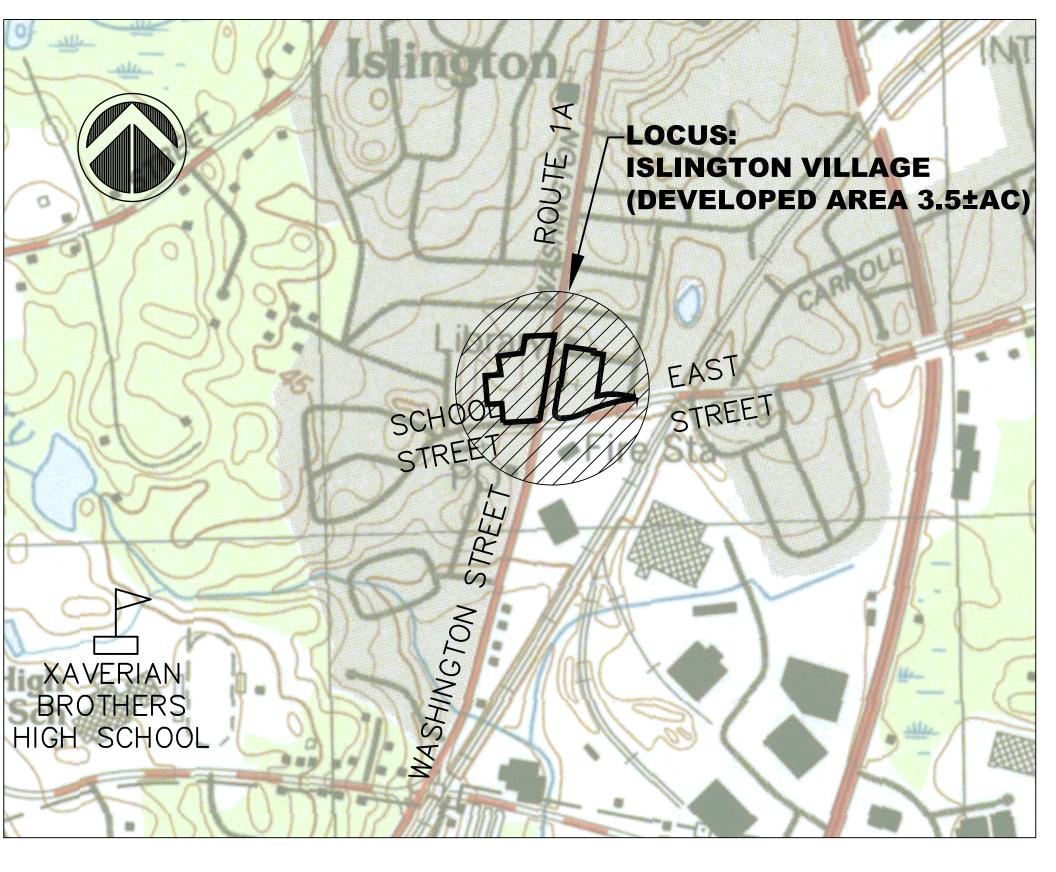

LOCUS PLAN SCALE : 1"=500'±



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GCG ASSOCIATES INC. CONSULTING ENGINEERS

WILMINGTON, MASSACHUSETTS

PHOTOMETRIC PLAN - EAST STREET SIDE

DECEMBER 12, 2017; REVISED: APRIL 25, 2018

GENERAL NOTES

- 1.) PLANS AND TOPOGRAPHIC INFORMATION ARE PREPARED FROM A GROUND SURVEY PERFORMED BY GCG ASSOCIATES, INC., OCTOBER & NOVEMBER 2017.
- 2.) ELEVATIONS REFER TO NAVD 88. LOCATIONS SHOWN REFERENCE MASSACHUSETTS STATE PLANE COORDINATE SYSTEM NAD MA83 MAINLAND.
- 3.) THE LOCUS PROPERTIES ARE NOT IN A FLOOD PLAIN AS SHOWN ON MAPS 25021C0177E AND 25021C0181E, EFFECTIVE DATE JULY 17, 2012.
- WETLAND DELINEATED BY WETLANDS & LAND MANAGEMENT INC. ON NOVEMBER 2, 2017. WETLAND FLAGS REVIEWED ANC CONFIRMED BY WESTWOOD CONSERVATION COMMISSION. KARON CATRONE ON MARCH 21, 2018. WETLAND FLAGS LOCATED BY GCG ASSOCIATES.
- 5.) BUILDING LOCATIONS AS SHOWN ON ADJACENT PROPERTIES, ARE APPROXIMATE AND FOR REFERENCE PURPOSES ONLY.
- CONSTRUCTION PERFORMED DURING THIS PROJECT SHALL CONFORM TO THE MASSACHUSETTS HIGHWAY DEPARTMENT, STANDARD SPECIFICATIONS FOR HIGHWAYS AND
- 7.) ALL LOCATIONS OF SUBSURFACE UTILITIES AND STRUCTURES WERE OBTAINED FROM AVAILABLE TOWN AND UTILITY RECORDS. THE SIZE, TYPE AND LOCATION OF UTILITIES SHOWN ARE APPROXIMATE. THE CONTRACTOR SHALL PROPERLY LOCATE THE UTILITIES PRIOR TO THE BEGINNING CONSTRUCTION. THE CONTRACTOR SHALL OBTAIN UTILITY INFORMATION BY CONTACTING DIG SAFE (811) A MINIMUM OF 72 HOURS PRIOR TO CONSTRUCTION.
- 8.) THE CONTRACTOR SHALL EXCAVATE TEST PITS TO VERIFY UTILITY LINE LOCATIONS AS
- 9.) THE CONTRACTOR SHALL COORDINATE HIS CONSTRUCTION ACTIVITIES NEAR UTILITY LOCATIONS WITH THE RESPECTIVE REPRESENTATIVE.
- 10.) THE CONTRACTOR SHALL BE HELD RESPONSIBLE FOR DISRUPTION ON EXISTING INDIVIDUAL UTILITY SERVICE CONNECTIONS, INCLUDING WATER, ELECTRICITY, TELEPHONE, GAS AND CABLE TELEVISION RESULTING FROM THE CONTRACTOR'S WORK.
- 11.) RELOCATION OF UTILITY POLES AND UNDERGROUND UTILITIES IS THE RESPONSIBILITY OF THE CUSTODIAN OF THE POLE. THE CONTRACTOR SHALL BE RESPONSIBLE FOR COORDINATION OF POLE RELOCATION.
- 12.) THE CONTRACTOR SHALL BE HELD RESPONSIBLE FOR DISRUPTION OF EXISTING INDIVIDUAL UTILITY SERVICE CONNECTIONS INCLUDING WATER, ELECTRICITY, TELEPHONE, GAS, AND CABLE TELEVISION RESULTING FROM THE CONTRACTORS WORK.
- 13.) WATER MAINS ARE ASSUMED TO BE 5 FEET BELOW THE EXISTING GROUND SURFACE. GAS LINES ARE ASSUMED TO BE 3 FEET BELOW THE EXISTING GROUND SURFACE. TELEPHONE LINES AND ELECTRIC CONDUIT ARE ASSUMED TO BE 2 FEET BELOW THE EXISTING GROUND SURFACE.
- 14.) THE CONTRACTOR SHALL BE RESPONSIBLE FOR LOCATING ALL UTILITIES ON SITE. THE CONTRACTOR SHALL BE RESPONSIBLE FOR HIRING AN INDEPENDENT UTILITY MARKING COMPANY TO LOCATE EXISTING UTILITIES ON SITE.
- 15.) EXISTING UTILITIES INTERFERING WITH THE WORK SHALL BE RELOCATED AS DIRECTED IN THE FIELD BY THE ENGINEER, UNLESS OTHERWISE INDICATED OR SPECIFIED.
- 16.) DAMAGE TO ANY UTILITY WILL BE REPAIRED BY THE CONTRACTOR, AT THE CONTRACTOR'S EXPENSE, IN A TIMELY MANNER SO THAT DISRUPTION OF SERVICE TO ANY UTILITY WILL NOT BE LONGER THAN PRACTICALLY NECESSARY TO REPAIR THE DAMAGE.
- 17.) THE CONTRACTOR SHALL BE RESPONSIBLE FOR OBTAINING ALL STATE OR LOCAL BUILDING PERMITS THAT MAY BE REQUIRED.
- 18.) THE CONTRACTOR SHALL PROVIDE THE OWNER WITH A CONSTRUCTION SCHEDULE DELINEATING THE SEQUENCE OF WORK, TRAFFIC MANAGEMENT PLAN AND ESTIMATED TIME OF COMPLETION OF EACH SEGMENT OF WORK, PRIOR TO THE COMMENCEMENT OF WORK.
- 19.) THE CONTRACTOR SHALL MAINTAIN CONTINUOUS TRAFFIC FLOW DURING CONSTRUCTION SATISFACTORY TO THE ENGINEER AND THE TOWN OF WESTWOOD.
- 20.) NO EQUIPMENT SHALL BE ALLOWED TO BE PARKED ON THE ROAD WHEN NOT IN USE. MATERIALS SHALL NOT BE STOCKPILED ON THE ROAD OR IN TOWN PARKING AREAS.
- 21.) ALL CONSTRUCTION SIGNAGE SHALL CONFORM TO THE REQUIREMENTS OF THE STATE OF MASSACHUSETTS DEPARTMENT OF TRANSPORTATION AND THE MANUAL ON UNIFORM TRAFFIC CONTROL DEVICES (MUTCD).
- 22.) SIDEWALKS, WALKS AND DRIVEWAYS THAT ARE DAMAGED OR REMOVED DURING CONSTRUCTION SHALL BE REPLACED WITH THE SAME TYPE OF MATERIAL ONCE THE WORK IS COMPLETED.
- 23.) THE CONTRACTOR SHALL BE RESPONSIBLE FOR PREVENTING ANY DEBRIS, SEDIMENT OR SILTY WATER FROM ENTERING ANY DRAINAGE SYSTEM, ETC. DURING ALL PHASES OF CONSTRUCTION. CONTROLS MAY INCLUDE COMPOST WATTLES, STRAW BALES, SILT FENCE,
- SILT SACKS, CRUSHED STONE.
- 24.) ALL CONSTRUCTION MATERIAL, DEBRIS, ASPHALT, SOIL, ETC. THAT IS REMOVED FROM THE SITE SHALL BE HANDLED AND DISPOSED OF IN ACCORDANCE WITH LOCAL, STATE, AND FEDERAL REGULATIONS.
- 25.) DURING CONSTRUCTION THE CONTRACTOR SHALL PROTECT ALL TREES AND ROOTS OF TREES TO REMAIN.
- 26.) DURING THE COURSE OF CONSTRUCTION, ANY DAMAGE TO FENCES, GUARD RAILS, PATHS, STAIRS, AND VEGETATION SHALL BE REPAIRED OR REPLACED AND RESTORED TO THE ORIGINAL CONDITION AT NO ADDITIONAL EXPENSE TO THE OWNER.
- 27.) ALL CASTINGS, GATE BOXES, HYDRANTS, LIGHT POLES, ETC. DAMAGED DURING RECONSTRUCTION SHALL BE SUPPLIED AND REPLACED BY THE CONTRACTOR AT NO ADDITIONAL COST TO THE CONTRACT.
- 28.) THE CONTRACTOR SHALL BE SOLELY RESPONSIBLE FOR CONSTRUCTION MEANS, METHODS, TECHNIQUES AND PROCEDURES, AND FOR SAFETY PRECAUTIONS AND PROGRAMS IN CONNECTION WITH ALL WORK INCLUDED UNDER THIS CONTRACT. THE DRAWINGS DO NOT INCLUDE NECESSARY COMPONENTS FOR CONSTRUCTION SAFETY. THE CONTRACTOR SHALL BE SOLELY RESPONSIBLE FOR PROVIDING AND MAINTAINING ALL SAFETY BARRIERS, WARNING FLASHERS AND THE LIKE, AS REQUIRED BY THE CONDUCT OF THE WORK FOR THE PROTECTION OF WORKERS AND NON-WORKERS ALIKE. THE CONTRACTORS ATTENTION IS DIRECTED TO OSHA REQUIREMENTS.
- 29.) THE CONTRACTOR SHALL BE RESPONSIBLE FOR SITE RESTORATION AND CLEAN UP UPON COMPLETION OF THE PROJECT.

UTILITY MARKING AND LOCATION NOTES:

- 1.) THE CONTRACTOR SHALL BE RESPONSIBLE FOR LOCATING ALL UTILITIES ON SITE. THE CONTRACTOR SHALL HIRE A PRIVATE MARKING COMPANY TO LOCATE ONSITE UTILITIES. THE COST TO HIRE THE PRIVATE MARKING COMPANY SHALL BE INCLUDED IN THE CONTRACT PRICE.
- 2.) BEFORE CONSTRUCTION CONSTRUCTION, ALL UTILITIES, PUBLIC AND PRIVATE MUST BE NOTIFIED (SEE MASSACHUSETTS GENERAL LAWS, CHAPTER 82 SECTION 40.) CALL "DIG SAFE" - 811, OR CUSTOMER SERVICE - 1 (888) 344-7233 HTTP://WWW.DIGSAFE.COM
- 3.) UTILITY REFERENCES INCLUDE:

EVERSOURCE ELECTRIC/TELEPHONE/CABLE/FIRE ALARM: EVERSOURCE/COMCAST/VERIZON

TOWN OF WESTWOOD

TOWN OF WESTWOOD

WATER: DEDHAM WESTWOOD WATER

SUBSURFACE UTILITY LINES, AS SHOWN HEREON, WERE COMPILED ACCORDING TO AVAILABLE RECORD INFORMATION FROM THE REFERENCED UTILITY COMPANIES, THE TOWN OF WESTWOOD. THE LOCATIONS ARE APPROXIMATE ONLY.

- 4.) THE CONTRACTOR SHALL ACCURATELY LOCATE THE EXISTING WATER. SEWER. AND ANY ELECTRIC SERVICE PIPES CONNECTED TO EACH BUILDING THAT HAVE NOT PREVIOUSLY BEEN MARKED OUT WITHIN THE LIMITS OF WORK PRIOR TO CONSTRUCTION. THIS WORK SHALL BE INCLUDED IN THE CONTRACT.
- 5.) THE CONTRACTOR SHALL EXCAVATE TEST PITS TO VERIFY UTILITY LINE LOCATIONS AS NECESSARY OR AS DIRECTED BY THE ENGINEER. THE CONTRACTOR SHALL PLAN AND PERFORM TEST PIT EXCAVATION WELL IN ADVANCE OF COMMENCING CONSTRUCTION IN THE GENERAL AREA TO ALLOW TIME TO REVIEW ACTUAL CONDITIONS ENCOUNTERED. THIS WORK SHALL BE INCLUDED IN THE LUMP SUM CONTRACT PRICE.
- 6.) WATER MAINS ARE ASSUMED TO BE 5 FEET BELOW THE EXISTING GROUND SURFACE. GAS LINES ARE ASSUMED TO BE 3 FEET BELOW THE EXISTING GROUND SURFACE. TELEPHONE LINES AND ELECTRIC CONDUIT ARE ASSUMED TO BE 2 FEET BELOW THE EXISTING GROUND SURFACE.
- 8.) EXISTING UTILITIES INTERFERING WITH THE WORK SHALL BE RELOCATED AS DIRECTED IN THE FIELD BY THE ENGINEER, UNLESS OTHERWISE INDICATED OR SPECIFIED.
- DAMAGE TO ANY UTILITY WILL BE REPAIRED BY THE CONTRACTOR. AT THE CONTRACTOR'S EXPENSE. IN A TIMELY MANNER SO THAT DISRUPTION OF SERVICE TO ANY UTILITY WILL NOT BE LONGER THAN PRACTICALLY NECESSARY TO REPAIR THE DAMAGE.

SIDEWALK CONSTRUCTION NOTES:

- 1.) RECONSTRUCTION OF SIDEWALKS SHALL BE IN ACCORDANCE WITH THE TYPICAL CROSS SECTION DETAILS.
- 2.) HMA PAVEMENT SIDEWALKS SHALL HAVE A MINIMUM 3" DEPTH CONSISTING OF A 1-1/2" BINDER COURSE AND A 1-1/2" SURFACE COURSE.
- 3.) CEMENT CONCRETE RAMPS SHALL BE A OF MINIMUM 4" DEEP. CEMENT CONCRETE RAMPS AND DRIVEWAY APRONS SHALL BE A MINIMUM OF 6" DEEP.
- 4.) CEMENT CONCRETE SIDEWALK SHALL BE A BROOM FINISH WITH 2" BORDER TO MATCH
- THE CONTRACTOR SHALL COMPACT AND FINE GRADE GRAVEL SUBBASE AS SPECIFIED. ALL SUBBASE MATERIAL SHALL BE COMPACTED TO A MINIMUM 95% OF THE STANDARD
- 6.) THE CONTRACTOR SHALL FINE GRADE THE GRAVEL SUBBASE NO MORE THAN 24 HOURS PRIOR TO THE PLACEMENT OF THE BASE COURSE PAVEMENT. ALL GRADING, COMPACTION AND DUST CONTROL ASSOCIATED WITH THE SUBBASE SHALL BE INCLUDED
- 7.) SIDEWALKS ADJACENT TO BUILDING ENTRANCES SHALL BE REGRADED TO DIRECT RUNOFF AWAY FROM BUILDING.
- 8.) THE COSTS ASSOCIATED WITH THE EXCAVATION AND DISPOSAL OF ADDITIONAL MATERIALS AND SOIL SURPLUS SHALL BE INCLUDED IN THE CONTRACT PRICE. EXCAVATED MATERIALS SHALL BE REMOVED AND DISPOSED OF IN ACCORDANCE WITH LOCAL, STATE, AND FEDERAL REGULATIONS.
- 9.) ANY STRUCTURES OR GATE BOXES IN SIDEWALKS SHALL BE RESET TO FINISHED GRADE AS PART OF THE CONTRACT.
- 10.) WHEN SIDEWALKS MEET ROADWAY OR PARKING PAVEMENT, 12" OF GRAVEL SHALL BE INSTALLED UNDER THE SIDEWALK 3 FEET LATERAL DISTANCE FROM THE EDGE OF ROADWAY.

GENERAL PAVING NOTES:

EXISTING.

PROCTOR DENSITY.

IN THE CONTRACT PRICE.

- 1.) THE CONTRACTOR SHALL SAW CUT ALL JOINTS IN THE EXISTING PAVEMENT AREAS WHERE THE PROPOSED PAVEMENT WILL MEET EXISTING PAVEMENT TO REMAIN. ALL JOINTS SHALL PROVIDE A SMOOTH TRANSITION BETWEEN NEW AND OLD PAVEMENTS, IMMEDIATELY AFTER PAVING, ALL NEW JOINTS SHALL BE SANDED AND SEALED.
- 2.) THE CONTRACTOR SHALL RESET ALL WATER, SEWER, GAS, ELECTRIC, TELEPHONE AND DRAINAGE FRAMES AND GRATES AND ANY OTHER STRUCTURES, SIGNS, ETC. NECESSARY TO INSTALL THE PROPOSED PAVEMENT TO THE PROPOSED FINISH GRADE ELEVATION. THIS WORK SHALL BE INCLUDED IN THE CONTRACT.
- 4.) THE CONTRACTOR SHALL PERFORM WORK REQUIRED TO SUPPORT OR REMOVE AND REPLACE EXISTING STRUCTURES AND UTILITY LINES ADJACENT TO OR WITHIN THE LIMITS OF WORK UNDER THE CONTRACT.
- 5.) ALL CASTINGS, GATE BOXES, ETC. DAMAGED DURING RECONSTRUCTION SHALL BE SUPPLIED AND REPLACED BY THE CONTRACTOR AT NO ADDITIONAL COST TO THE CONTRACT.
- 6.) THE CONTRACTOR SHALL BE RESPONSIBLE FOR TEMPORARY RELOCATION OF DUMPSTERS AS NECESSARY TO COMPLETE THE PROPOSED WORK.
- 7.) THE CONTRACTOR SHALL MAINTAIN CONTINUOUS TRAFFIC FLOW DURING CONSTRUCTION AND SHALL MAINTAIN ACCESS TO ALL RESIDENTIAL DRIVEWAYS AND ACCESS WAYS SATISFACTORY TO THE ENGINEER, THE OWNER AND THE TOWN OF WESTWOOD. NO EQUIPMENT SHALL BE ALLOWED TO BE PARKED ON THE DRIVEWAY WHEN NOT IN USE. MATERIALS SHALL NOT BE STOCKPILED ON THE DRIVEWAY.
- 8.) ALL NEW PAVEMENT STRIPING SHALL BE 4" WIDE PAINTED LINES TO MATCH EXISTING COLOR ON SITE.

DRIVEWAY AND PARKING AREA RECONSTRUCTION NOTES

- 1.) CONTRACTOR SHALL REMOVE & REPLACE EXISTING PAVEMENT AND GRAVEL SUBBASE AS NECESSARY AND SHALL PROVIDE A 12" MINIMUM DEPTH OF COMPACTED GRAVEL SUBBASE AND A 3-1/2" MINIMUM DEPTH OF HMA PAVEMENT.
- 2.) THE 3-1/2" MINIMUM DEPTH OF HMA SHALL CONSIST OF A 2" BINDER COURSE AND A 1-1/2" SURFACE COURSE AS SHOWN ON THE TYPICAL DETAIL AND SHALL CONFORM TO THE MASS DOT STANDARD SPECIFICATIONS.
- 3.) THE BASE COURSE MATERIAL SHALL CONSIST OF EITHER A MINIMUM OF 12" GRAVEL BORROW M1.03.0 TYPE "B" OR RECLAIMED PAVEMENT BORROW M1,09.0 OR A COMBINATION OF 4" OF DENSE-GRADED CRUSHED STONE M2.01.7 UNDERLAIN BY EITHER 8" OF GRAVEL BORROW M1.03.0 TYPE "B" OR RECLAIMED PAVEMENT BORROW M1.09.0.
- 4.) THE CONTRACTOR SHALL COMPACT AND FINE GRADE GRAVEL SUBBASE AS SPECIFIED. ALL SUBBASE MATERIAL SHALL BE COMPACTED TO A MINIMUM 95% OF THE STANDARD PROCTOR DENSITY.
- 5.) IN AREAS WHERE PAVEMENT EXPANSION IS PROPOSED, THE EXISTING SOILS SHALL BE EXCAVATED TO THE REQUIRED SUBGRADE DEPTH THEN BACKFILLED AND COMPACTED WITH A SUITABLE 12" THICK SUBBASE LAYER.
- 6.) THE CONTRACTOR SHALL FINE GRADE THE GRAVEL SUBBASE NO MORE THAN 24 HOURS PRIOR TO THE PLACEMENT OF THE BASE COURSE PAVEMENT
- 7.) A TACK COAT CONSISTING OF ASPHALT EMULSION TYPE "RS-1" SHALL BE APPLIED OVER THE BINDER COURSE AT UNIFORM RATE OF 0.05 GALLONS PER SQUARE YARD IMMEDIATELY PRIOR TO INSTALLATION OF THE SURFACE COURSE.
- 8.) SHOULDERS OF DRIVEWAY AND PARKING AREAS SHALL BE GRADED FOR A SMOOTH TRANSITION FROM THE PROPOSED EDGE OF PAVEMENT/ CURB TO THE EXISTING GRADE.
- 9.) CROSS SLOPES AT CATCH BASINS SHALL BE ADJUSTED AS NECESSARY TO ASSURE
- 10.) DRAINAGE STRUCTURES SHALL BE ADJUSTED OR REMODELED AS REQUIRED TO MEET
- 12.) EXCAVATED MATERIALS SHALL BE REMOVED AND DISPOSED OF IN ACCORDANCE WITH LOCAL, STATE, AND FEDERAL REGULATIONS.
- 13.) THE CONTRACTOR SHALL RESTORE ALL DISTURBED AREAS.

THE CONTRACTOR SHALL CONTROL DUST DURING CONSTRUCTION.

FINE GRADING AND COMPACTING:

PROPER DRAINAGE.

- 1.) THE CONTRACTOR SHALL FINE GRADE AND COMPACT ALL AREAS IN PREPARATION FOR PAVEMENT, INCLUDING, BUT NOT LIMITED TO THE DRIVEWAY AREAS AND TRANSITION DRIVEWAY AREAS. THE CONTRACTOR SHALL ALSO STRAIGHT CUT ALL EXISTING JOINTS AND EDGES IN PREPARATION FOR FINAL PAVEMENT.
- 2.) PAYMENT FOR GRADING AND COMPACTING THE RECONSTRUCTED SIDEWALK SHALL BE INCLUDED IN THE CONTRACT.
- 3.) PAYMENT FOR FINE GRADING AND COMPACTING THE RECONSTRUCTED DRIVEWAY AND PARKING AREAS SHALL BE INCLUDED IN THE CONTRACT.
- 4.) COMPACTION TESTING SHALL BE PERFORMED UNDER DIRECTION OF THE ENGINEER, TESTING COSTS SHALL BE INCLUDED IN THE CONTRACT.

SITE EROSION & SEDIMENT CONTROL NOTES

- 1. THE CONTRACTOR SHALL COMPLY WITH EROSION AND SEDIMENTATION CONTROL DETAILS AND NOTES AS SHOWN ON DETAIL SHEETS.
- 2. COMPOST SOCK EROSION AND SEDIMENT CONTROL BARRIER SHALL BE PLACED AT DOWNSTREAM PROJECT LIMITS PRIOR TO THE COMMENCEMENT OF WORK. WATTLES SHALL BE INSPECTED DAILY AND CLEANED OR REPAIRED AS NEEDED DURING CONSTRUCTION PERIOD.
- 3. CONSTRUCTION PERIOD SILT SACKS SHALL BE USED AT ALL CATCH BASINS. SILT SACKS SHALL

BE KEPT FREE OF SEDIMENT AND DEBRIS, INSPECTED WEEKLY AND REPAIRED PROMPTLY.

TREE REMOVAL AND TRIMMING NOTES:

- 1. THE CONTRACTOR SHALL REMOVE TREES AND STUMPS AS IDENTIFIED ON PLANS AND SHALL NOT REMOVE ANY TREES UNTIL APPROVED BY THE ENGINEER.
- ROOTS ON TREES WHICH ARE IMPACTING THE SAFETY OF THE SITE OR AFFECTING WALKWAYS SHALL BE REMOVED BY THE CONTRACTOR. WHEN THE ARBORIST DETERMINES THAT THE NUMBER OF ROOTS REMOVED MAY IMPACT THE LIFE OF THE TREE, THE TREE AND STUMP SHALL BE REMOVED.
- 3. THE CONTRACTOR SHALL REMOVE OVERGROWN VEGETATION ALONG SITE PERIMETER AS NEEDED.
- 4. CLEARING AND GRUBBING WITHIN AREAS IDENTIFIED SHALL INCLUDE TRIMMING OF TREES SO THAT LIMBS SHALL NOT EXTEND OVER ANY BUILDING ROOF AND WITHIN 10' OF ANY UTILITY WIRE. TREE LIMBS SHALL ALSO BE TRIMMED WHEN EXTENDING BELOW A HEIGHT OF 10' FROM GROUND LEVEL.
- 5. ALL DISTURBED AREAS SHALL BE LOAMED AND SEEDED.

EXISTING LEGEND


TEMPORARY BENCH MARK MAG/PK
TEMPORARY BENCH MARK MAG/PK
DRILL HOLE
BOUND
IRON PIN OR IRON ROD
APPROX. HOUSE LOCATION
EXISTING BUSH/SHRUB
EXISTING TREE W/TRUNK DIA.
EXISTING CATCH BASIN
EXISTING DRAIN MANHOLE
EXISTING SEWER MANHOLE
EXISTING UNMARKED MANHOLE
EXISTING DIMMARKED MARTICLE EXISTING HYDRANT
EXISTING WATER GATE VALVE
EXISTING WATER SHUT OFF
EXISTING WATER SHOT OFF EXISTING GAS GATE VALVE
EXISTING GAS GATE VALVE EXISTING LIGHT POST
EXISTING UTILITY POLE
EXISTING GUY WIRE ANCHOR
EXISTING SIGN
EXISTING TRAFFIC POLE
EXISTING TRANSFORMER
EXISTING BOLLARD
EXISTING GAS LINE
EXISTING DRAIN LINE
EXISTING WATER LINE
EXISTING SEWER LINE
EXISTING ELECTRIC LINE
EXISTING OVERHEAD WIRE
EXISTING 5' CONTOURS
EXISTING 1' CONTOURS
EXISTING SPOT GRADE
EXISTING EDGE OF PAVEMENT
EXISTING CURBING
EXISTING FENCE —CHAIN LINK
EXISTING FENCE -WOOD OR VINYL
EXISTING GUARD RAIL
EXISTING VEGETATION LINE
EXISTING WETLANDS
EXISTING WALL/ RETAINING WALL
APPROX. PROPERTY LINE
APPROX. RIGHT-OF-WAY LINE
APPROX. EASEMENT LINE
PDEVIATIONS

<u>ABBREV</u>	<u>'IATIONS</u>
APPROX	APPROXIMATE
BC	BOTTOM OF CURB
	BUILDING
BIT	BITUMINOUS
CB	CATCH BASIN
	CONCRETE
CPP	CORRUGATED PLASTIC PIPE
D	DRAIN
DRV	DRIVEWAY
DMH	DRAIN MANHOLE
	ELECTRIC
EOP	EDGE OF PAVEMENT
ESHGW	ESTIMATED SEASONAL HIGH GROUND WATER
EXIST	EXISTING
HYD	HYDRANT
INV	INVERT
MH	MANHOLE
N/F	NOW OR FORMERLY
OHW	OVERHEAD WIRE
PROP	PROPOSED
PVC	POLYVINYL CHLORIDE
RCP	REINFORCED CONCRETE PIPE
S	SEWER
SMH	SEWER MANHOLE
TC	TOP OF CURB
	TYPICAL
UP	UTILITY POLE

NOTES & LEGEND

ISLINGTON VILLAGE WESTWOOD MA NORFOLK COUNTY

VERTICAL GRANITE CURB

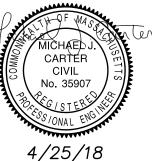

GCG ASSOCIATES, INC.

WILMINGTON

MASSACHUSETTS

SCALE: N.T.S. DATE: DECEMBER 12, 2017 JOB NO. FILE NAME: DESIGNED BY: S.B.H. PLAN NO. DRAWN BY: S.B.H. 1753-COVER_DETAILS CHECKED BY: M.J.C. | C-2 of 20

8 4/25/18 PLANNING/ BETA/ CONS. COMM. S.B.H 7 4/6/18 PLANNING/ BETA/ CONS. COMM. S.B.H. 6 3/30/18 PLANNING/ BETA/ CONS. COMM. S.B.H. 5 3/8/18 PLANNING/ BETA COMMENTS S.B.H. 4 3/6/18 PLANNING/ BETA COMMENTS S.B.H. 3 2/7/18 PLANNING/ BETA COMMENTS S.B.H 2 2/1/18 PLANNING/ BETA COMMENTS S.B.F


S.B.H.

CONSERVATION - NOI

DESCRIPTION

1 1/2/18

NO. DATE

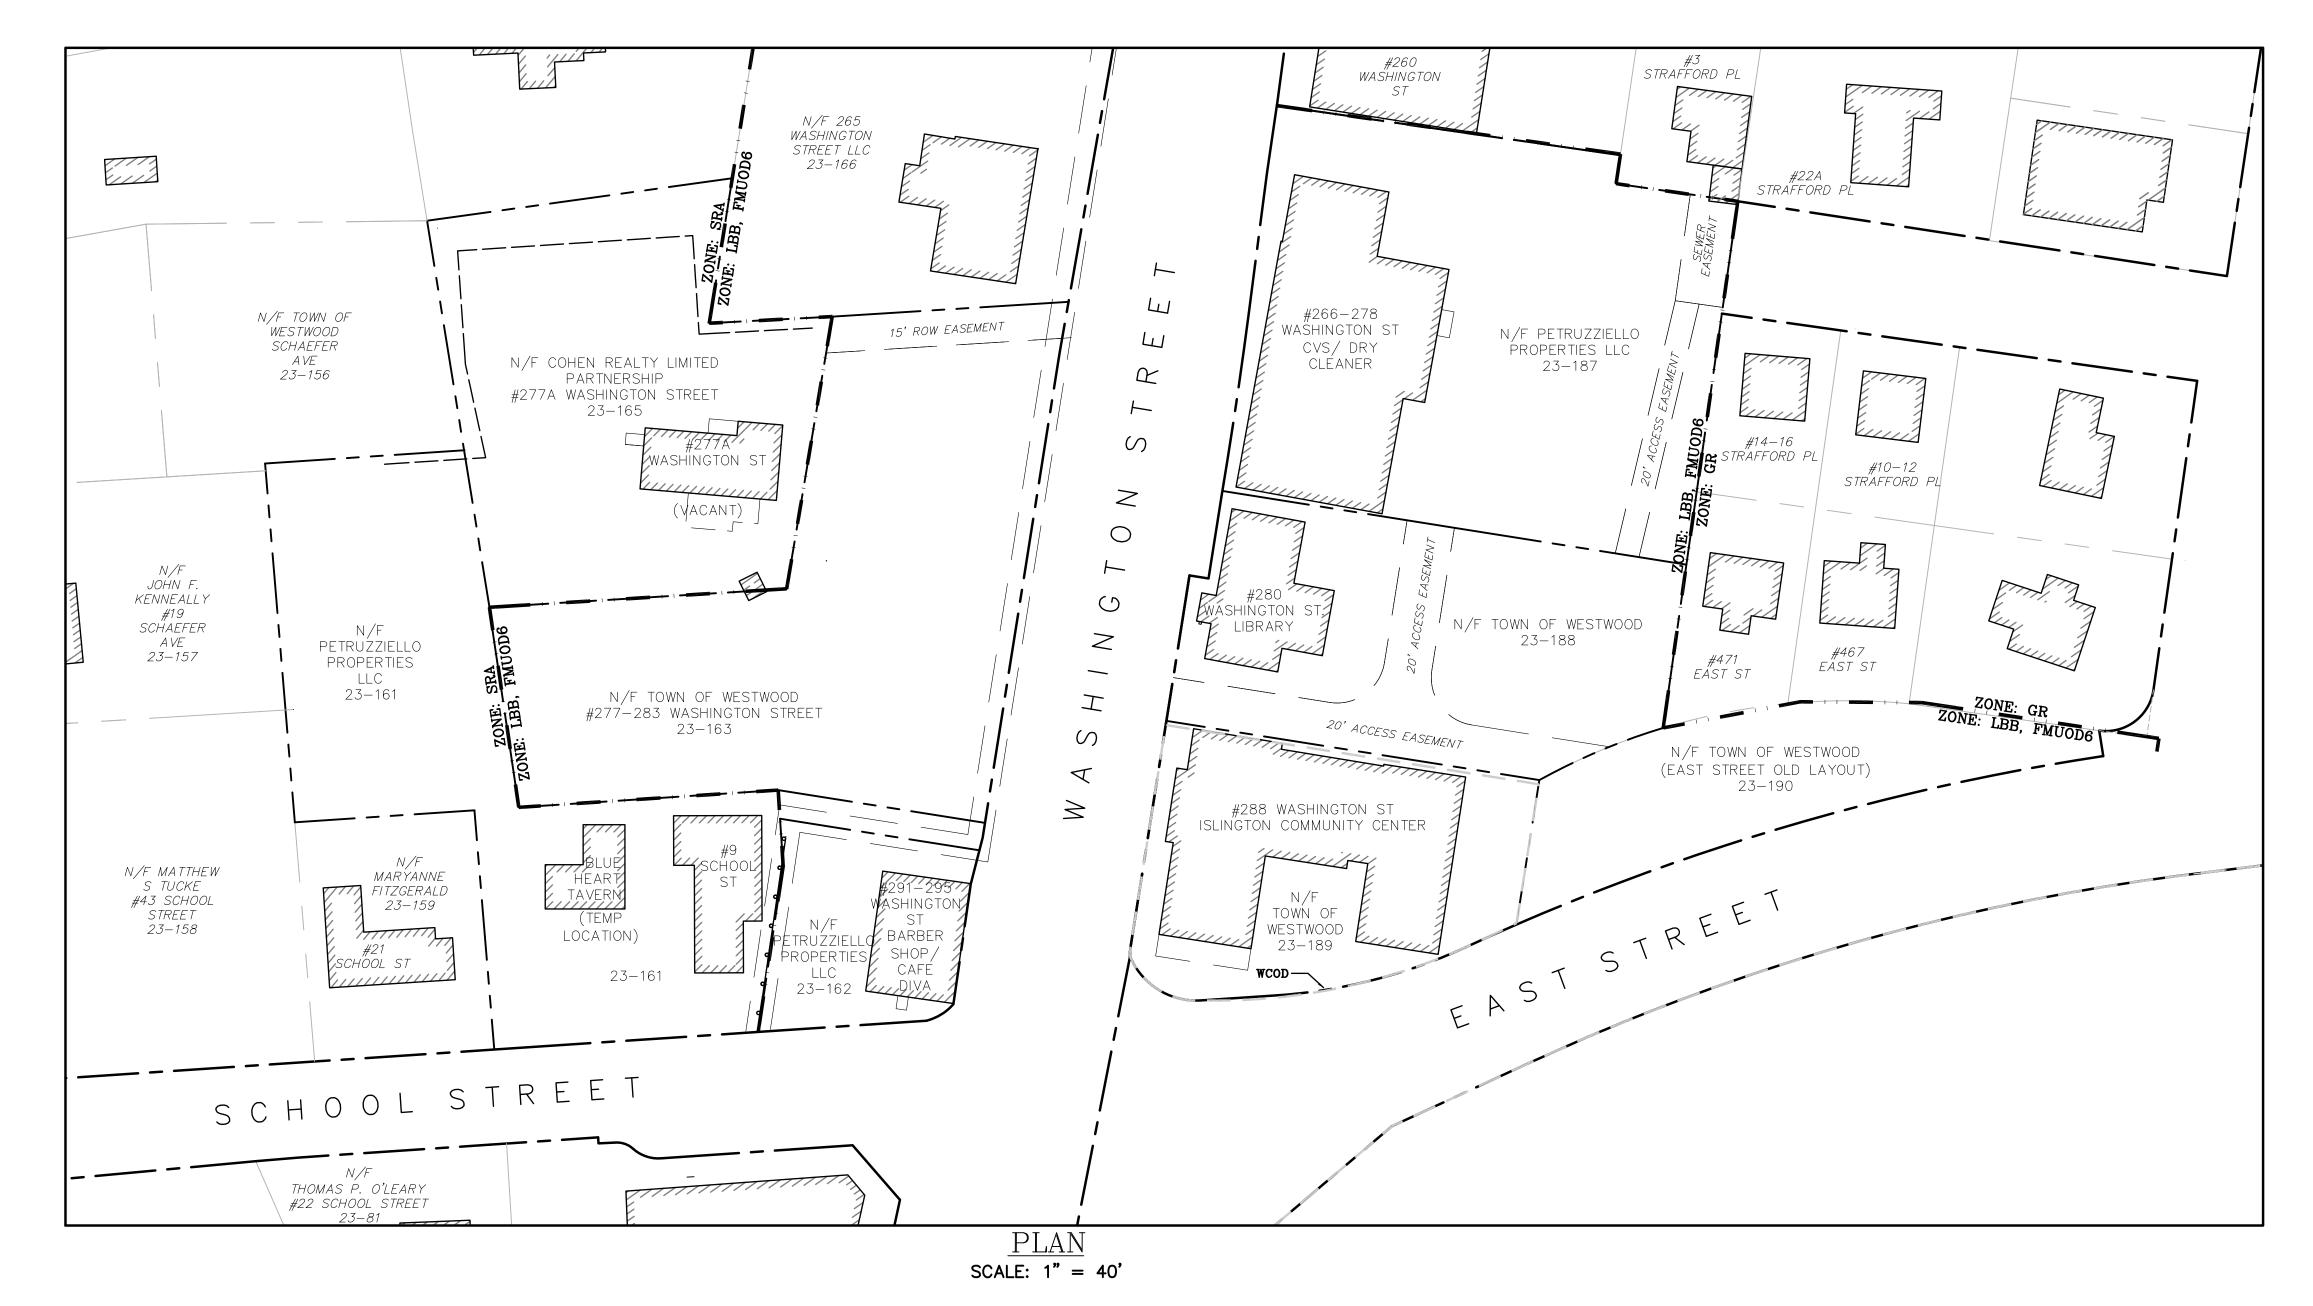



MAP 23, LOT 161 - PETRUZZIELLO PROPERTIES

MAP 23, LOT 162 - PETRUZZIELLO PROPERTIES

MAP 23, LOT 163 - TOWN OF WESTWOOD

MAP 23, LOT 165 - COHEN REALTY TRUST (UNDER P&S W/PETRUZZIELLO)

EAST STREET SIDE ASSESSOR'S DESIGNATIONS: MAP 23, LOT 187 — PETRUZZIELLO PROPERTIES

MAP 23, LOT 188 - TOWN OF WESTWOOD

MAP 23, LOT 189 - TOWN OF WESTWOOD

MAP 23, LOT 190 - TOWN OF WESTWOOD

ZONING KEY:

-LOCAL BUSINESS B


FMUOD6 -FLEXIBLE MULTIPLE USE OVERLAY DISTRICT, WASHINGTON STREET BUSINESS DISTRICT

-WIRELESS COMMUNICATIONS OVERLAY DISTRICT

-SINGLE RESIDENCE A -GENERAL RESIDENCE DISTRICT

8		PLANNING/ BETA/ CONS. COMM.	S.B.H.	٨
7	4/6/18	PLANNING/ BETA/ CONS. COMM.	S.B.H.	1
6	3/30/18	PLANNING/ BETA/ CONS. COMM.	S.B.H.	
5	3/8/18	PLANNING/ BETA COMMENTS	S.B.H.	
4	3/6/18	PLANNING/ BETA COMMENTS	S.B.H.	
3	2/7/18	PLANNING/ BETA COMMENTS	S.B.H.	
2	2/1/18	PLANNING/ BETA COMMENTS	S.B.H.	
1	1/2/18	CONSERVATION - NOI	S.B.H.	
NO.	DATE	DESCRIPTION	BY	

MICHAEL J. CARTER CIVIL No. 35907

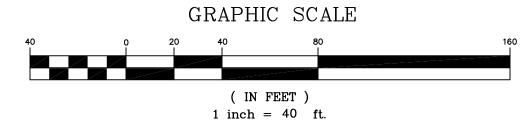



PROPERTY KEY PLAN


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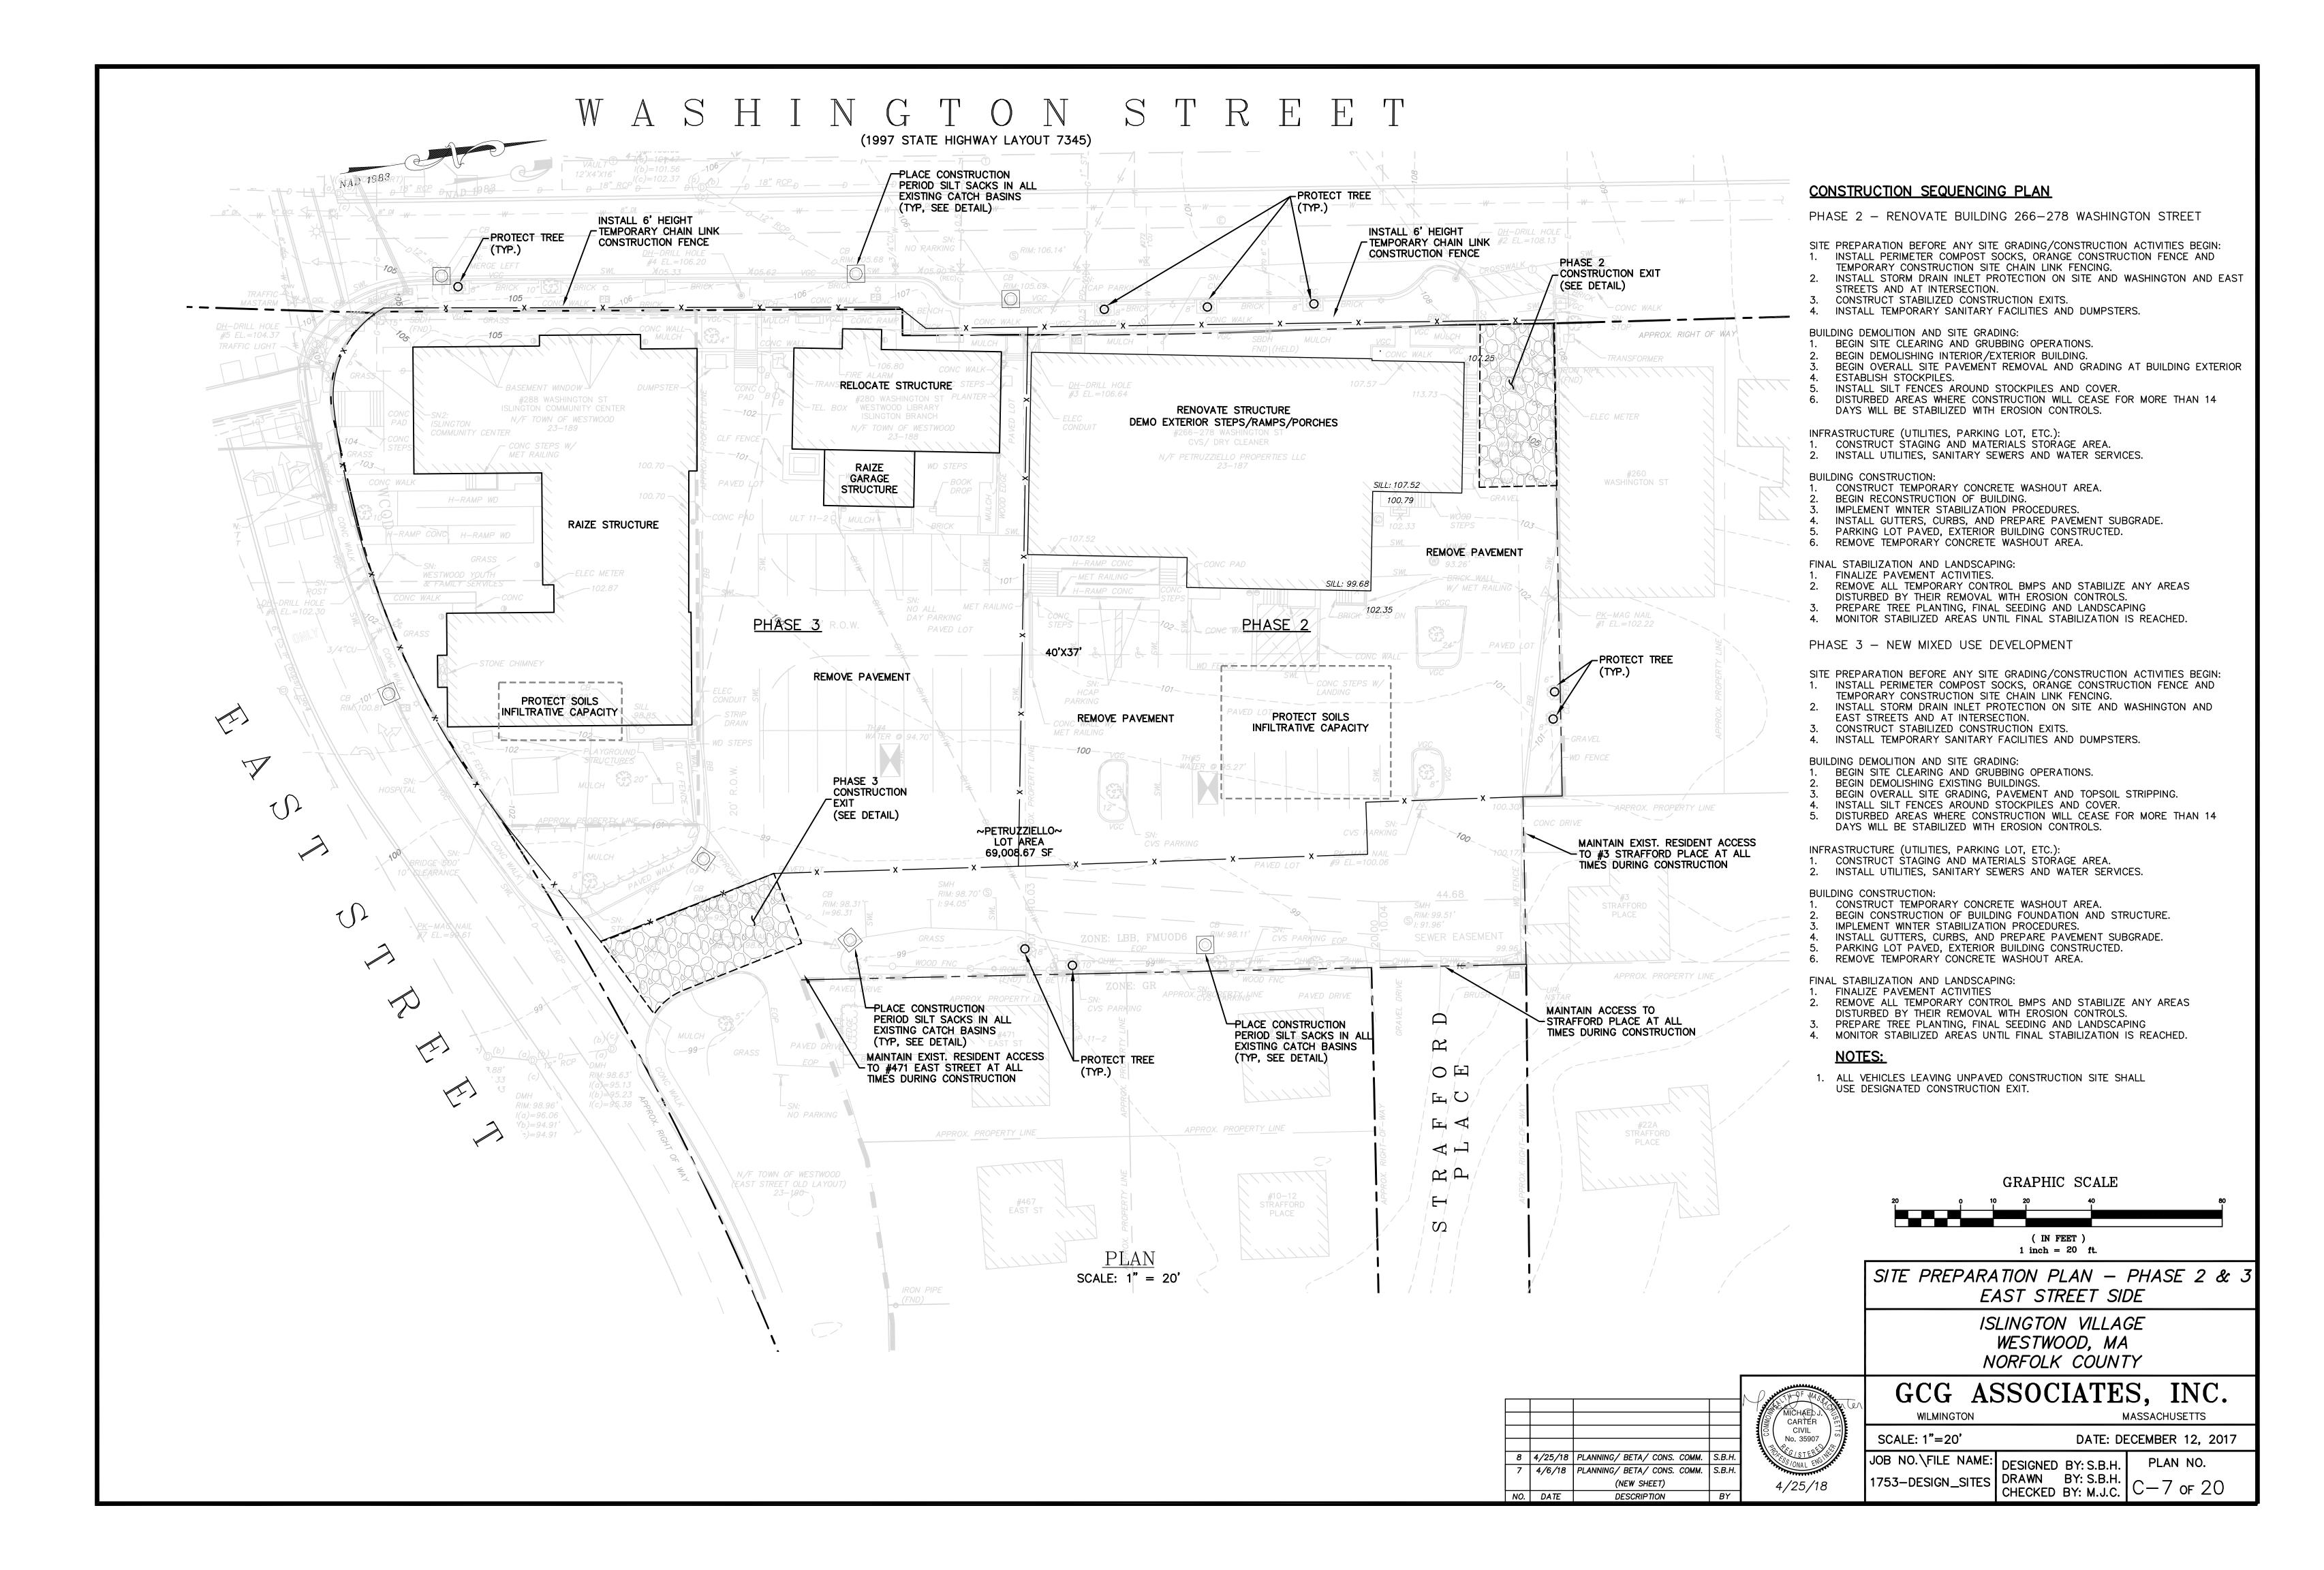
GCG ASSOCIATES, INC.


WILMINGTON	N	MASSACHUSETTS		
SCALE: 1"=40'		ECEMBER 12, 2017		
JOB NO.\FILE NAME:	DESIGNED BY:	PLAN NO.		
1753-BASE	DRAWN BY: S.B.H. CHECKED BY: M.J.C.	C-3 of 20		




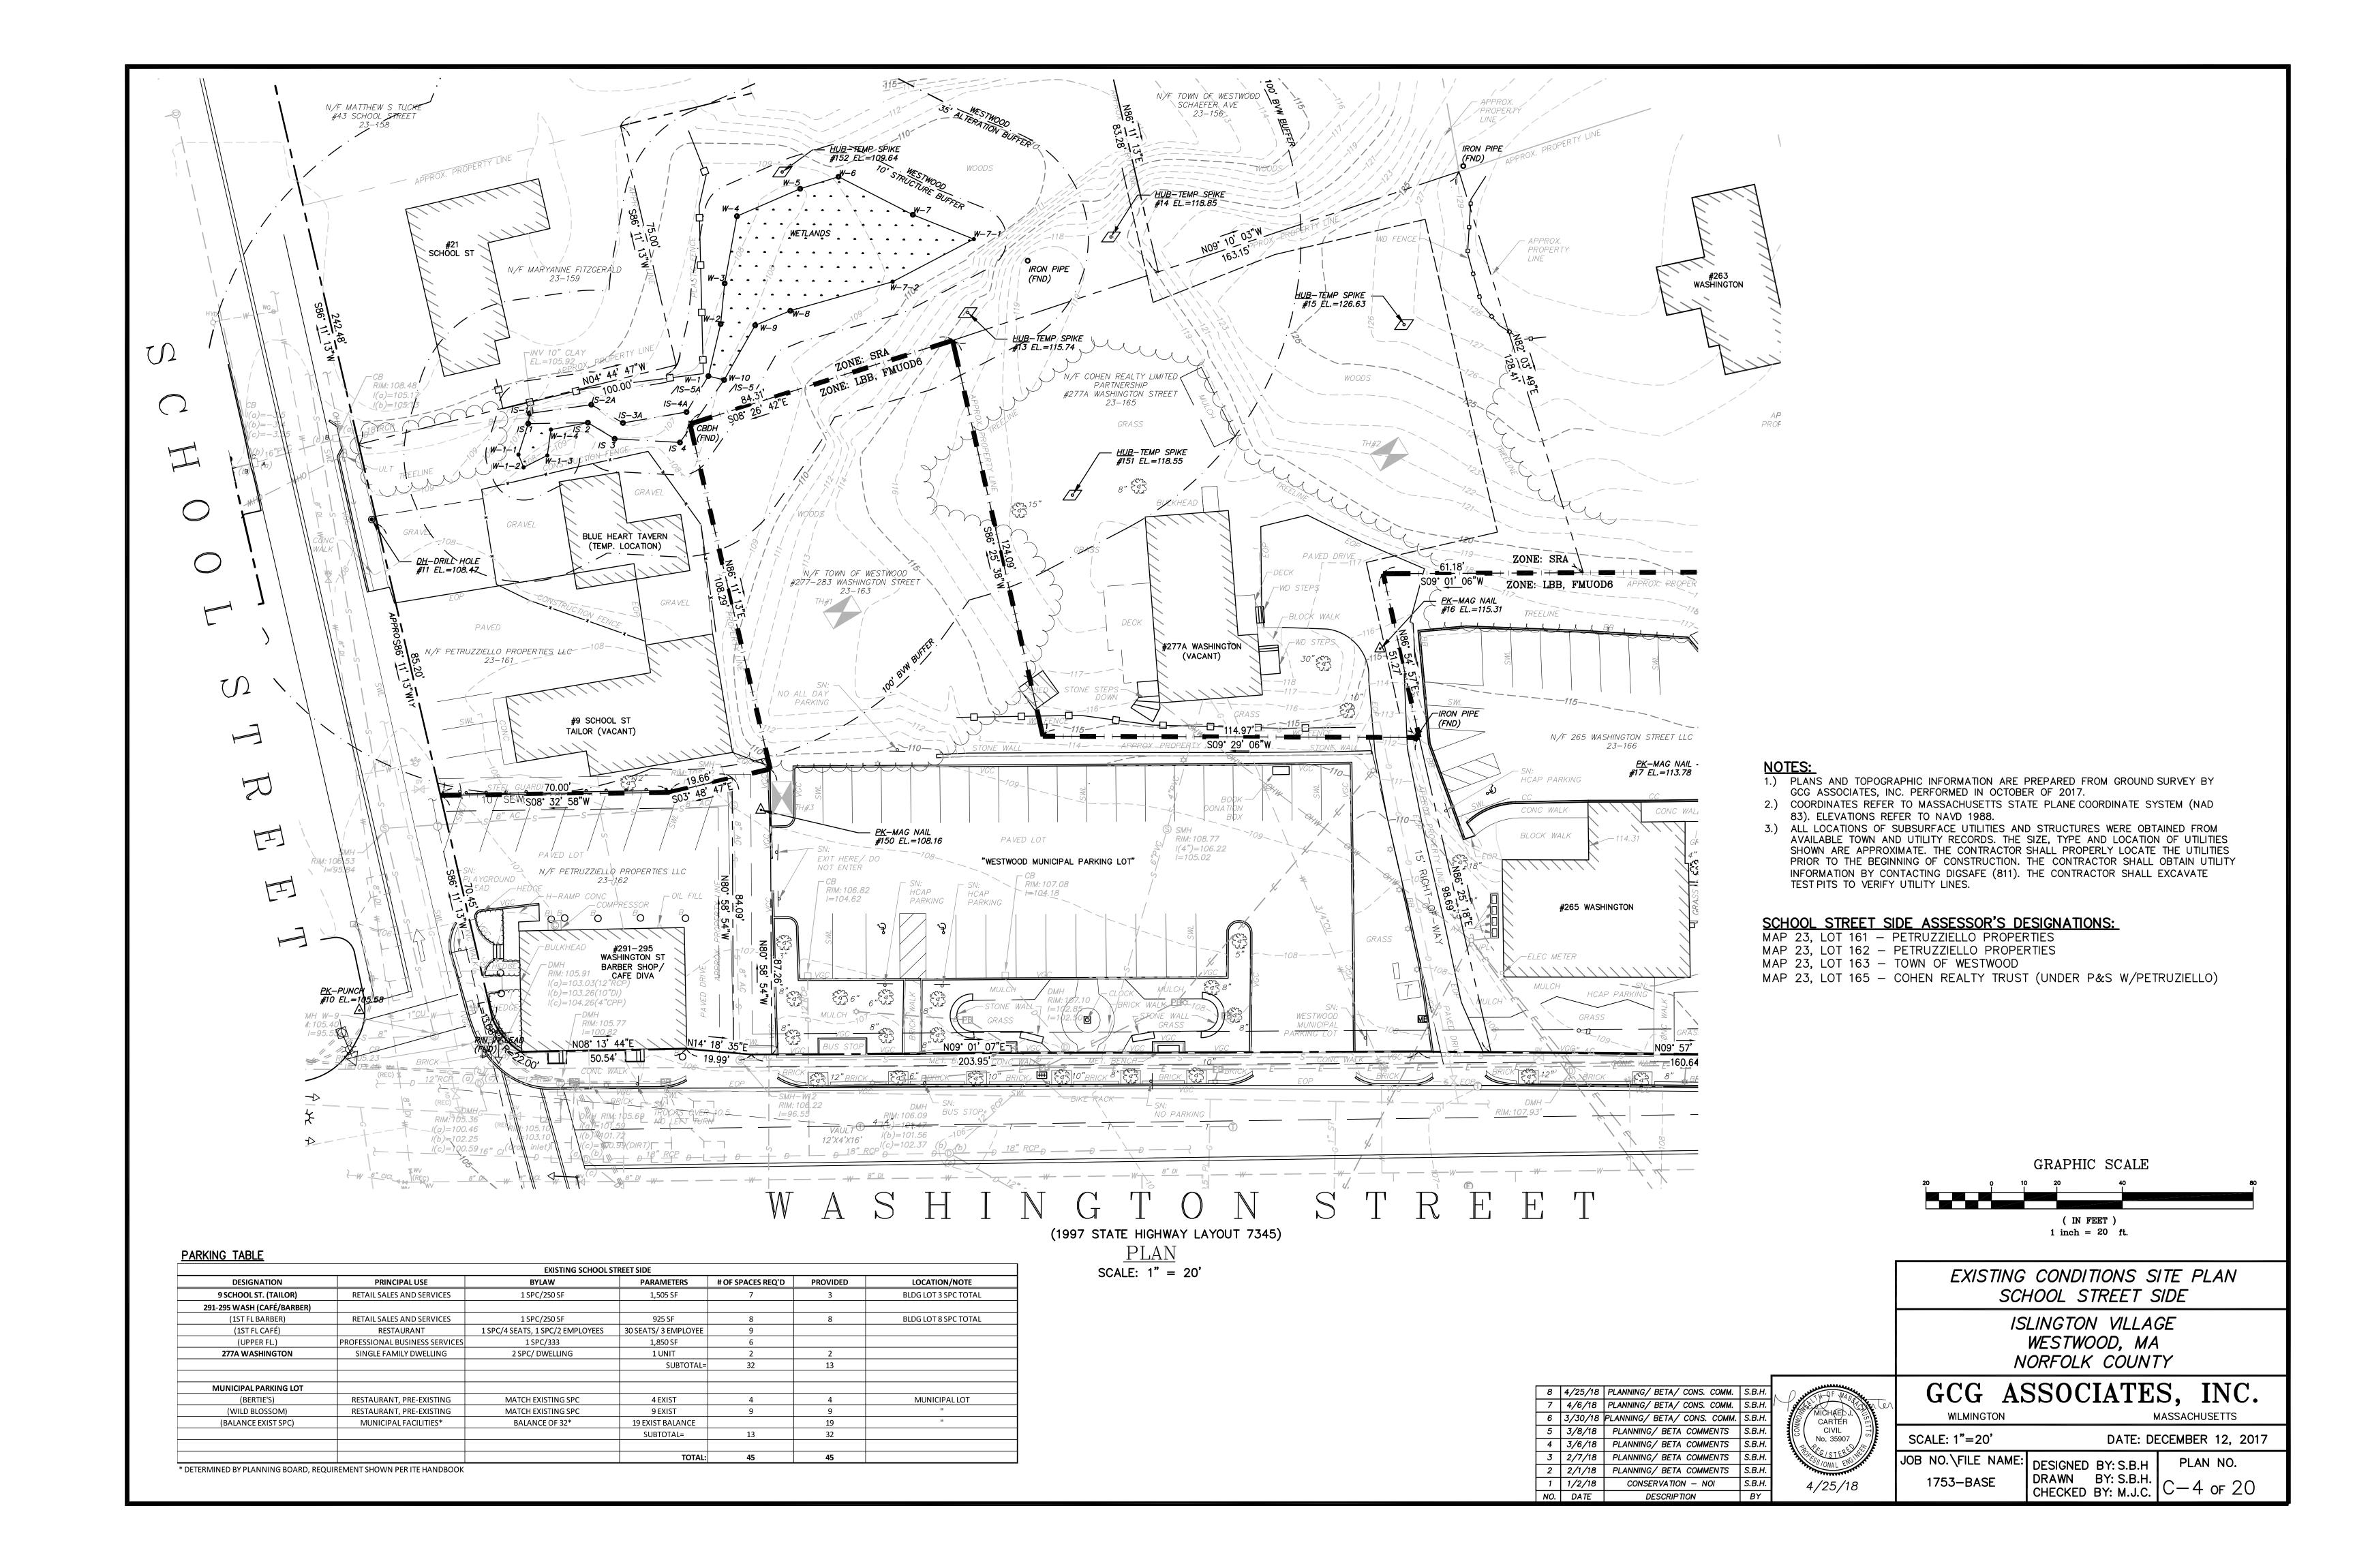


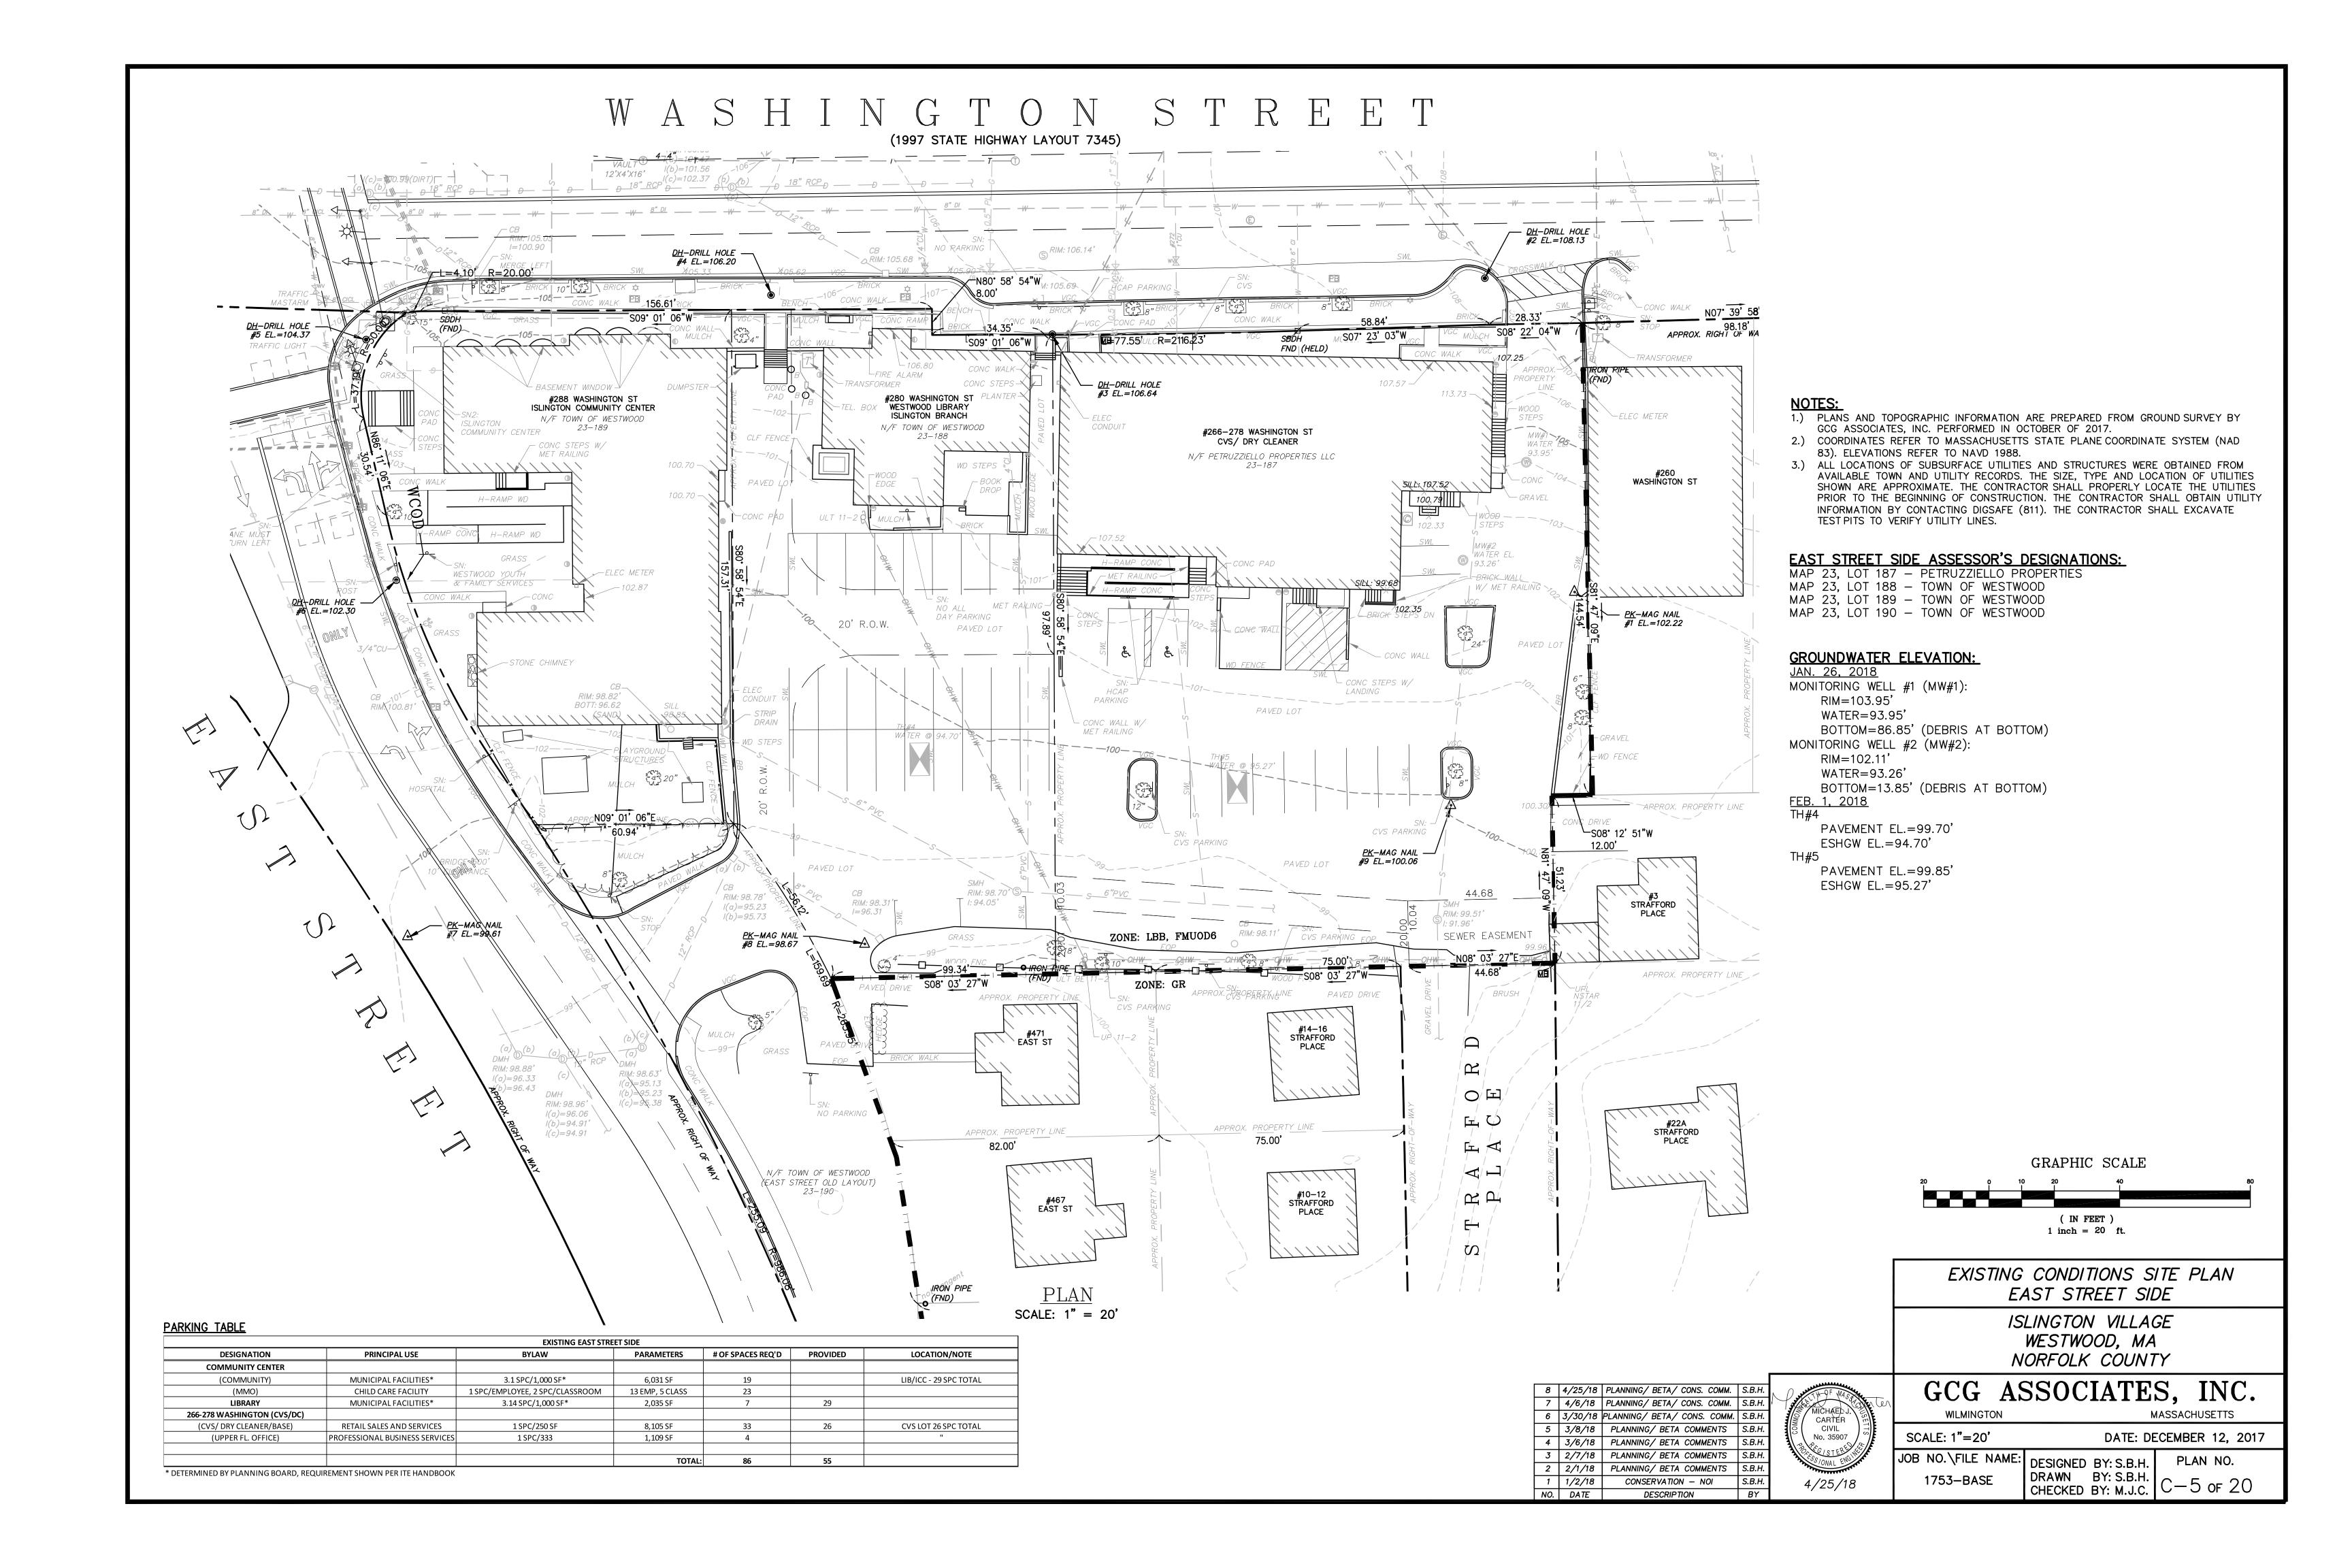


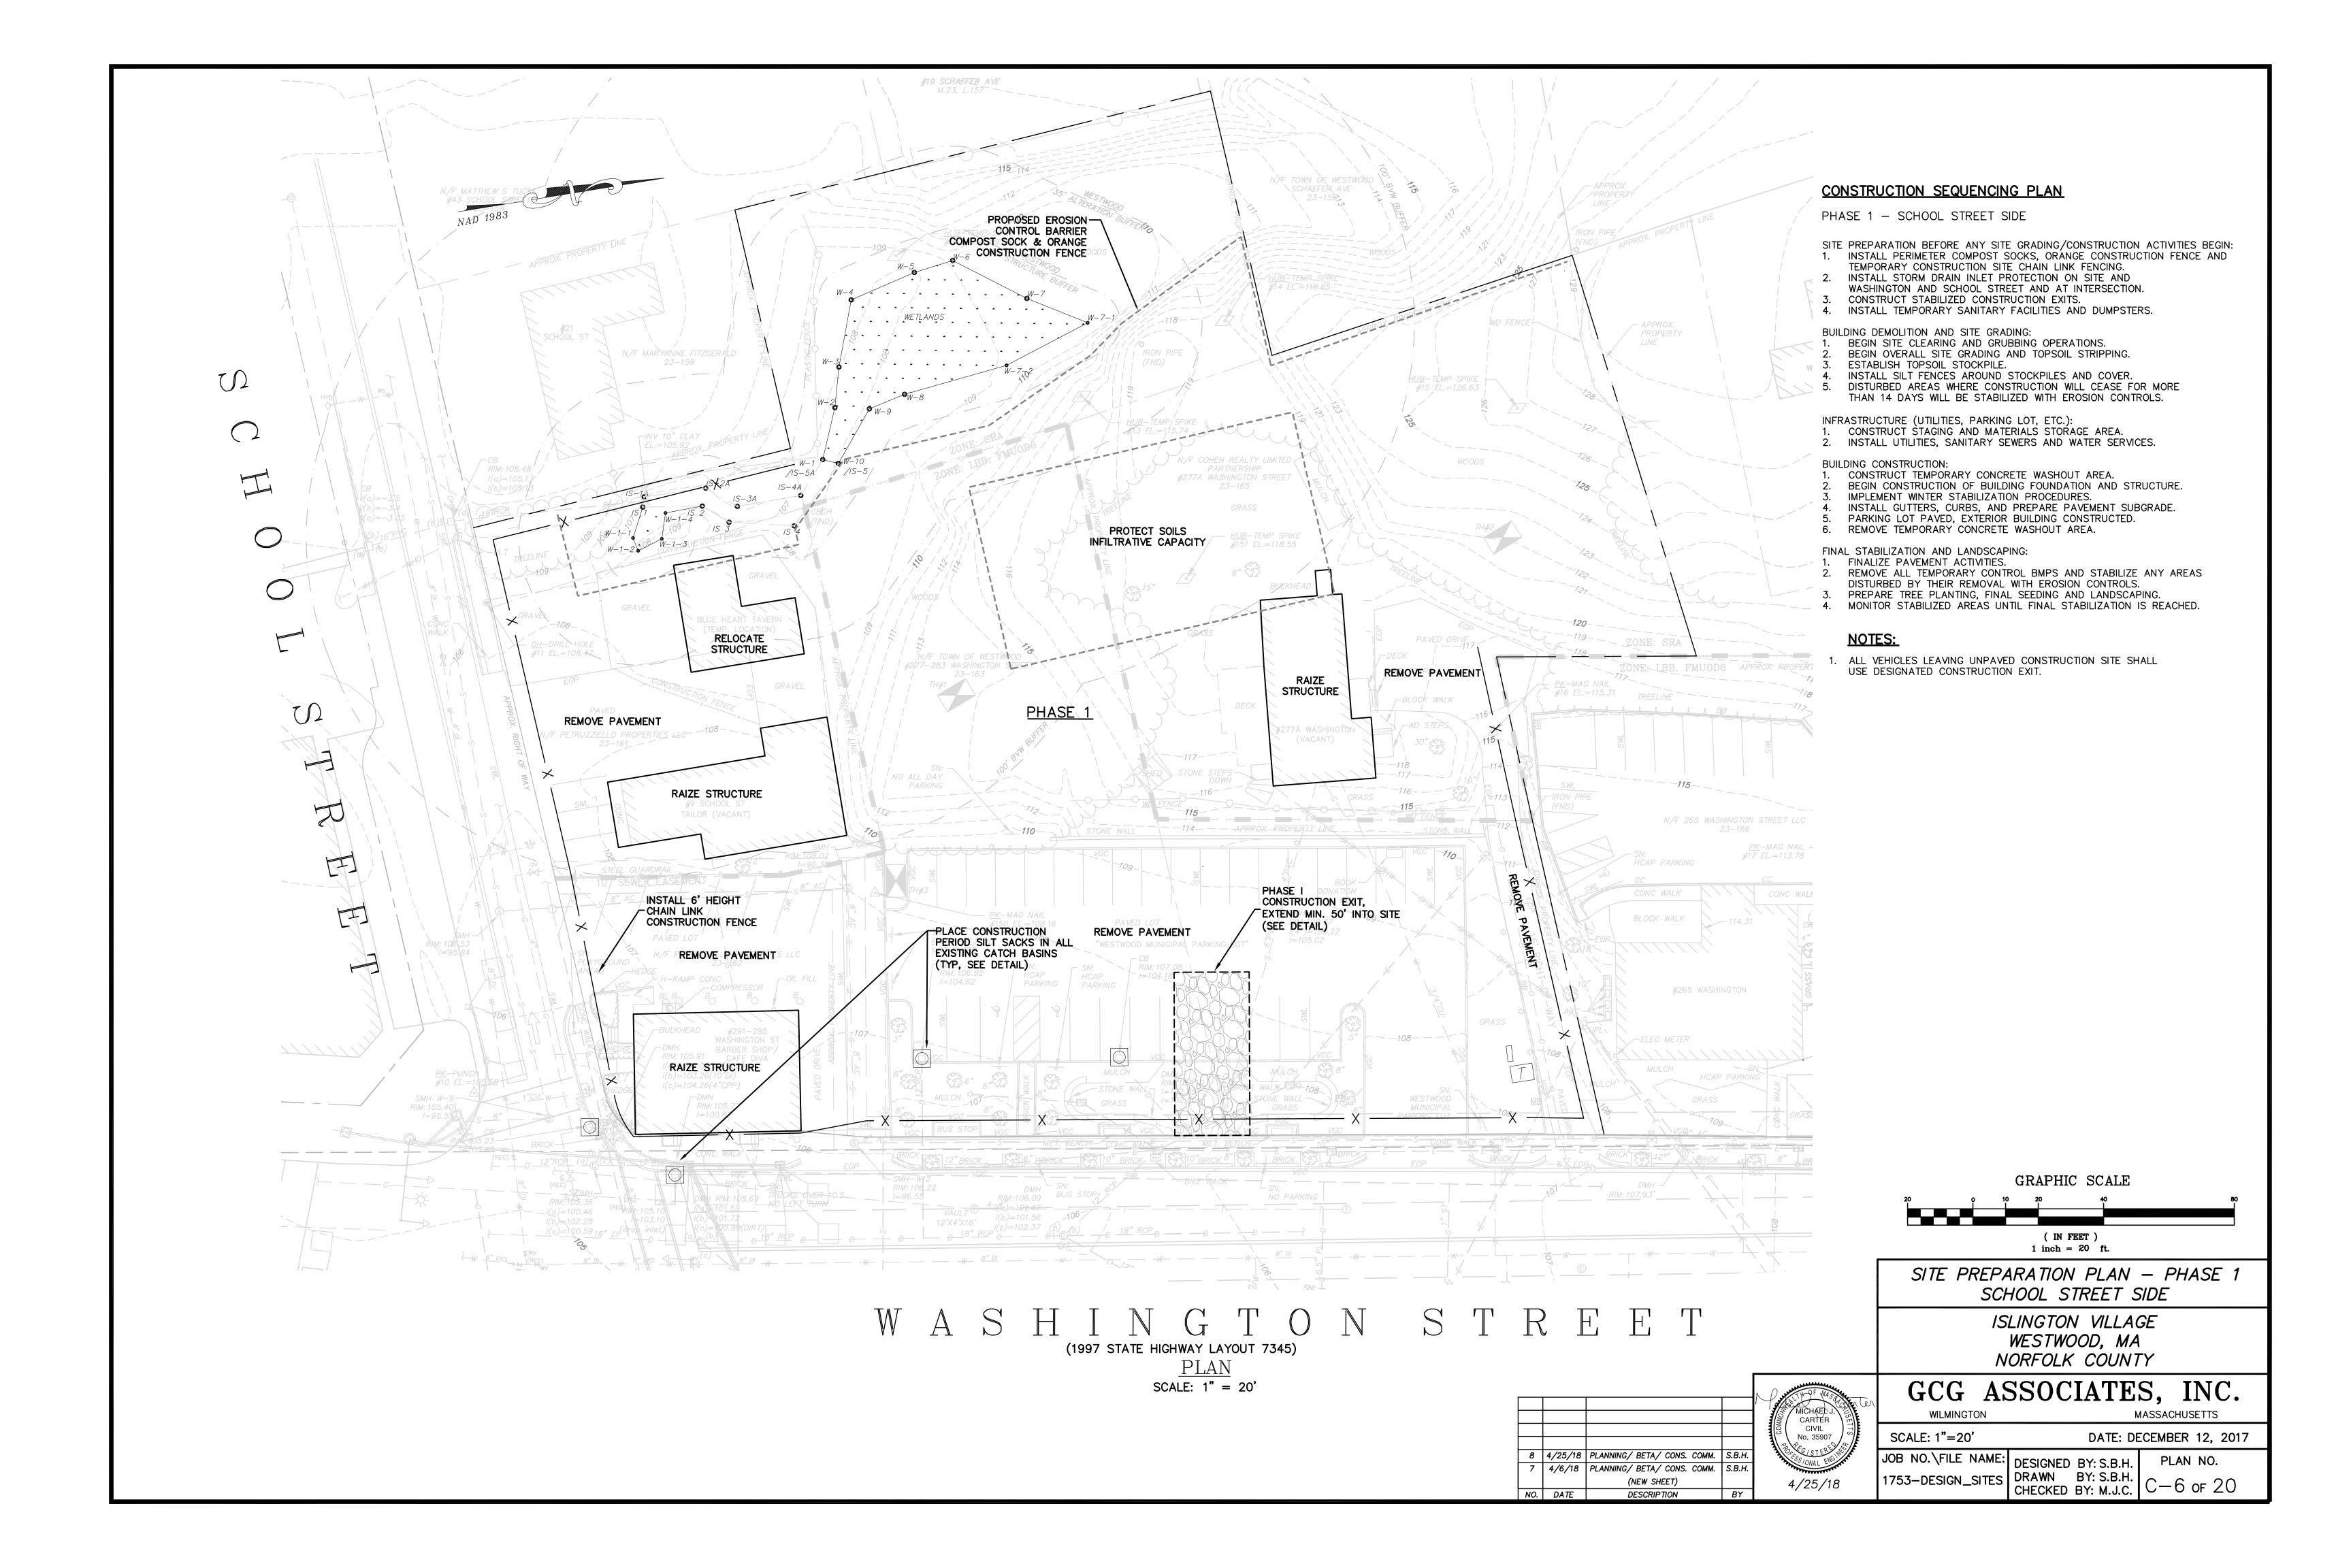


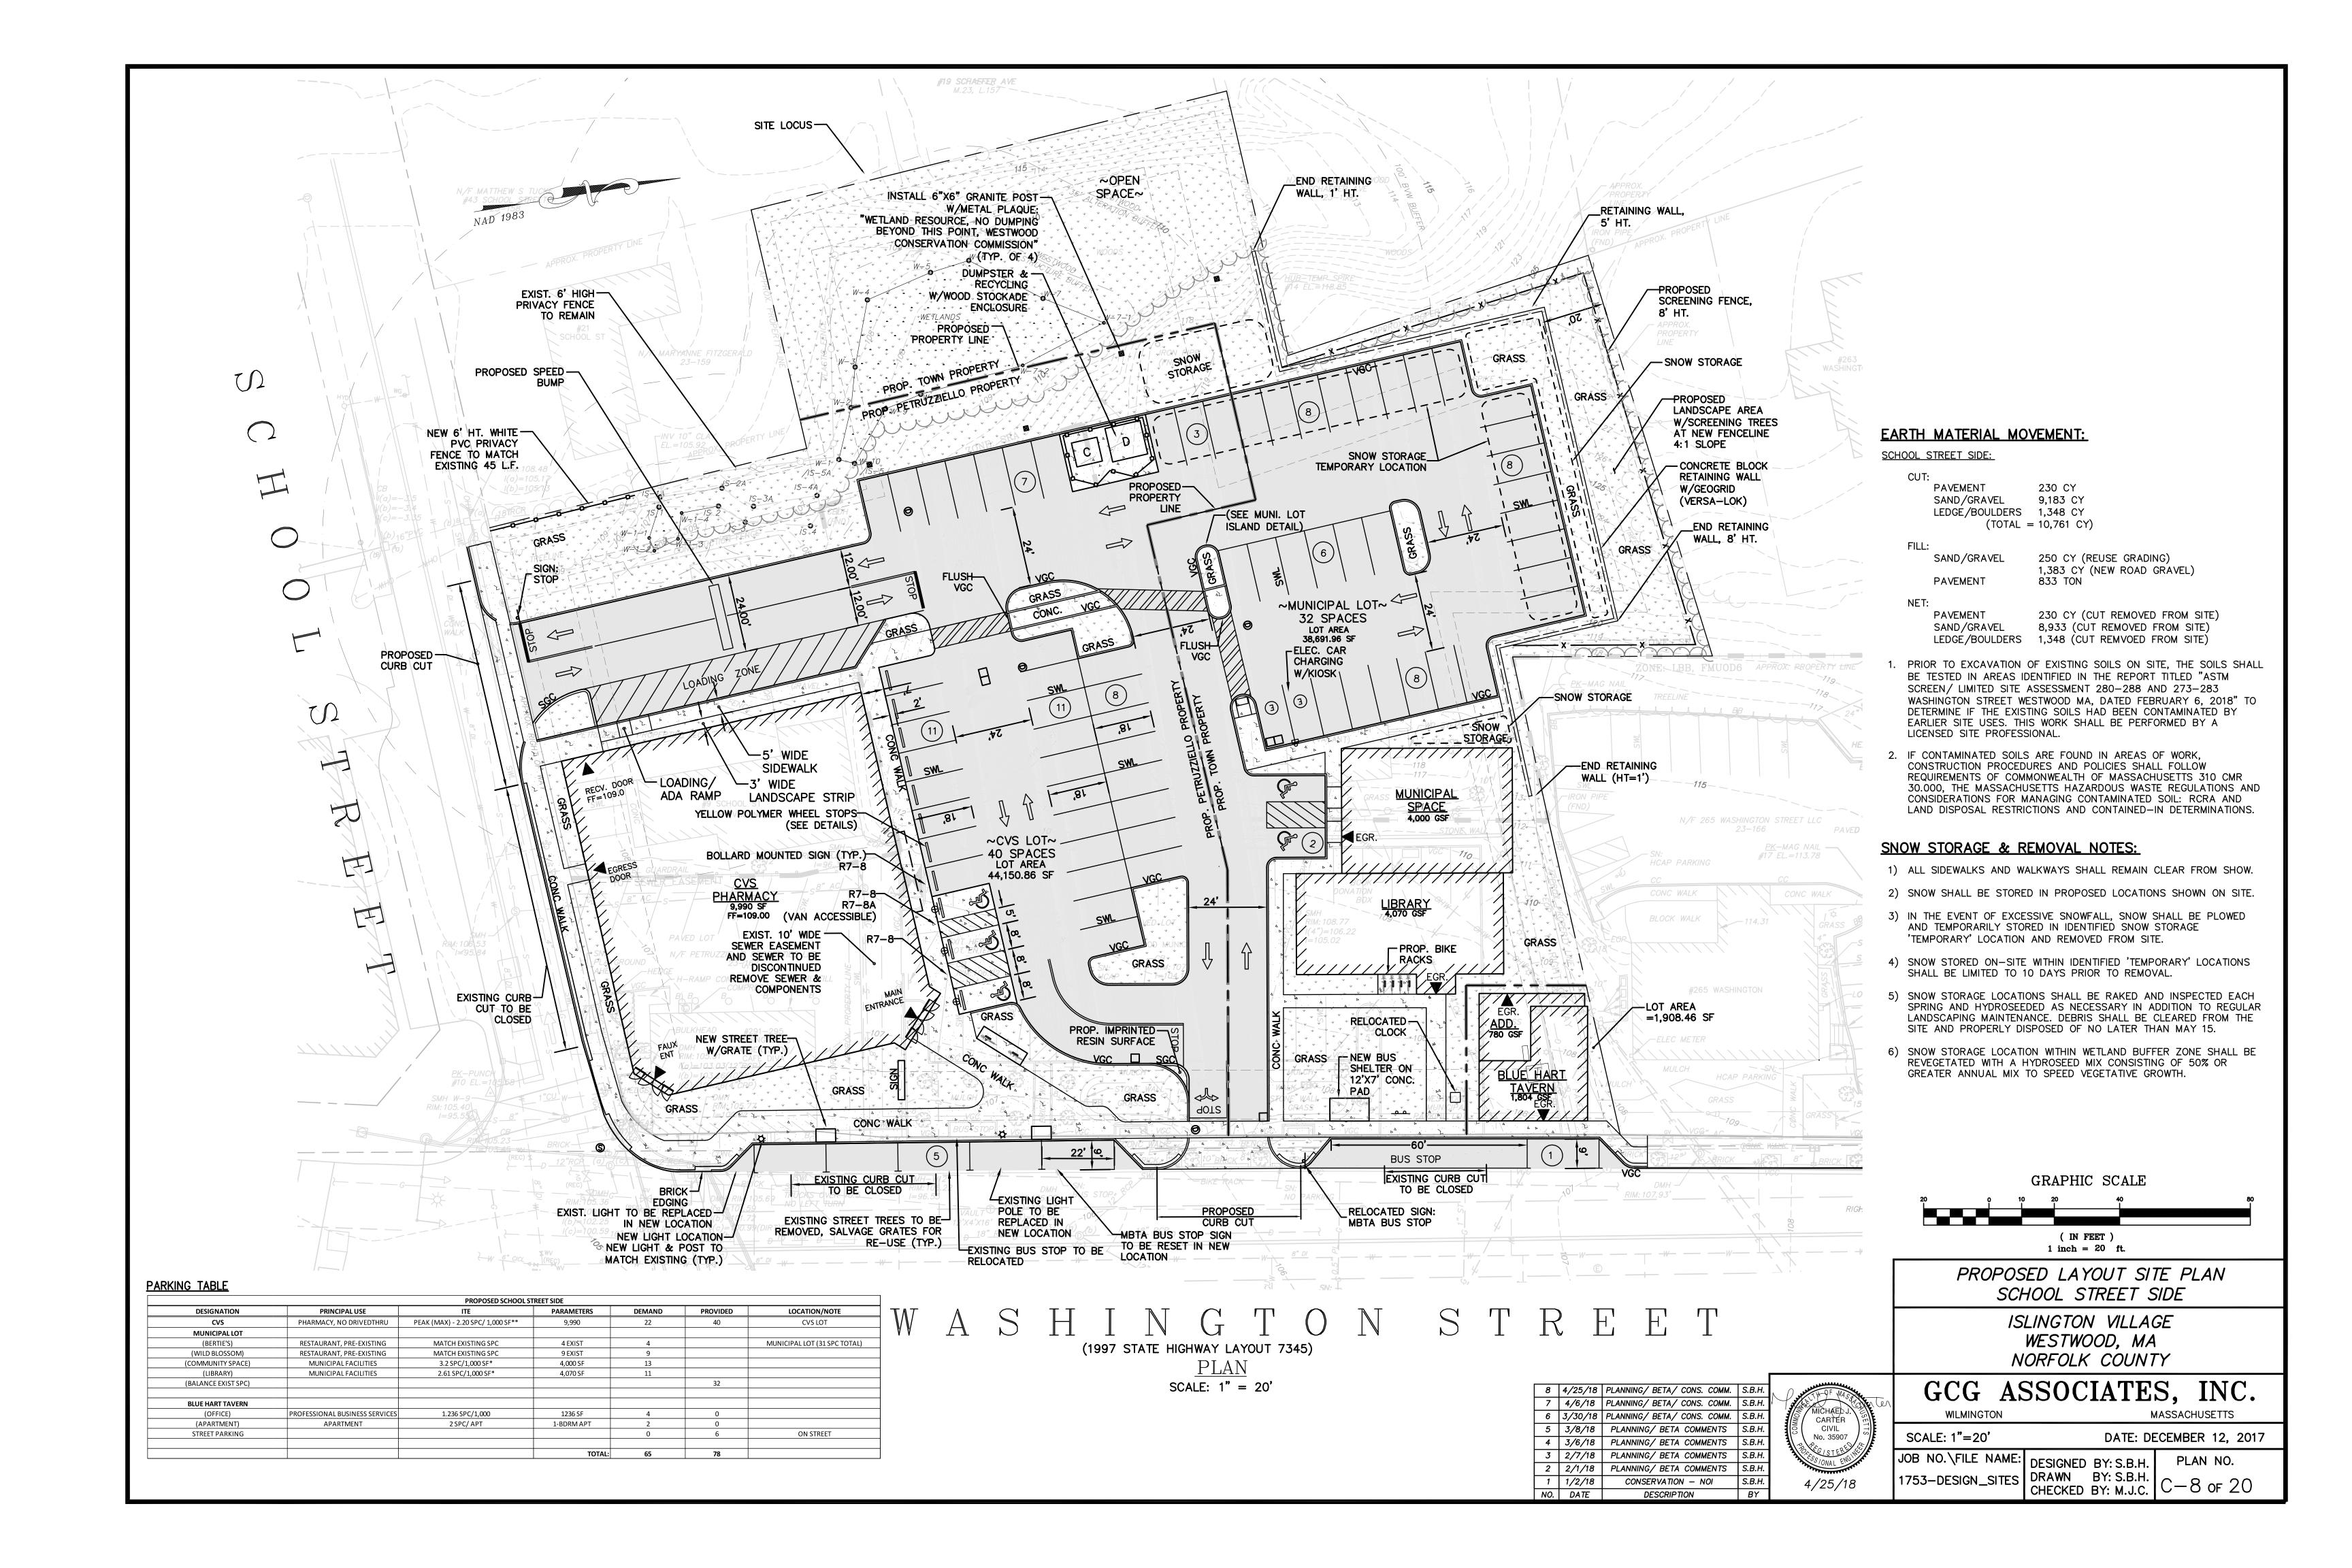

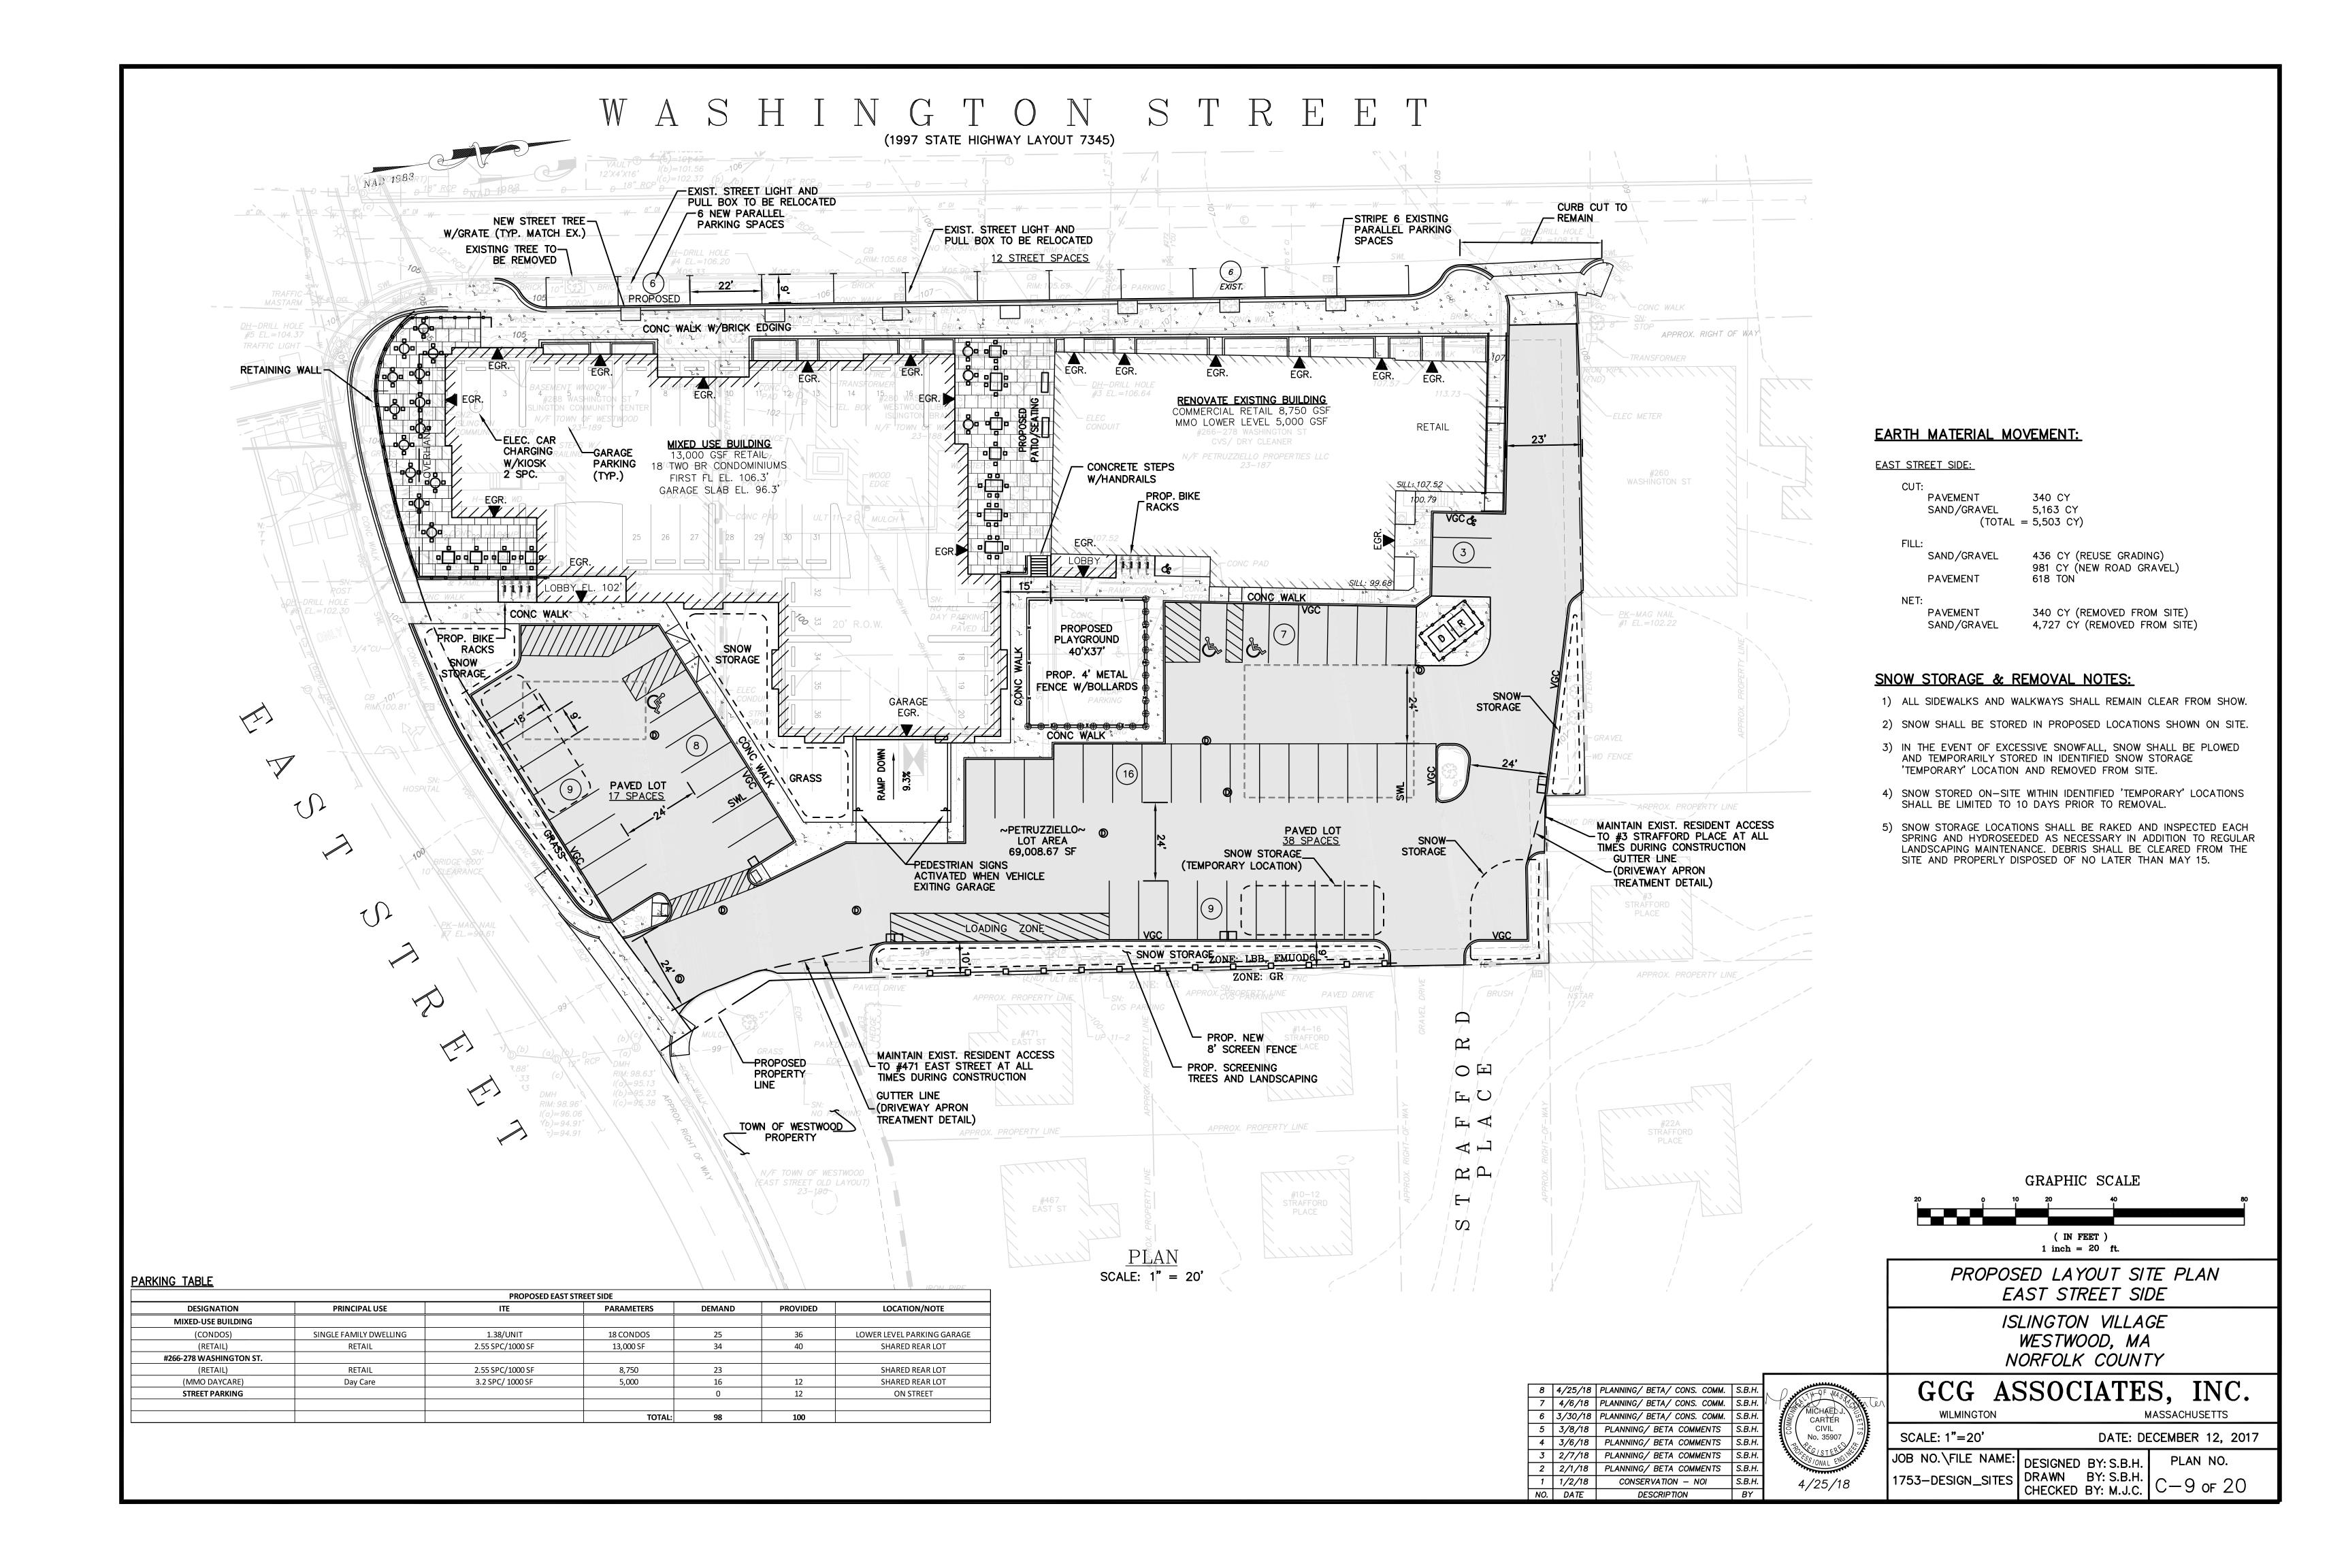

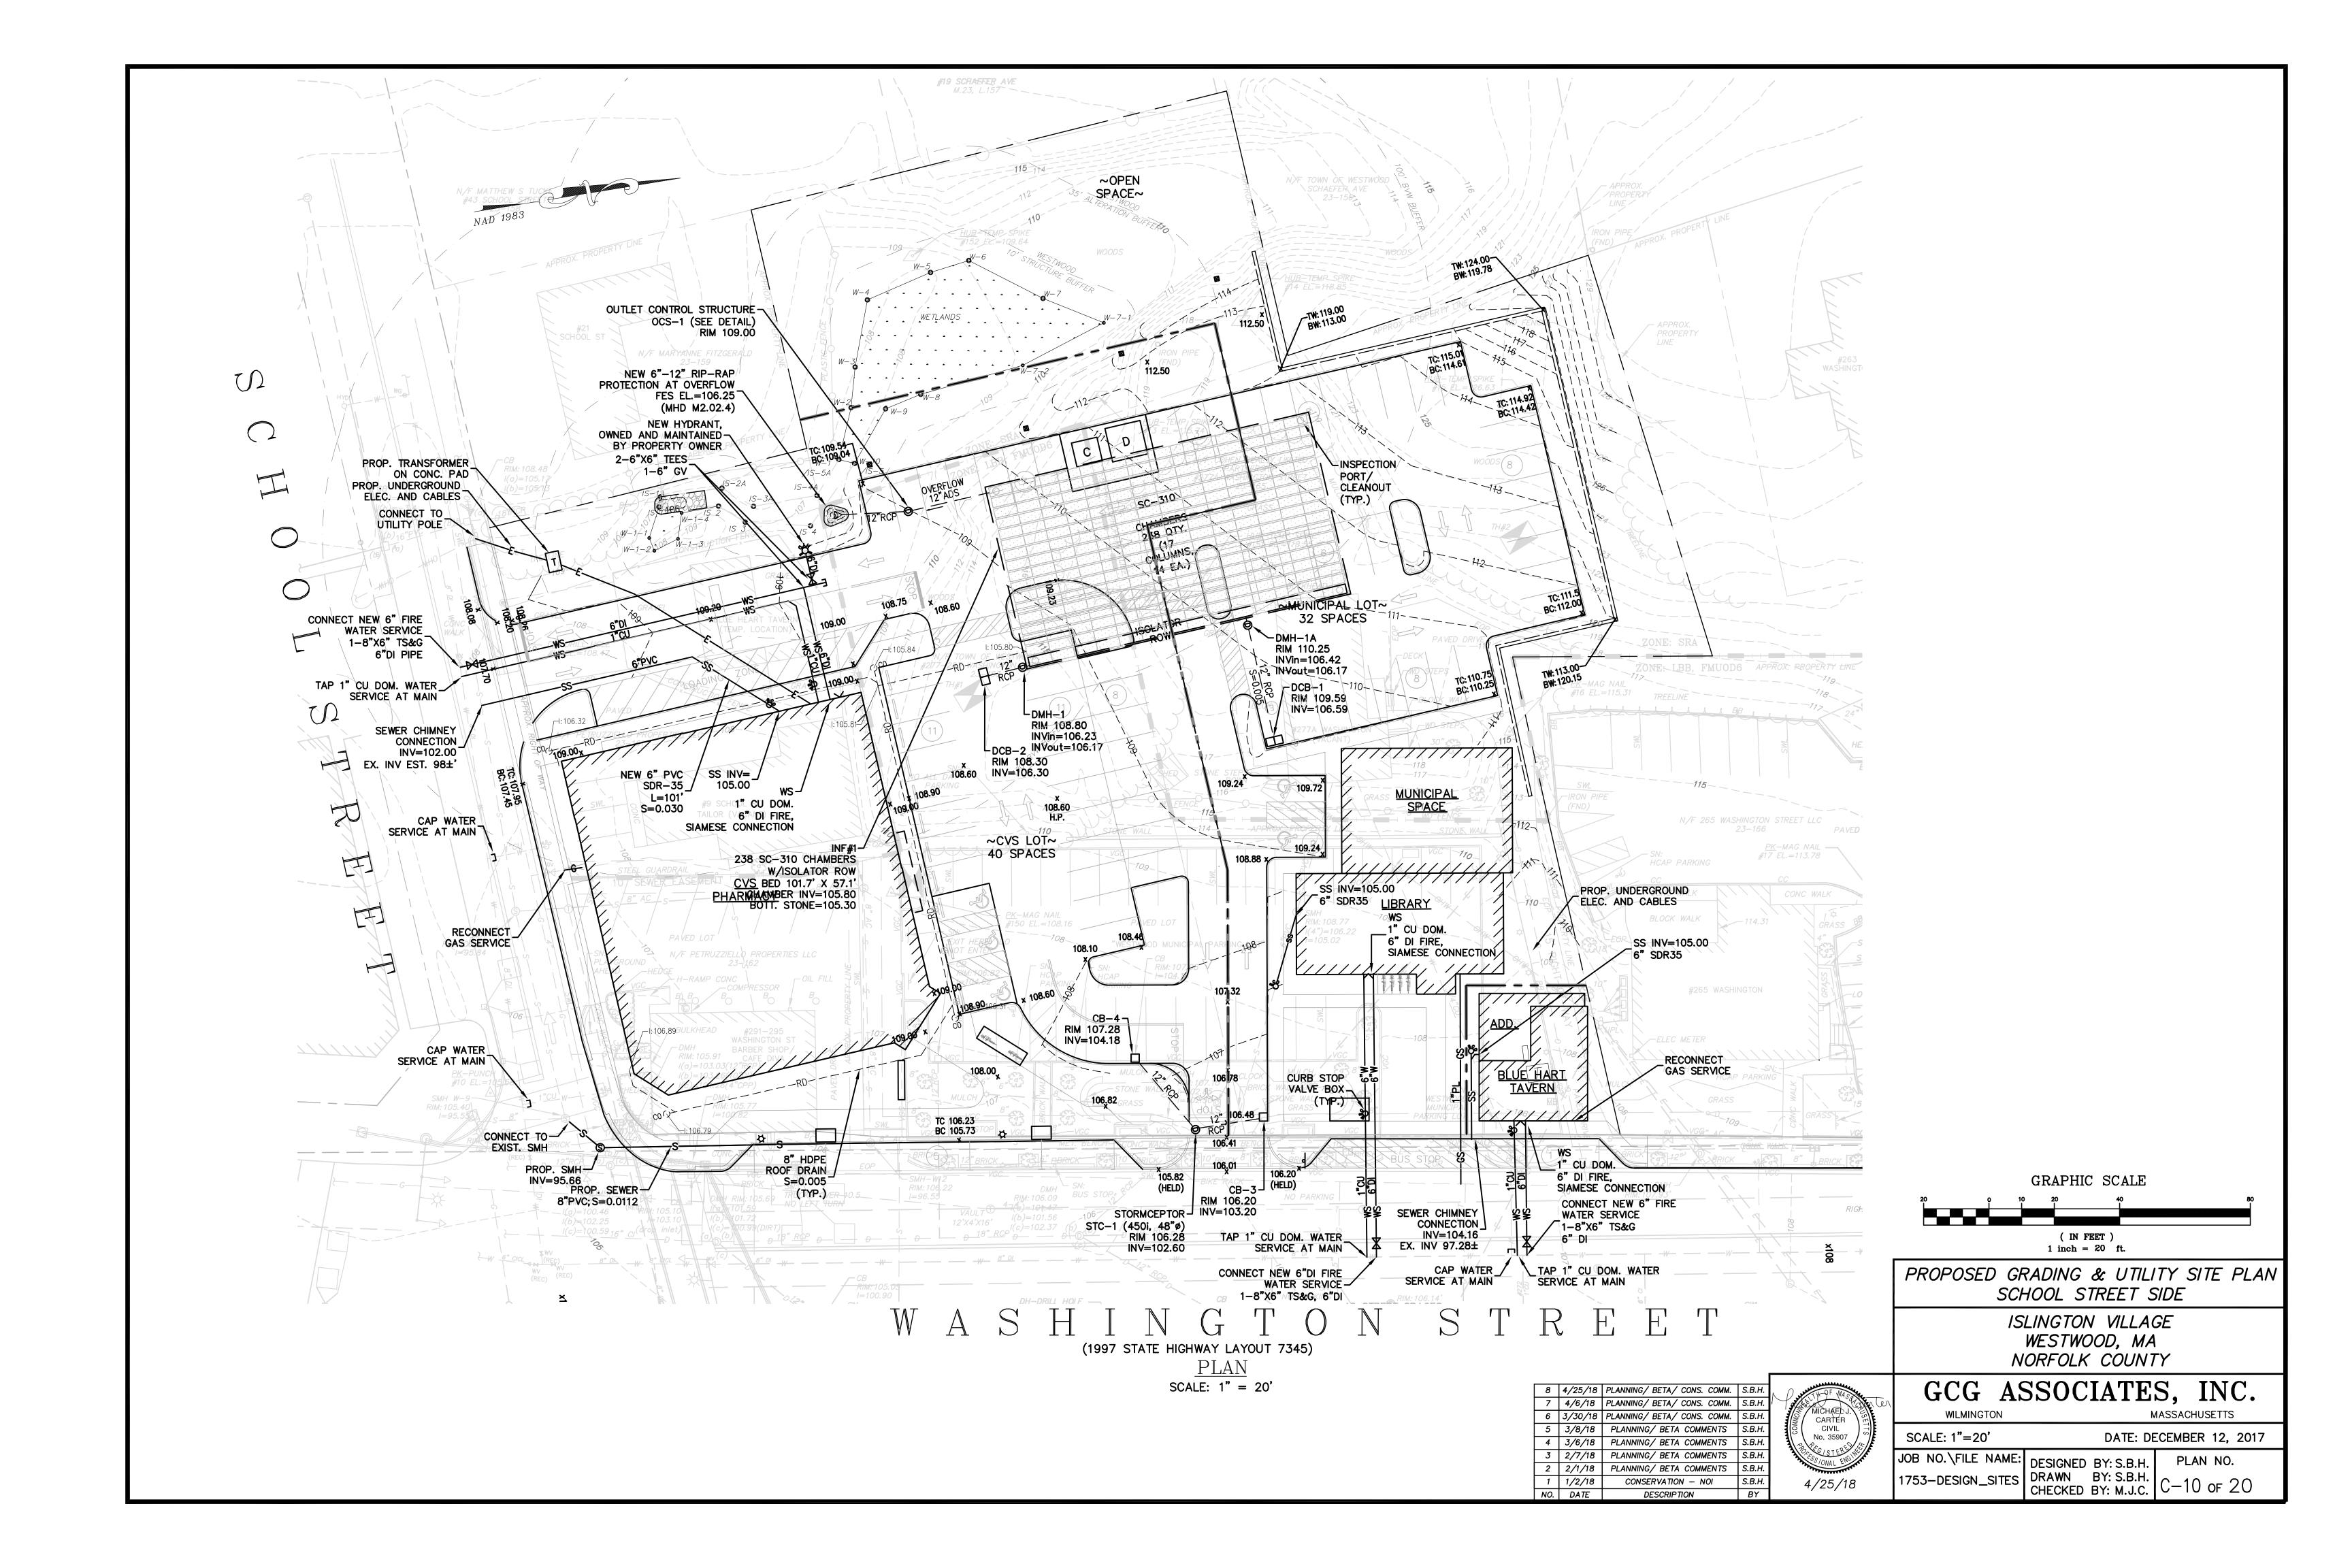

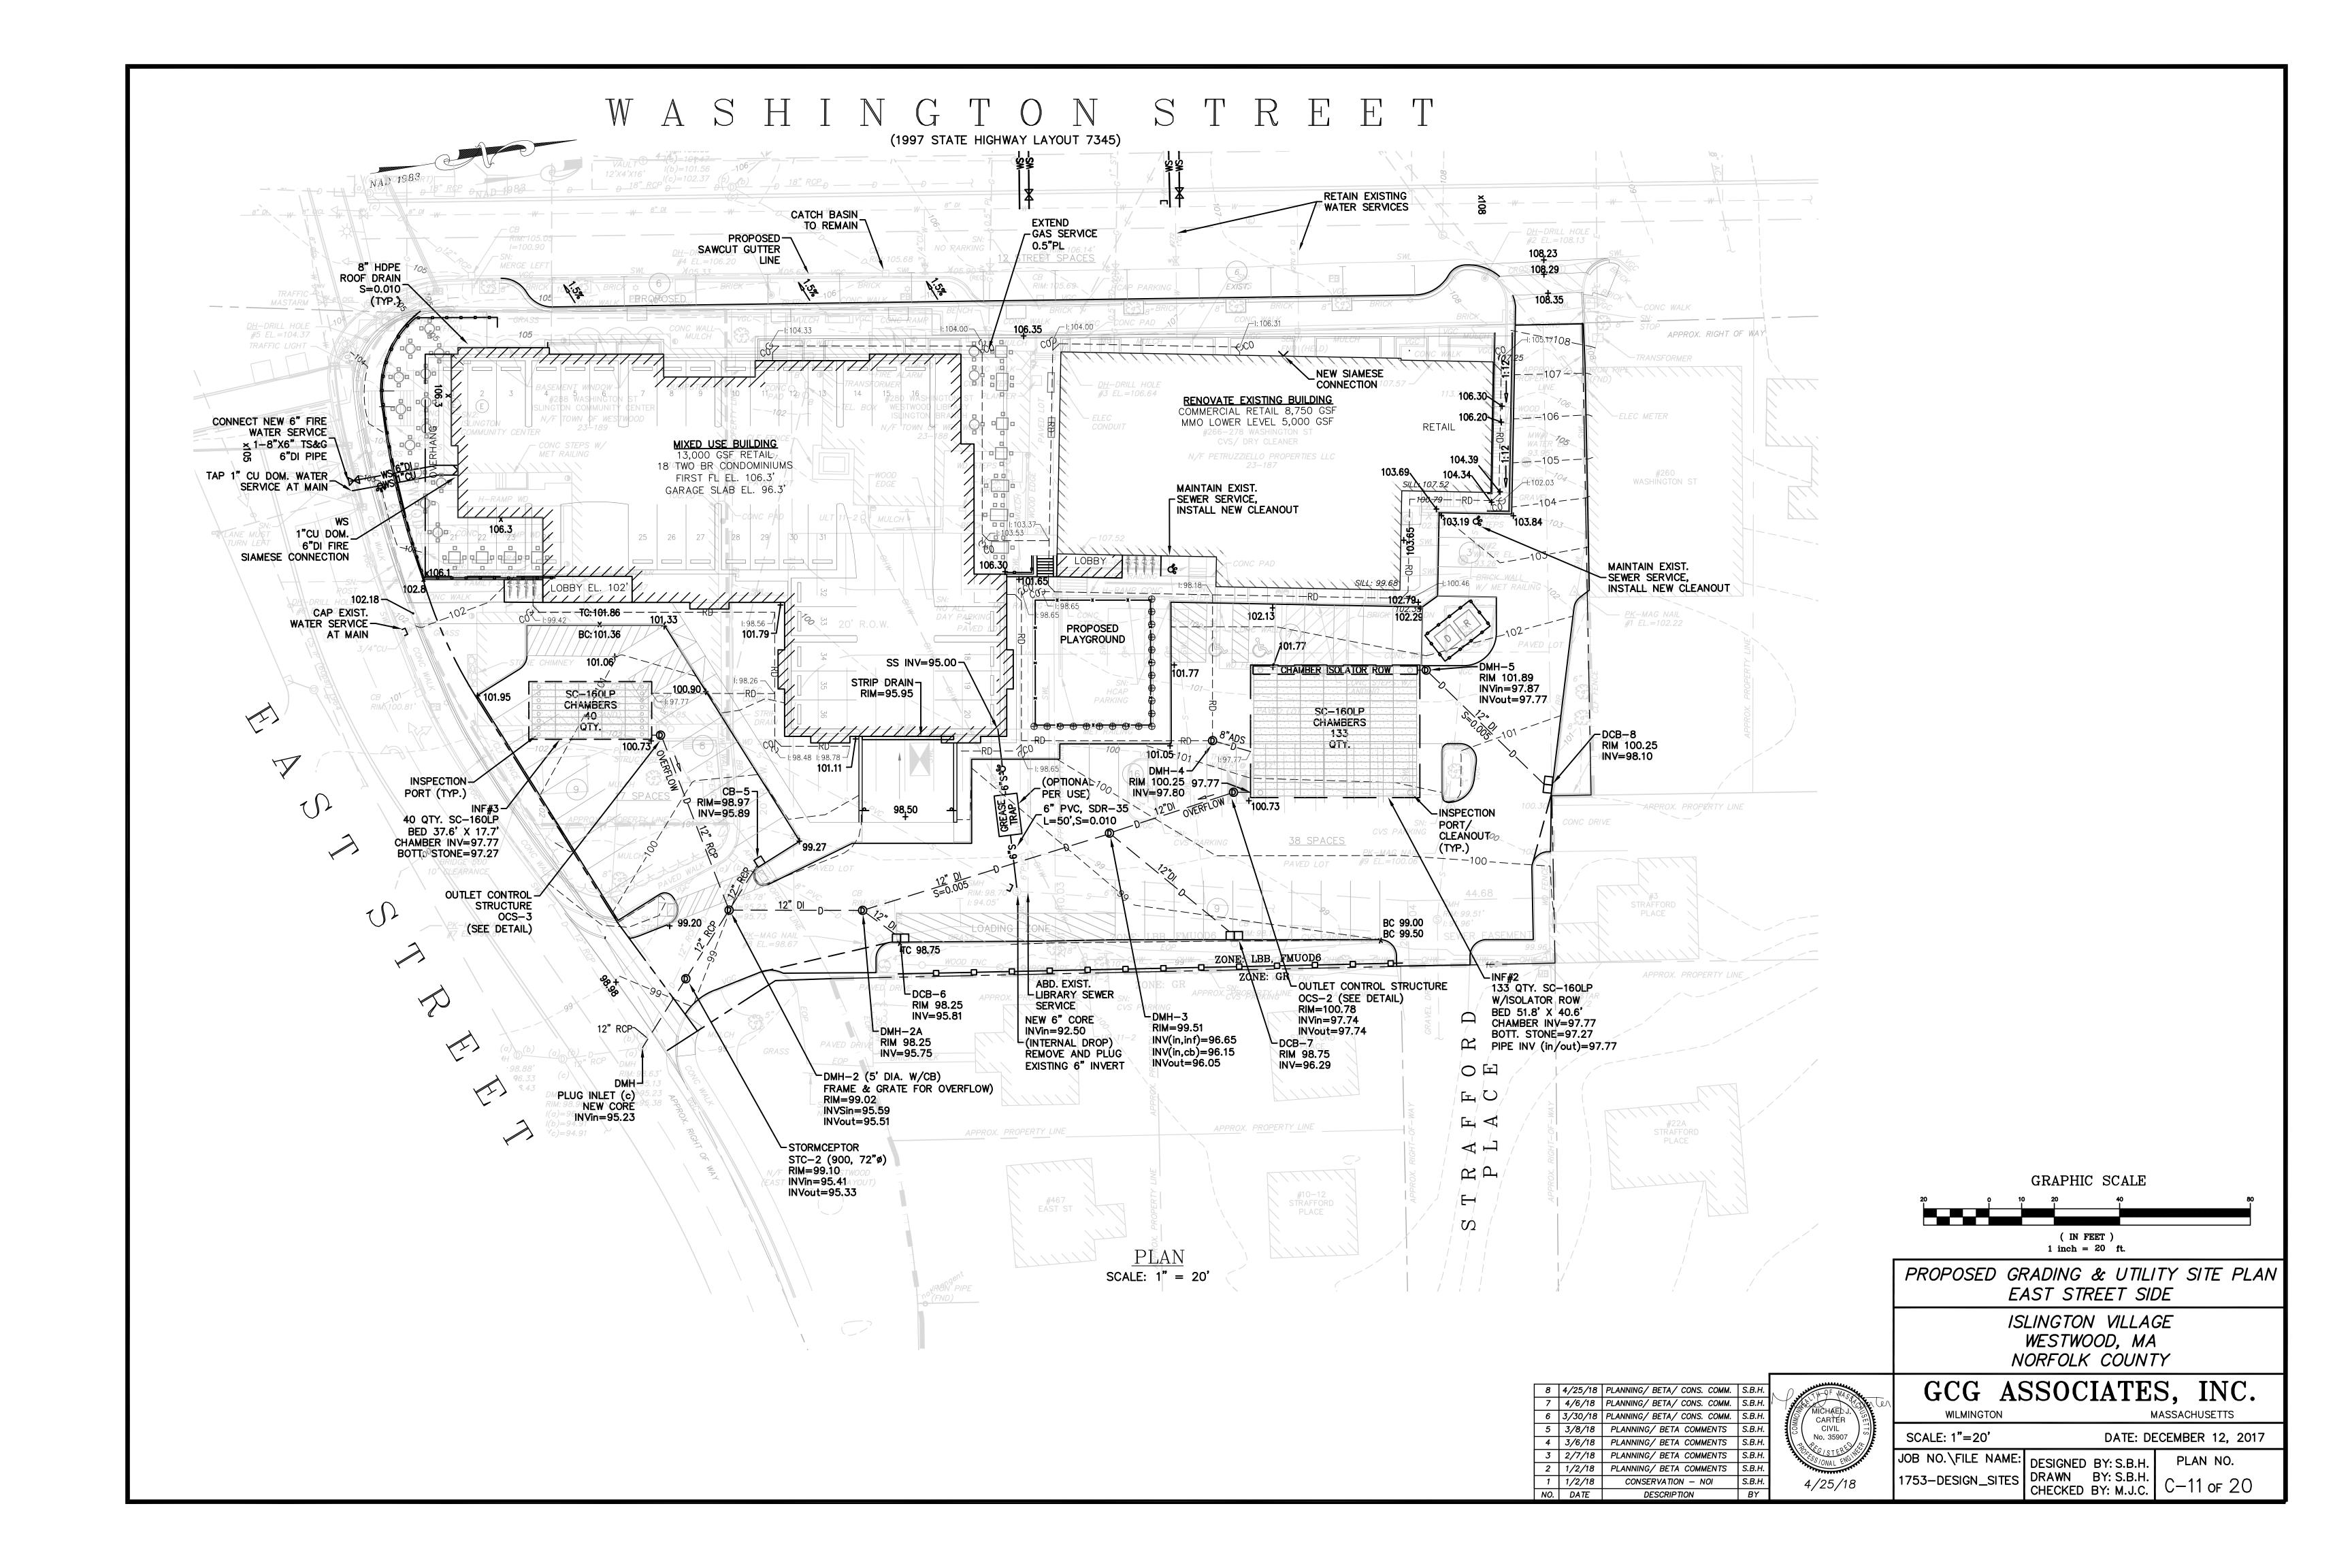

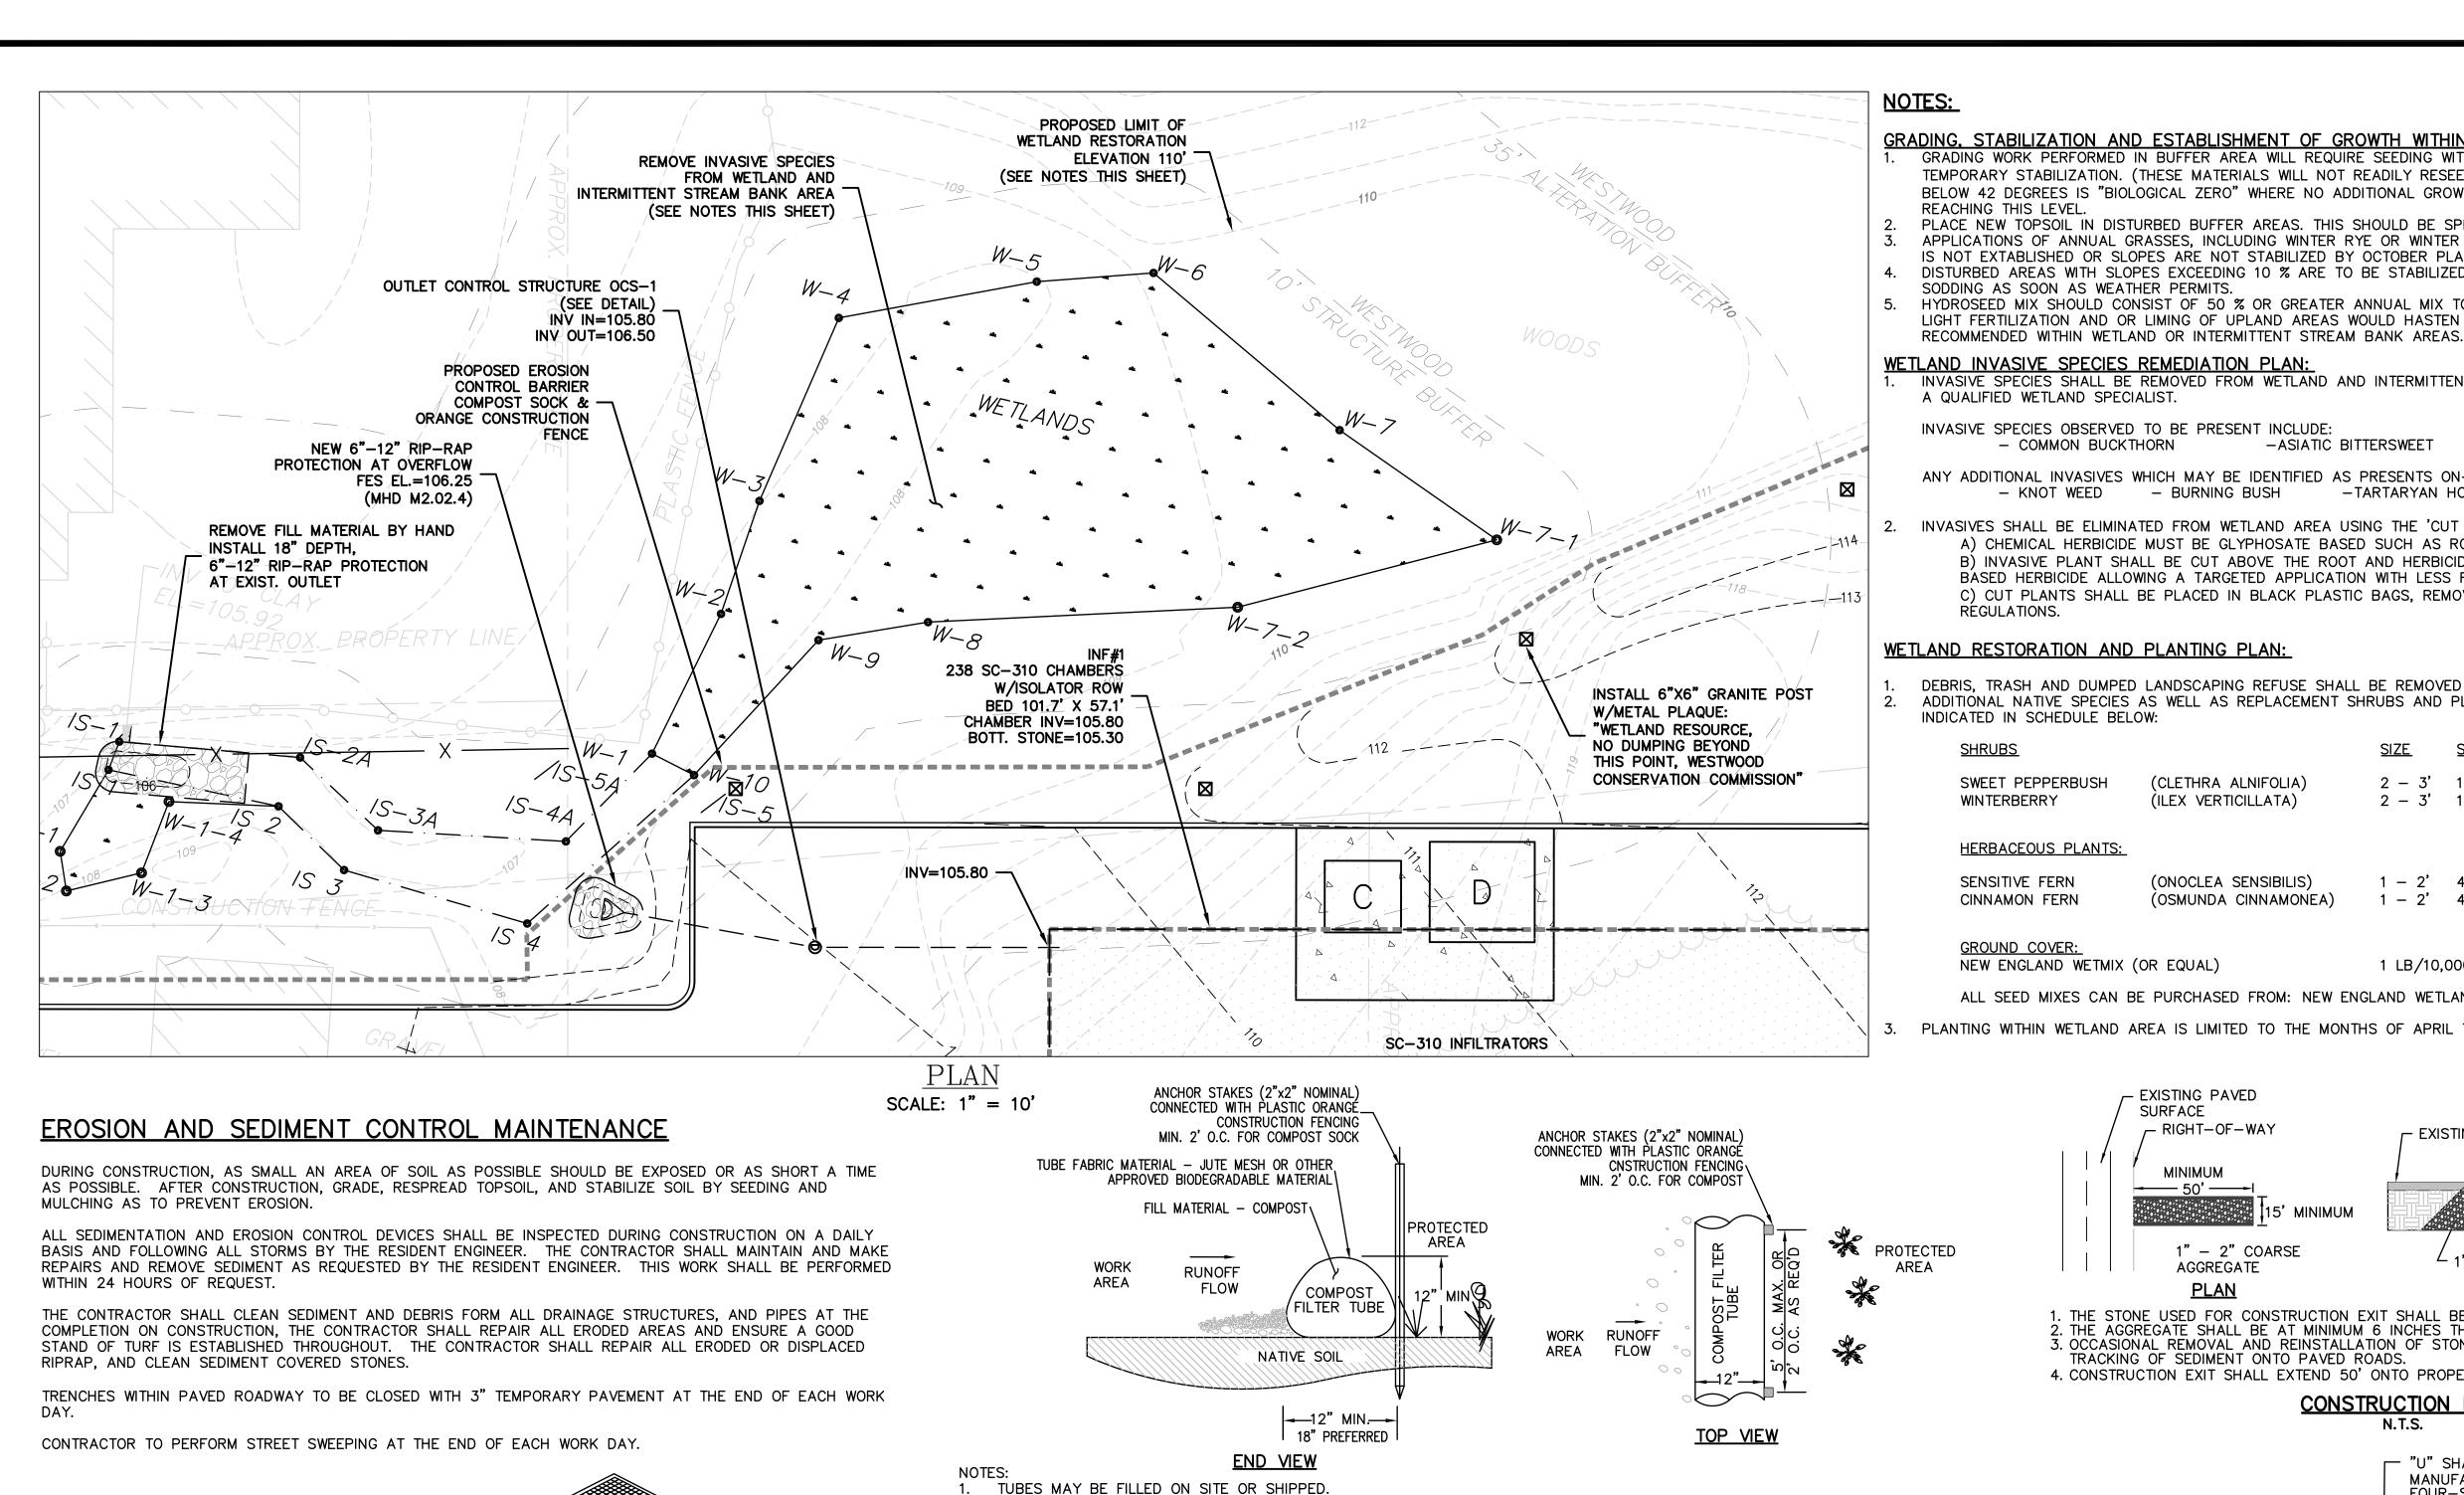

GRADING, STABILIZATION AND ESTABLISHMENT OF GROWTH WITHIN RESOURCE BUFFER AREA: GRADING WORK PERFORMED IN BUFFER AREA WILL REQUIRE SEEDING WITH ANNUAL GRASSES IN SEPTEMBER. WINTER RYE OR WINTER WHEAT FOR TEMPORARY STABILIZATION. (THESE MATERIALS WILL NOT READILY RESEED, BUT WILL RAPIDLY STABILIZE DISTURBED AREAS.) SOIL TEMPERATURES AT OR

BELOW 42 DEGREES IS "BIOLOGICAL ZERO" WHERE NO ADDITIONAL GROWTH CAN BE EXPECTED. SEEDING MUST BE DONE PRIOR TO SOIL TEMPERATURES REACHING THIS LEVEL. PLACE NEW TOPSOIL IN DISTURBED BUFFER AREAS. THIS SHOULD BE SPREAD TO PROVIDE A COARSE MICROTOPOGRAPHY

APPLICATIONS OF ANNUAL GRASSES, INCLUDING WINTER RYE OR WINTER WHEAT SHOULD BE USED FOR STABILIZATION IN WETLAND BUFFER AREA. IF GROWTH IS NOT EXTABLISHED OR SLOPES ARE NOT STABILIZED BY OCTOBER PLACE A LIGHT COVERING OF MULCH.

DISTURBED AREAS WITH SLOPES EXCEEDING 10 % ARE TO BE STABILIZED THROUGH HYDROSEED, MULCHING, JUTE NETTING OR SODDING AS SOON AS WEATHER PERMITS.

HYDROSEED MIX SHOULD CONSIST OF 50 % OR GREATER ANNUAL MIX TO SPEED VEGETATIVE GROWTH LIGHT FERTILIZATION AND OR LIMING OF UPLAND AREAS WOULD HASTEN REVEGETATION AND IS RECOMMENDED. NO LIMING OR FERTILIZATION IS

WETLAND INVASIVE SPECIES REMEDIATION PLAN:

INVASIVE SPECIES SHALL BE REMOVED FROM WETLAND AND INTERMITTENT STREAM BANK AREA. WORK TO BE INSPECTED BY A QUALIFIED WETLAND SPECIALIST.

INVASIVE SPECIES OBSERVED TO BE PRESENT INCLUDE: COMMON BUCKTHORN -ASIATIC BITTERSWEET – MULTI-FLORA ROSE

ANY ADDITIONAL INVASIVES WHICH MAY BE IDENTIFIED AS PRESENTS ON-SITE SHALL BE REMOVED. COMMON SPECIES INCLUDE: -TARTARYAN HONEYSUCKLE BURNING BUSH NORWAY MAPLE

INVASIVES SHALL BE ELIMINATED FROM WETLAND AREA USING THE 'CUT & DAB' METHOD AS FOLLOWS: A) CHEMICAL HERBICIDE MUST BE GLYPHOSATE BASED SUCH AS ROUNDUP, RODEO OR AS APPROVED BY OBSERVING WETLAND SPECIALIST. B) INVASIVE PLANT SHALL BE CUT ABOVE THE ROOT AND HERBICIDE APPLIED USING A FOAM APPLICATOR SATURATED WITH THE CHOSEN GLYPHOSATE BASED HERBICIDE ALLOWING A TARGETED APPLICATION WITH LESS RISK OF IMPACT TO DESIRABLE PLANTS. C) CUT PLANTS SHALL BE PLACED IN BLACK PLASTIC BAGS, REMOVED FROM SITE AND DISPOSED OF IN ACCORDANCE WITH LOCAL AND STATE REGULATIONS.

WETLAND RESTORATION AND PLANTING PLAN:

DEBRIS, TRASH AND DUMPED LANDSCAPING REFUSE SHALL BE REMOVED FROM WETLAND VICINITY, LIMITS AS IDENTIFIED ON PLAN. ADDITIONAL NATIVE SPECIES AS WELL AS REPLACEMENT SHRUBS AND PLANTINGS SHALL BE PLACED WITHIN SAME LIMITS, SPECIES AND SPACING AS INDICATED IN SCHEDULE BELOW:

SWEET PEPPERBUSH (CLETHRA ALNIFOLIA) 2 - 3' 10' (AROUND PROMINENT TREES) 2 - 3' 10' (AROUND PROMINENT TREES) WINTERBERRY (ILEX VERTICILLATA)


HERBACEOUS PLANTS:

SENSITIVE FERN (ONOCLEA SENSIBILIS) 1 - 2' 4' - 6' (LOW LAYING WET AREAS) (OSMUNDA CINNAMONEA) 1 - 2' 4' - 6' (LOW LAYING WET AREAS) CINNAMON FERN

NEW ENGLAND WETMIX (OR EQUAL) 1 LB/10,000 SF


ALL SEED MIXES CAN BE PURCHASED FROM: NEW ENGLAND WETLAND PLANTS 413-548-8000

3. PLANTING WITHIN WETLAND AREA IS LIMITED TO THE MONTHS OF APRIL THROUGH OCTOBER.

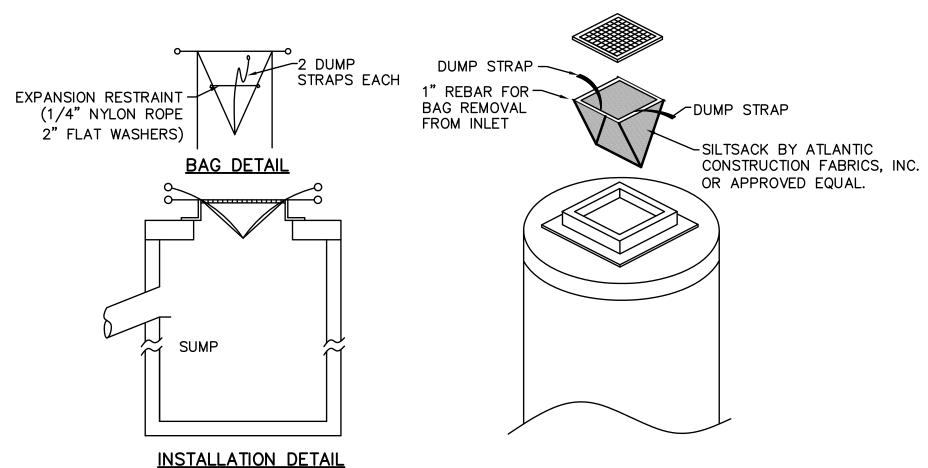

- 1. SILT SACKS SHALL BE INSTALLED IN ALL CATCH BASINS DURING CONSTRUCTION PERIOD. 2. INSPECTION SHALL BE WEEKLY AND REPAIR/REPLACEMENT MADE PROMPTLY AS NEEDED.
- 3. SILT SACKS SHALL BE KEPT CLEAN AND FREE OF DEBRIS.

SILTSACK DETAIL

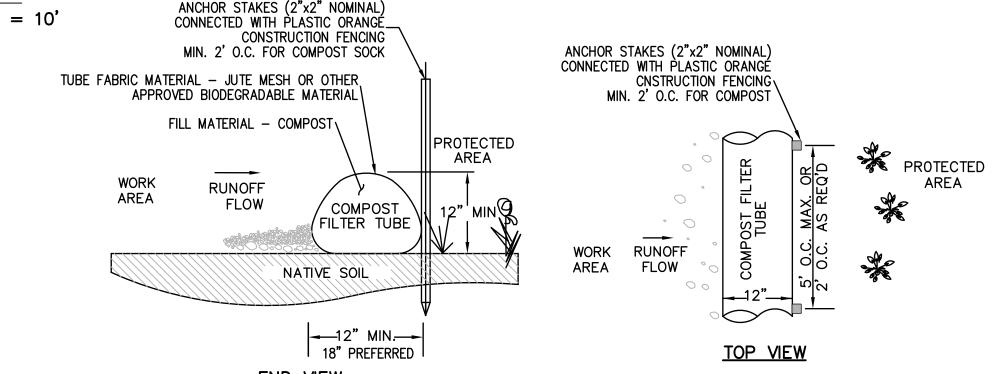


OF 3/4" CRUSHED STONE

ENSURE PROPER LOCATION AT SITE FOR EFFECTIVENESS. TUBES SHALL BE PLACED AND STAKED IN PLACE AS REQUIRED TO ENSURE STABILITY AGAINST WATER FLOWS. TUBES FILLED WITH LIGHT MATERIAL SHALL BE STAKED AT A MAXIMUM OF 2 FEET ON CENTER. FOR HEAVIER MATERIAL, 5 FEET ON CENTER.


TUBES SHALL BE TAMPED TO ENSURE GOOD CONTACT WITH SOIL. INSPECT AFTER EACH RAINFALL OR DAILY DURING RAINFALL EVENTS. CORRECT ALL DEFICIENCIES IMMEDIATELY.

FAILURE INCLUDES BUT IS NOT LIMITED TO WASHOUT, OVERTOPPING, CLOGGING, AND EROSION. IF OVERTOPPING OR WASHOUT OCCURS, NEW FILTER TUBES WITH ADDITIONAL STAKING OR STRAW MATERIAL SHALL BE INSTALLED AS DIRECTED BY THE ENGINEER. FILTER TUBES SHALL BE REMOVED ONCE SITE WORK IS COMPLETE, SITE IS STABLE, ADEQUATE GROWTH HAS BEEN ESTABLISHED AND AS

DIRECTED BY THE ENGINEER. TUBE FABRIC SHALL BE CUT, REMOVED AND DISPOSED OF OFF-SITE BY THE CONTRACTOR AT NO ADDITIONAL

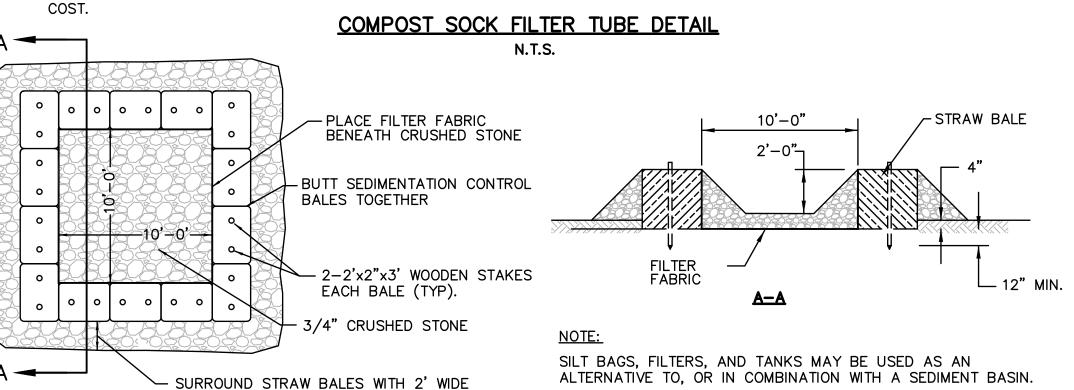

SEDIMENTATION CONTROL SYSTEM FOR ONSITE DEWATERING

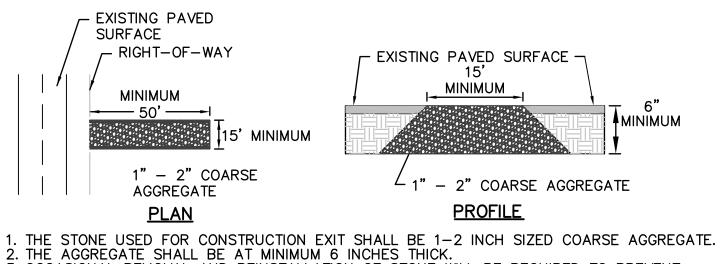

5. OCCASIONAL REMOVAL AND REINSTALLATION OF STONE WILL BE REQUIRED TO PREVENT TRACKING OF SEDIMENT ONTO PAVED ROADS.

CONSTRUCTION EXIT

4. CONSTRUCTION EXIT SHALL EXTEND 50' ONTO PROPERTY.

N.T.S. "U" SHAPED WIRE STAPLES, MANUFACTURED BY CLOVE FOUR-SLIDE & STAMPING CO. 0.091" DIA. OR GREATER W/6" LEGS AND 1" CROWN FINISH GRADE -4 STAPLES --STAPLE @ 6' INTERVALS ACROSS ROLL ALONG LENGTH OF ROLL SLOPE CREST EXISTING GRADE PROPOSED GRADE -NOTE: USE COMMON ROW OF STAPLES ON ADJOINING BLANKETS

EROSION CONTROL BLANKET DETAIL

PROPOSED EROSION CONTROL & CONSERVATION PLAN

GRANITE POST

N.T.S.

TOP VIEW

GRANITE POST

−3"ø METAL PLAQUE

- 6"x6" GRANITE POST

FINISHED GRADE

- SELECT BACKFILL

PER WESTWOOD

CONSERVATION

COMMISSION


6"x6"


ISLINGTON VILLAGE WESTWOOD, MA NORFOLK COUNTY

8 4/25/18 PLANNING/ BETA/ CONS. COMM. S.B.H 7 4/6/18 PLANNING/ BETA/ CONS. COMM. S.B.H. MICHAEL J. 6 3/30/18 PLANNING/ BETA/ CONS. COMM. S.B.H. CARTÉR 5 3/8/18 PLANNING/ BETA COMMENTS S.B.H. CIVIL No. 35907 4 3/6/18 PLANNING/ BETA COMMENTS S.B.H 3 2/7/18 PLANNING/ BETA COMMENTS S.B.H 2 2/1/18 PLANNING/ BETA COMMENTS 1 1/2/18 CONSERVATION - NOI S.B.H. 4/25/18 NO. DATE DESCRIPTION


GCG ASSOCIATES, INC.

SELLE ON	WILMINGTON	N	MASSACHUSETTS
STI	SCALE: N.T.S.		ECEMBER 12, 2017
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	1753-COVER_DETAILS	DRAWN BY: S.B.H. CHECKED BY: M.J.C.	C-12 of 20

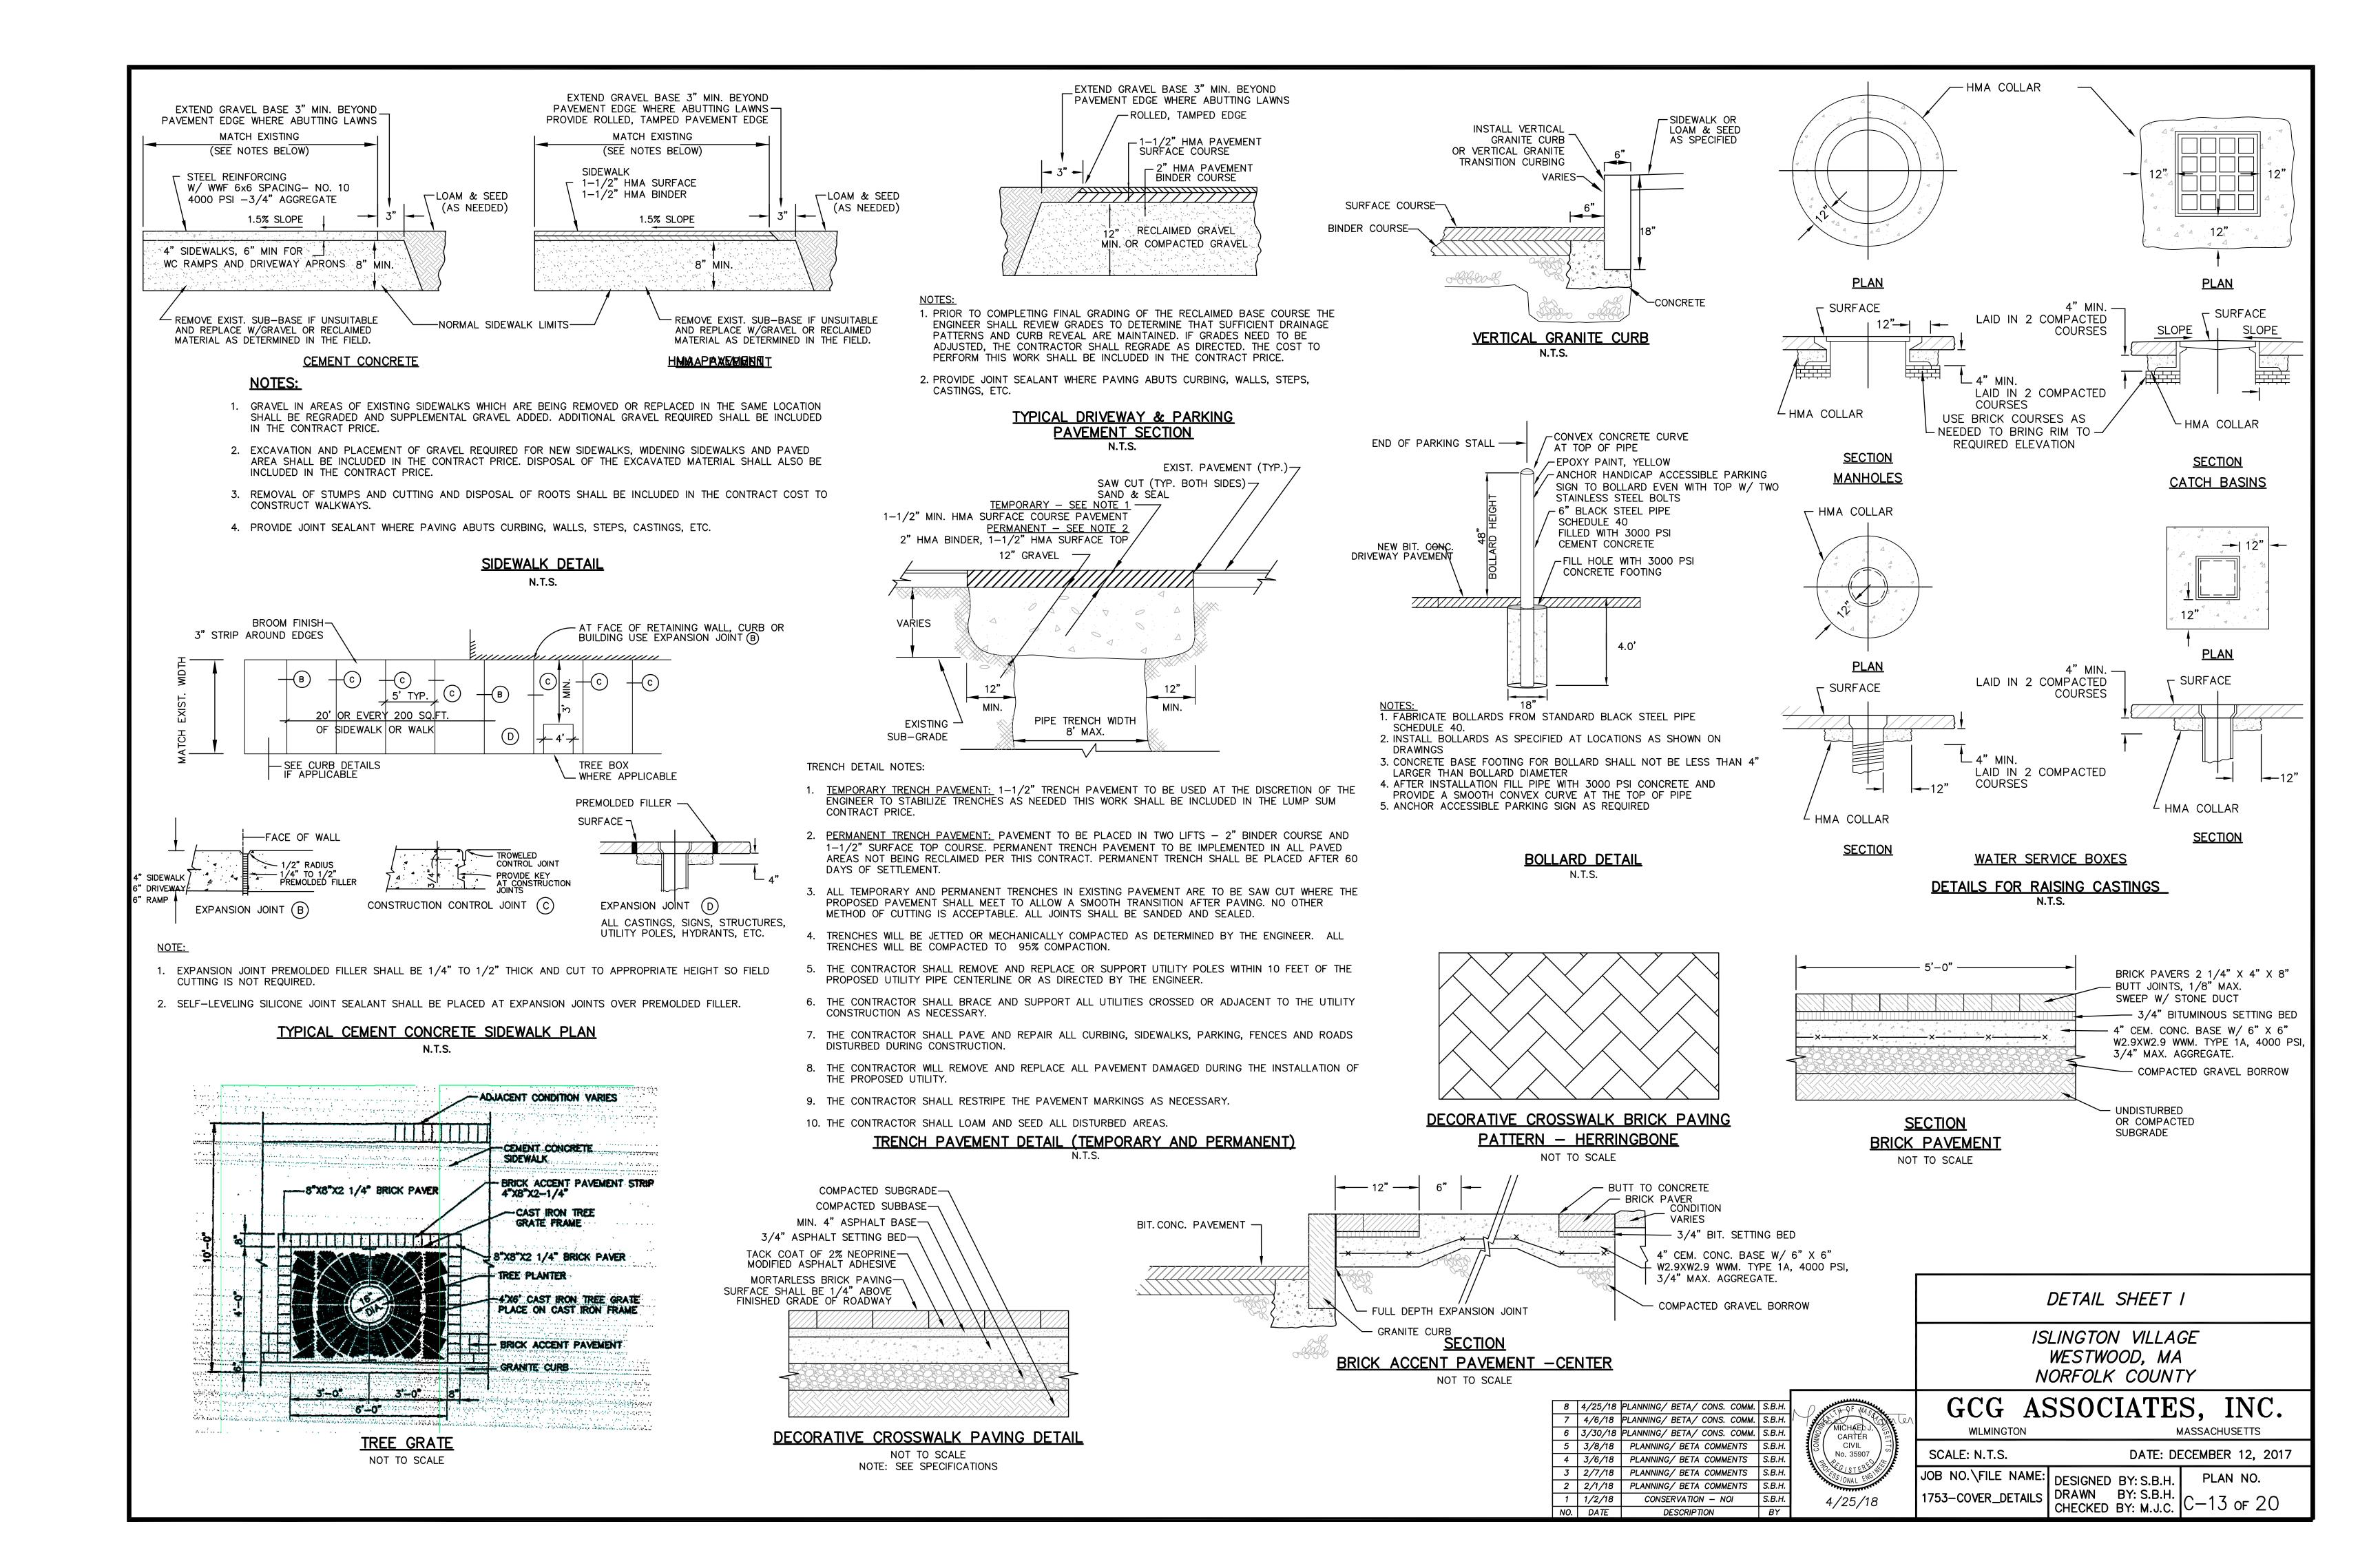

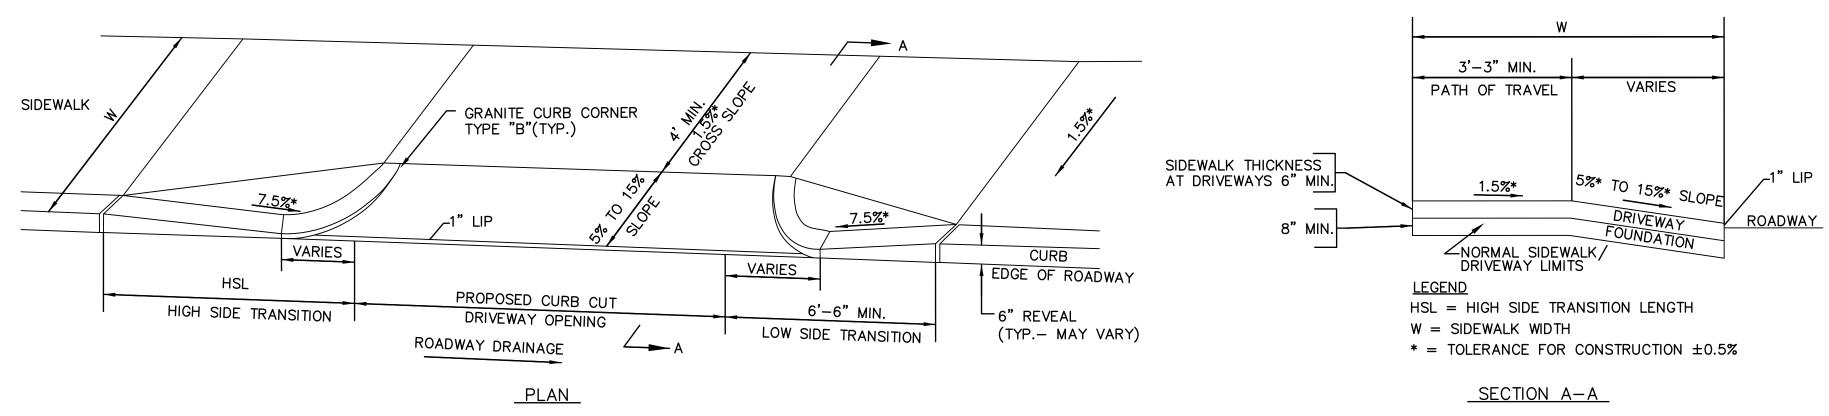

TYPICAL CURB CUT DRIVEWAY AT TOWN SIDEWALK

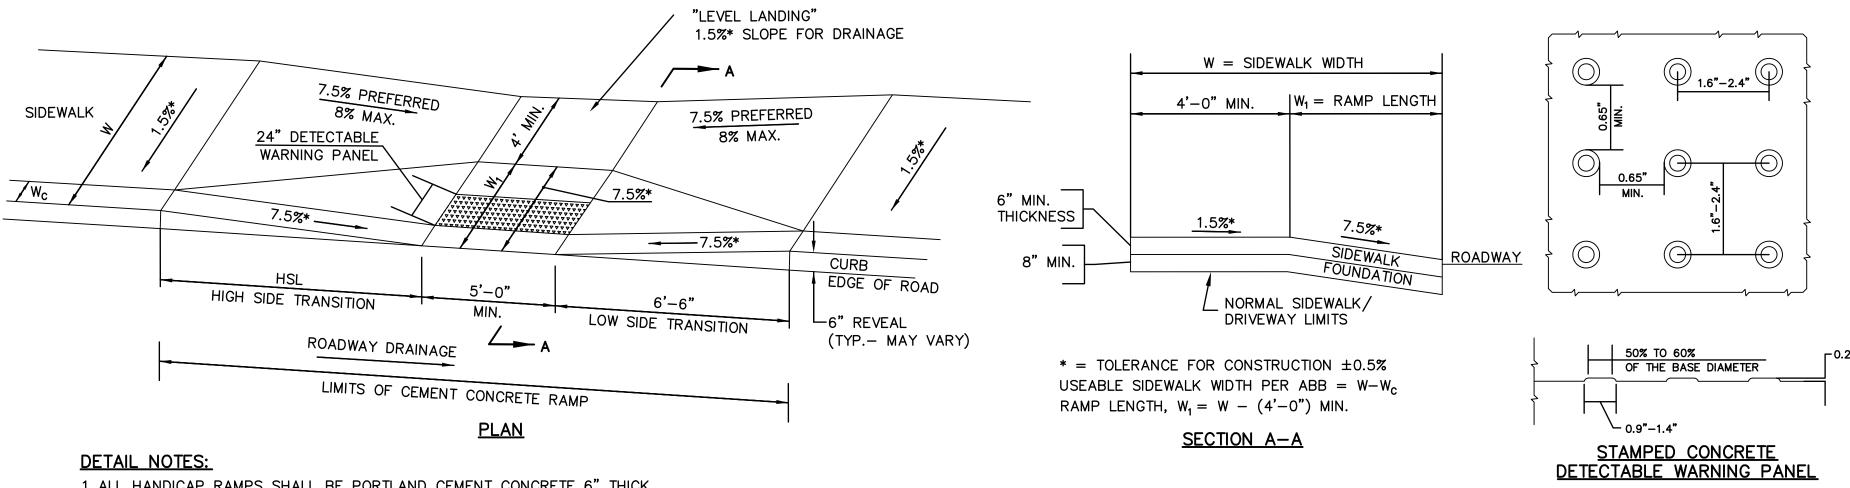

1. ALL HANDICAP RAMPS SHALL BE PORTLAND CEMENT CONCRETE 6" THICK.

- 2. CURBING FOR ALL CONCRETE RAMPS SHALL BE VERTICAL GRANITE CURB.
- 3. THE DIMENSIONS SHOWN AT ROADWAY EDGE ARE FIXED DISTANCES.
- 4. RAMP CROSS SECTION TO BE SAME AS ADJACENT SIDEWALK; e.g DEPTH OF
- 5. PORTLAND CEMENT CONCRETE RAMPS ARE TO BE TEXTURED BY BROOMING IN A DIRECTION PARALLEL TO THE LENGTH OF THE RAMP.
- 6. THESE DIMENSIONS ARE SUBJECT TO CHANGE IN THE FIELD IF EXISTING APPURTENANCES OR CONDITIONS WILL MAKE THE RAMP LOCATIONS IMPRACTICAL

ROADWAY PROFILE GRADE %	*HIGH SIDE TRANSITION LENGTH
0	6'-6"
> 0 - 1	7'-8"
> 1 - 2	9'-0"
> 2 - 3	11'-0"
> 3 - 4	14'-0"
> 4	15'-0" MAX.

* BASED ON DESIGN SLOPE = 7.5% AND A CURB REVEAL OF 6". **CURB TRANSITION LENGTH**

FOR WHEELCHAIR RAMPS


WHEELCHAIR RAMP NOTES

- ROADWAY SIDEWALK CROSS SLOPES, FOR BRICK, CEMENT CONCRETE, AND HMA, AS INDICATED IN THE STANDARD SPECIFICATIONS, WILL BE 1.5%. A CONSTRUCTION TOLERANCE OF ±0.5% IS ACCEPTABLE ON ROADWAY SIDEWALKS. IN ACCORDANCE WITH 521 CMR THE RULES AND REGULATIONS OF THE ARCHITECTURAL ACCESS BOARD (AAB), THE SIDEWALK CROSS SLOPE CANNOT EXCEED 2.0%.
- AN UNOBSTRUCTED PATH OF TRAVEL WITH A MINIMUM WIDTH OF 3'-3" SHALL BE MAINTAINED PAST ALL OBSTRUCTIONS (UTILITY POLES, SIGNS, SIGNAL FOUNDATIONS AND MASTS, MAILBOXES, ALONG DRIVE OPENINGS, ETC.).
- 3. THE WHEELCHAIR RAMP SLOPES AND SIDE SLOPES (TRANSITIONS) WILL BE 7.5% WITH A CONSTRUCTION TOLERANCE OF $\pm 0.5\%$. HOWEVER, THESE SLOPES MAY BE FLATTER WHEN WARRANTED BY SURROUNDING CONDITIONS.
- 4. IF THE ROAD PROFILE EXCEEDS 4%, THE HIGH SIDE TRANSITION LENGTH UNDER ANY CONDITIONS NEED NOT EXCEED 15'.
- 5. IN NO CASE WHERE A STOP LINE IS WARRANTED, SHALL A RAMP BE PLACED ON THE TRAFFIC APPROACH SIDE OF THAT STOP LINE.
- 6. FIXED OBJECTS (I.E. UTILITY POLES, HYDRANTS, SIGNS, SIGNAL FOUNDATIONS, ETC.) MUST NOT ENCROACH UPON ANY PART OF THE WHEELCHAIR RAMP INCLUDING TRANSITION SLOPES.
- 7. AT NO TIME IS ANY PART OF THE WHEELCHAIR RAMP, EXCLUDING CURB TRANSITIONS, TO BE LOCATED OUTSIDE THE CROSSWALK OR PEDESTRIAN TRAVEL PATH. THE WHEELCHAIR RAMP ENTRANCE IS TO BE CENTERED IN THE CROSSWALK OR PEDESTRIAN TRAVEL PATH WHENEVER POSSIBLE.
- 8. CATCH BASINS WHICH ARE IN THE VICINITY OF A WHEELCHAIR RAMP SHALL BE LOCATED UPGRADE OF THE RAMP ENTRANCE.
- 9. THE ENTRANCE OF A WHEELCHAIR RAMP SHALL BE FLUSH WITH THE ROADWAY.
- 10. TESTING SURFACE: WHEN TESTING WITH A STRAIGHTEDGE PLACED PARALLEL TO THE LINE OF THE SLOPE THERE SHALL BE NO DEVIATION FROM A TRUE SURFACE IN EXCESS OF 1/4".
- 11. SIDEWALK CONSTRUCTION SHALL BE IN CONFORMANCE WITH MASS HIGHWAY CONSTRUCTION STANDARDS FOR WHEELCHAIR RAMPS.

TYPICAL WHEELCHAIR RAMP CONDITION


N.T.S. — 3/8" HOLES FOR REBAR 1' FROM EACH END OR PER MANUFACTURERS SPECS. EDGE OF PARKING STALL, CENTER ON SPACE (1 FEET LONG MIN.)

TYPICAL YELLOW POLYMER WHEEL STOP DETAIL

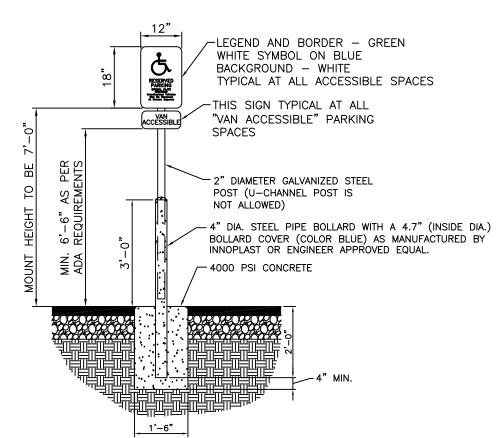

N.T.S.

BOLLARD MOUNTED SIGN DETAIL

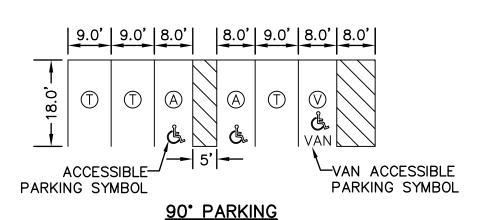


A - ACCESSIBLE PARKING SPACE

T - TYPICAL PARKING SPACE V - VAN ACCESSIBLE PARKING SPACE

- 1. TYPICAL PARKING SPACE DIMENSIONS TO CORRESPOND WITH TOWN OF WESTWOOD, MASSACHUSETTS, PARKING DESIGN STANDARDS.
- 1. VAN ACCESSIBLE SPACES MUST HAVE AN 8' WIDE ACCESS AISLE.
- 2. ALL OTHER ACCESS AISLES SHALL BE 5' WIDE, MINIMUM.

- 3. TYPICAL PARKING STALLS SHALL BE 9' WIDE UNLESS NOTED ON THE
- 4. ACCESSIBLE SPACES AND AISLES 2% MAX SLOPE IN ANY DIRECTION TYPICAL LINE STRIPING DETAIL

NOT TO SCALE

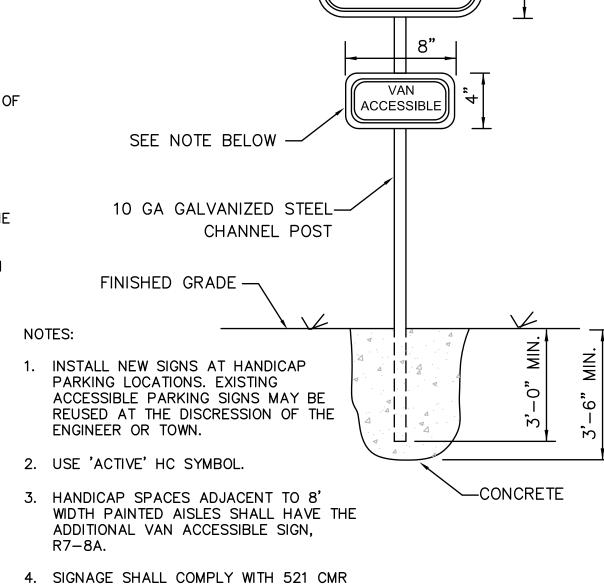


DETAIL SHEET II

R7-8

RESERVED

PARKING

23.6. SUCH SIGN SHALL BE NO LESS THAN FIVE FEET NOR MORE THAN EIGHT FEET TO THE TOP OF THE SIGN. HANDICAP SIGN AND FOOTING DETAIL

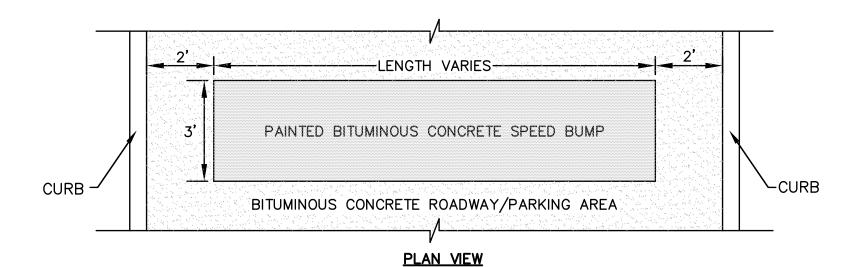



MAX. SLOPE BIT. CONC. SPEED BUMP -3' WIDE 1-1/2" TOP COURSE-2" BASE COURSE-TACK COAT SURFACE -SAW CUT & REMOVE TOP COURSE $^{\sim}$ <u>SECTION</u>


> 1. BITUMINOUS CONCRETE SPEED BUMP TO BE INSTALLED AFTER TOP COURSE. 2. SAW CUT AND REMOVE TOP COURSE AT LOCATION OF THE SPEED BUMP. 3. BEFORE INSTALLING THE SPEED BUMP, INSTALL TACK COAT. SPEED BUMP DETAIL

> > NOT TO SCALE


					ISLINGTON VILLAGE WESTWOOD, MA NORFOLK COUNTY				
8 7 6	4/6/18	PLANNING/ BETA/ CONS. COMM. PLANNING/ BETA/ CONS. COMM. PLANNING/ BETA/ CONS. COMM.	S.B.H.	MICHAEDJ.	GCG WILMINGTO		SSOCIATE		INC.
5 4	3/8/18 3/6/18	PLANNING/ BETA COMMENTS PLANNING/ BETA COMMENTS	S.B.H. S.B.H.	CIVIL No. 35907	SCALE: N.T.S.		DATE: D	ECEME	BER 12, 2017
3 2	2/7/18 2/1/18 1/2/18	PLANNING/ BETA COMMENTS PLANNING/ BETA COMMENTS CONSERVATION - NOI	S.B.H. S.B.H. S.B.H.	OS JONAL ENGLAND	JOB NO.\FILE N		DESIGNED D1. 3.D.11.		AN NO.
NO.	 ' ' 	DESCRIPTION	BY	4/25/18	1733-COVEN_DE	IAILS	DRAWN BY: S.B.H. CHECKED BY: M.J.C.	C-1	4 of 20

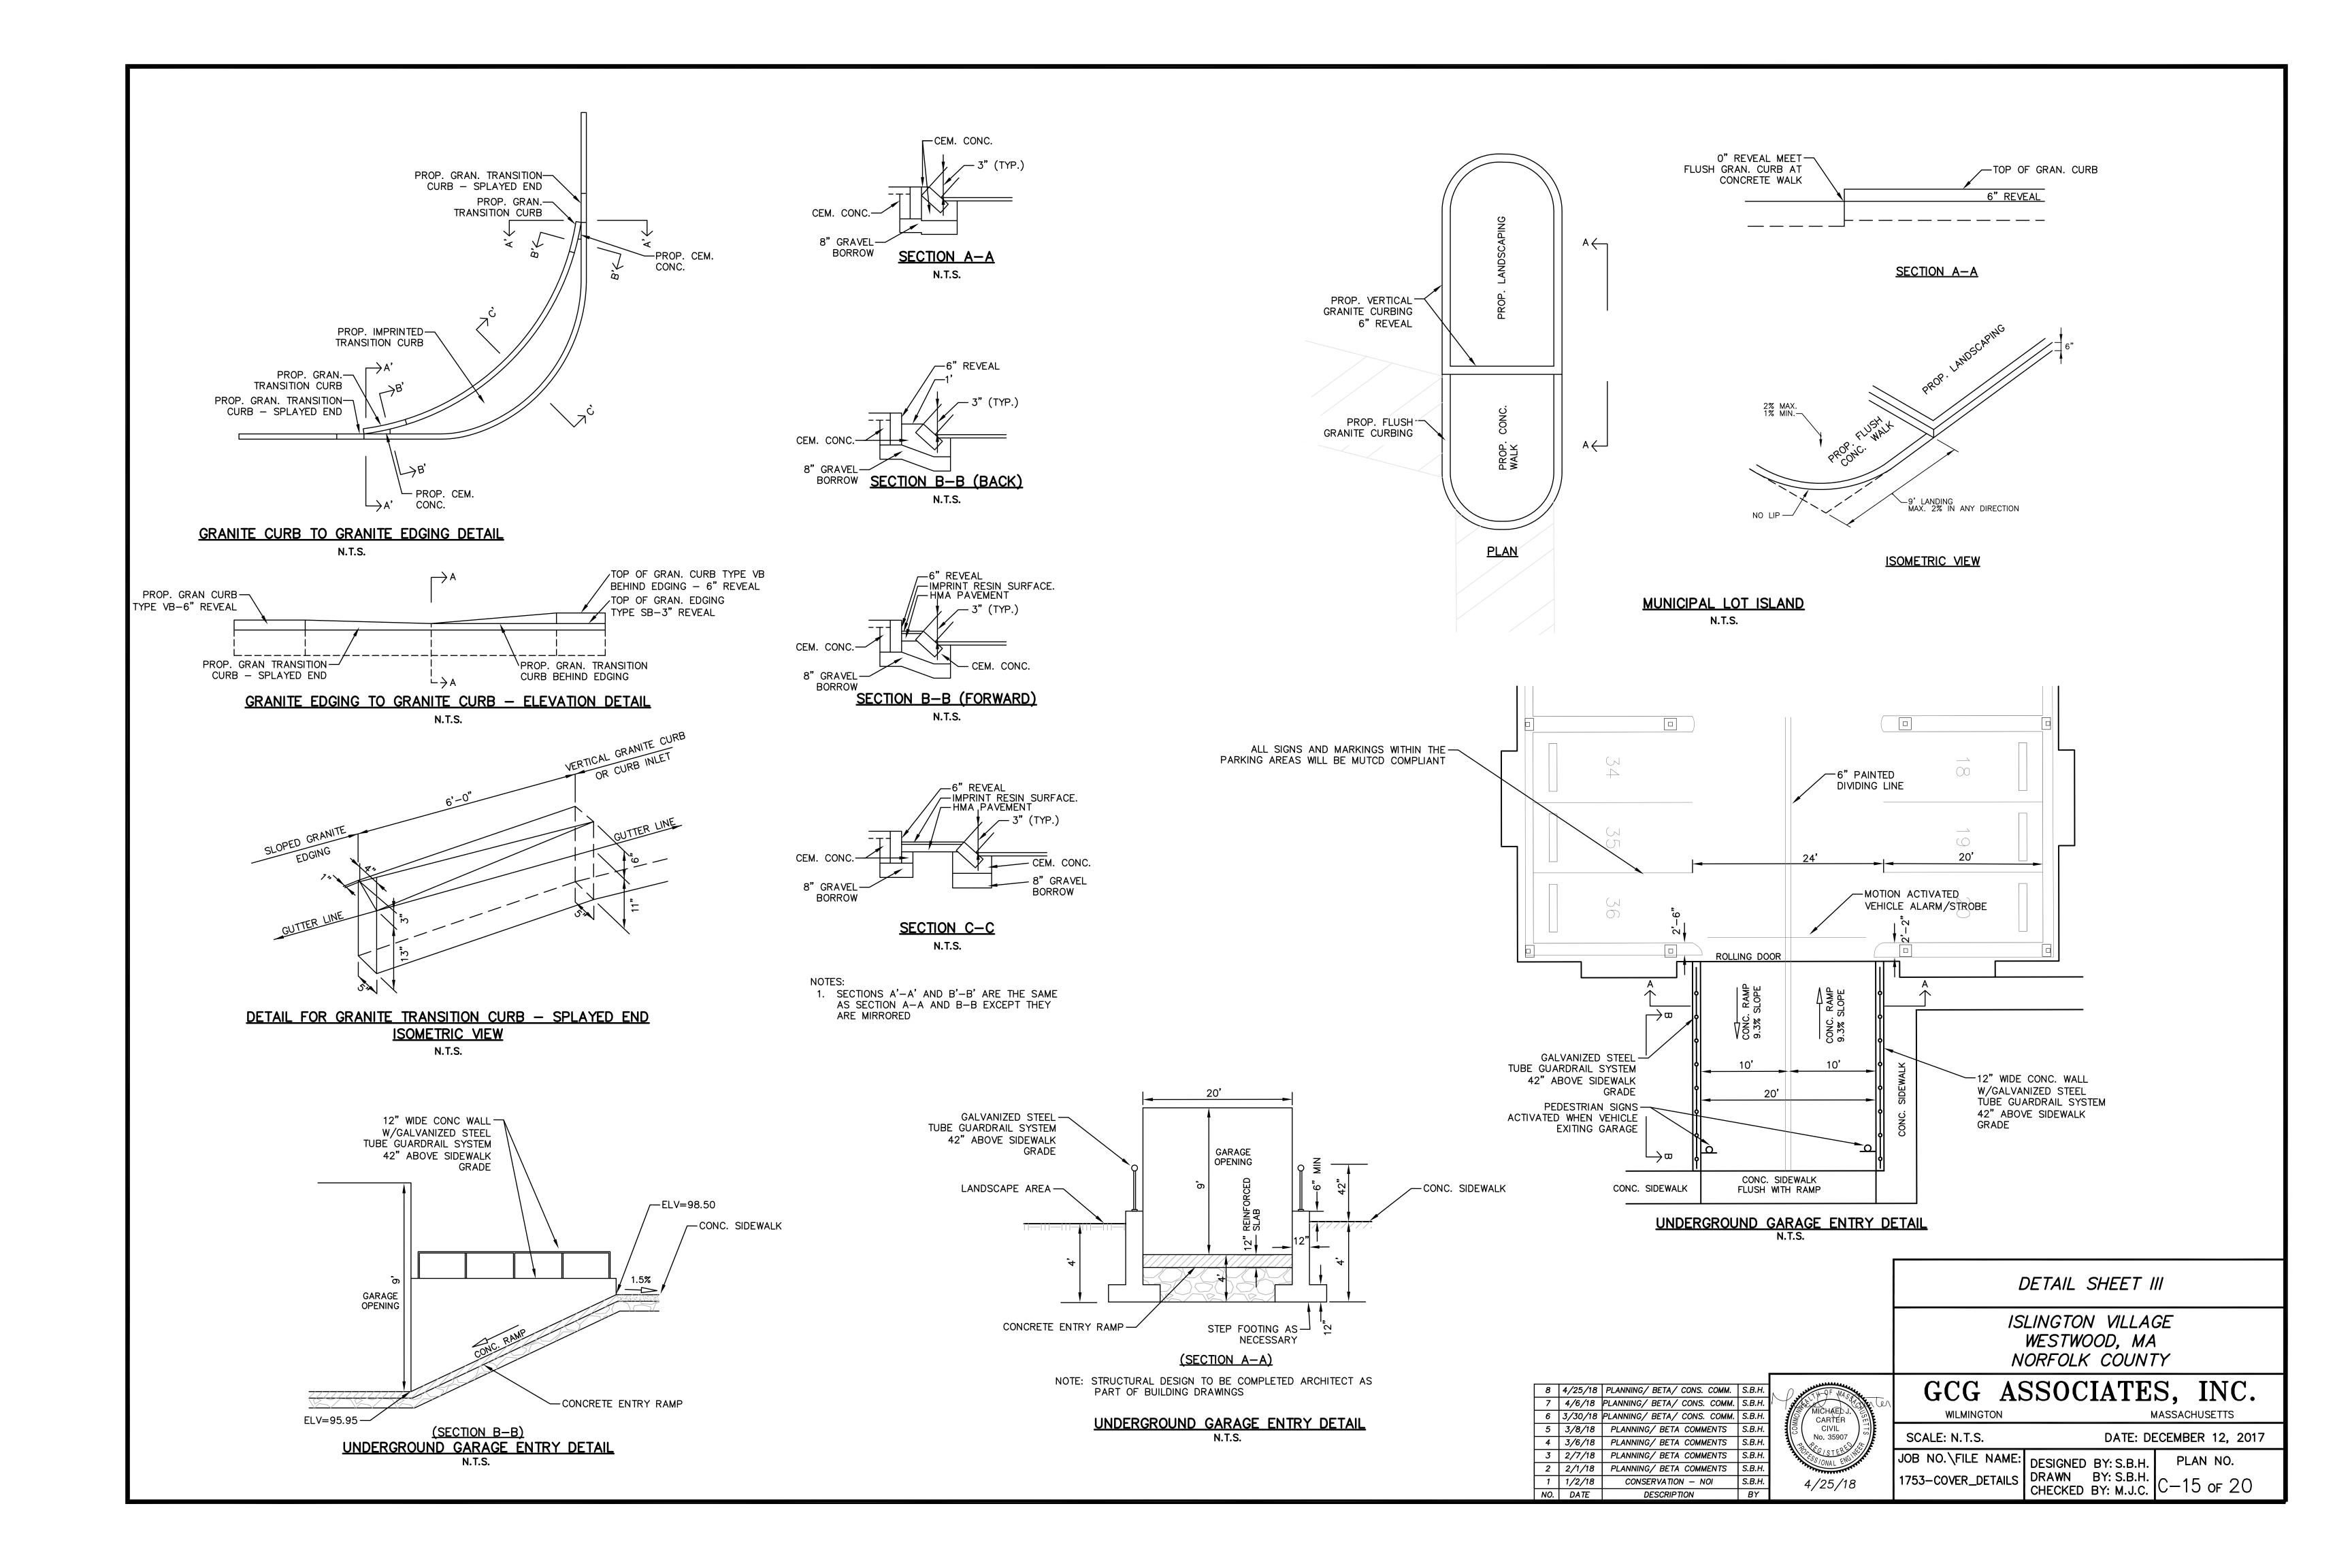

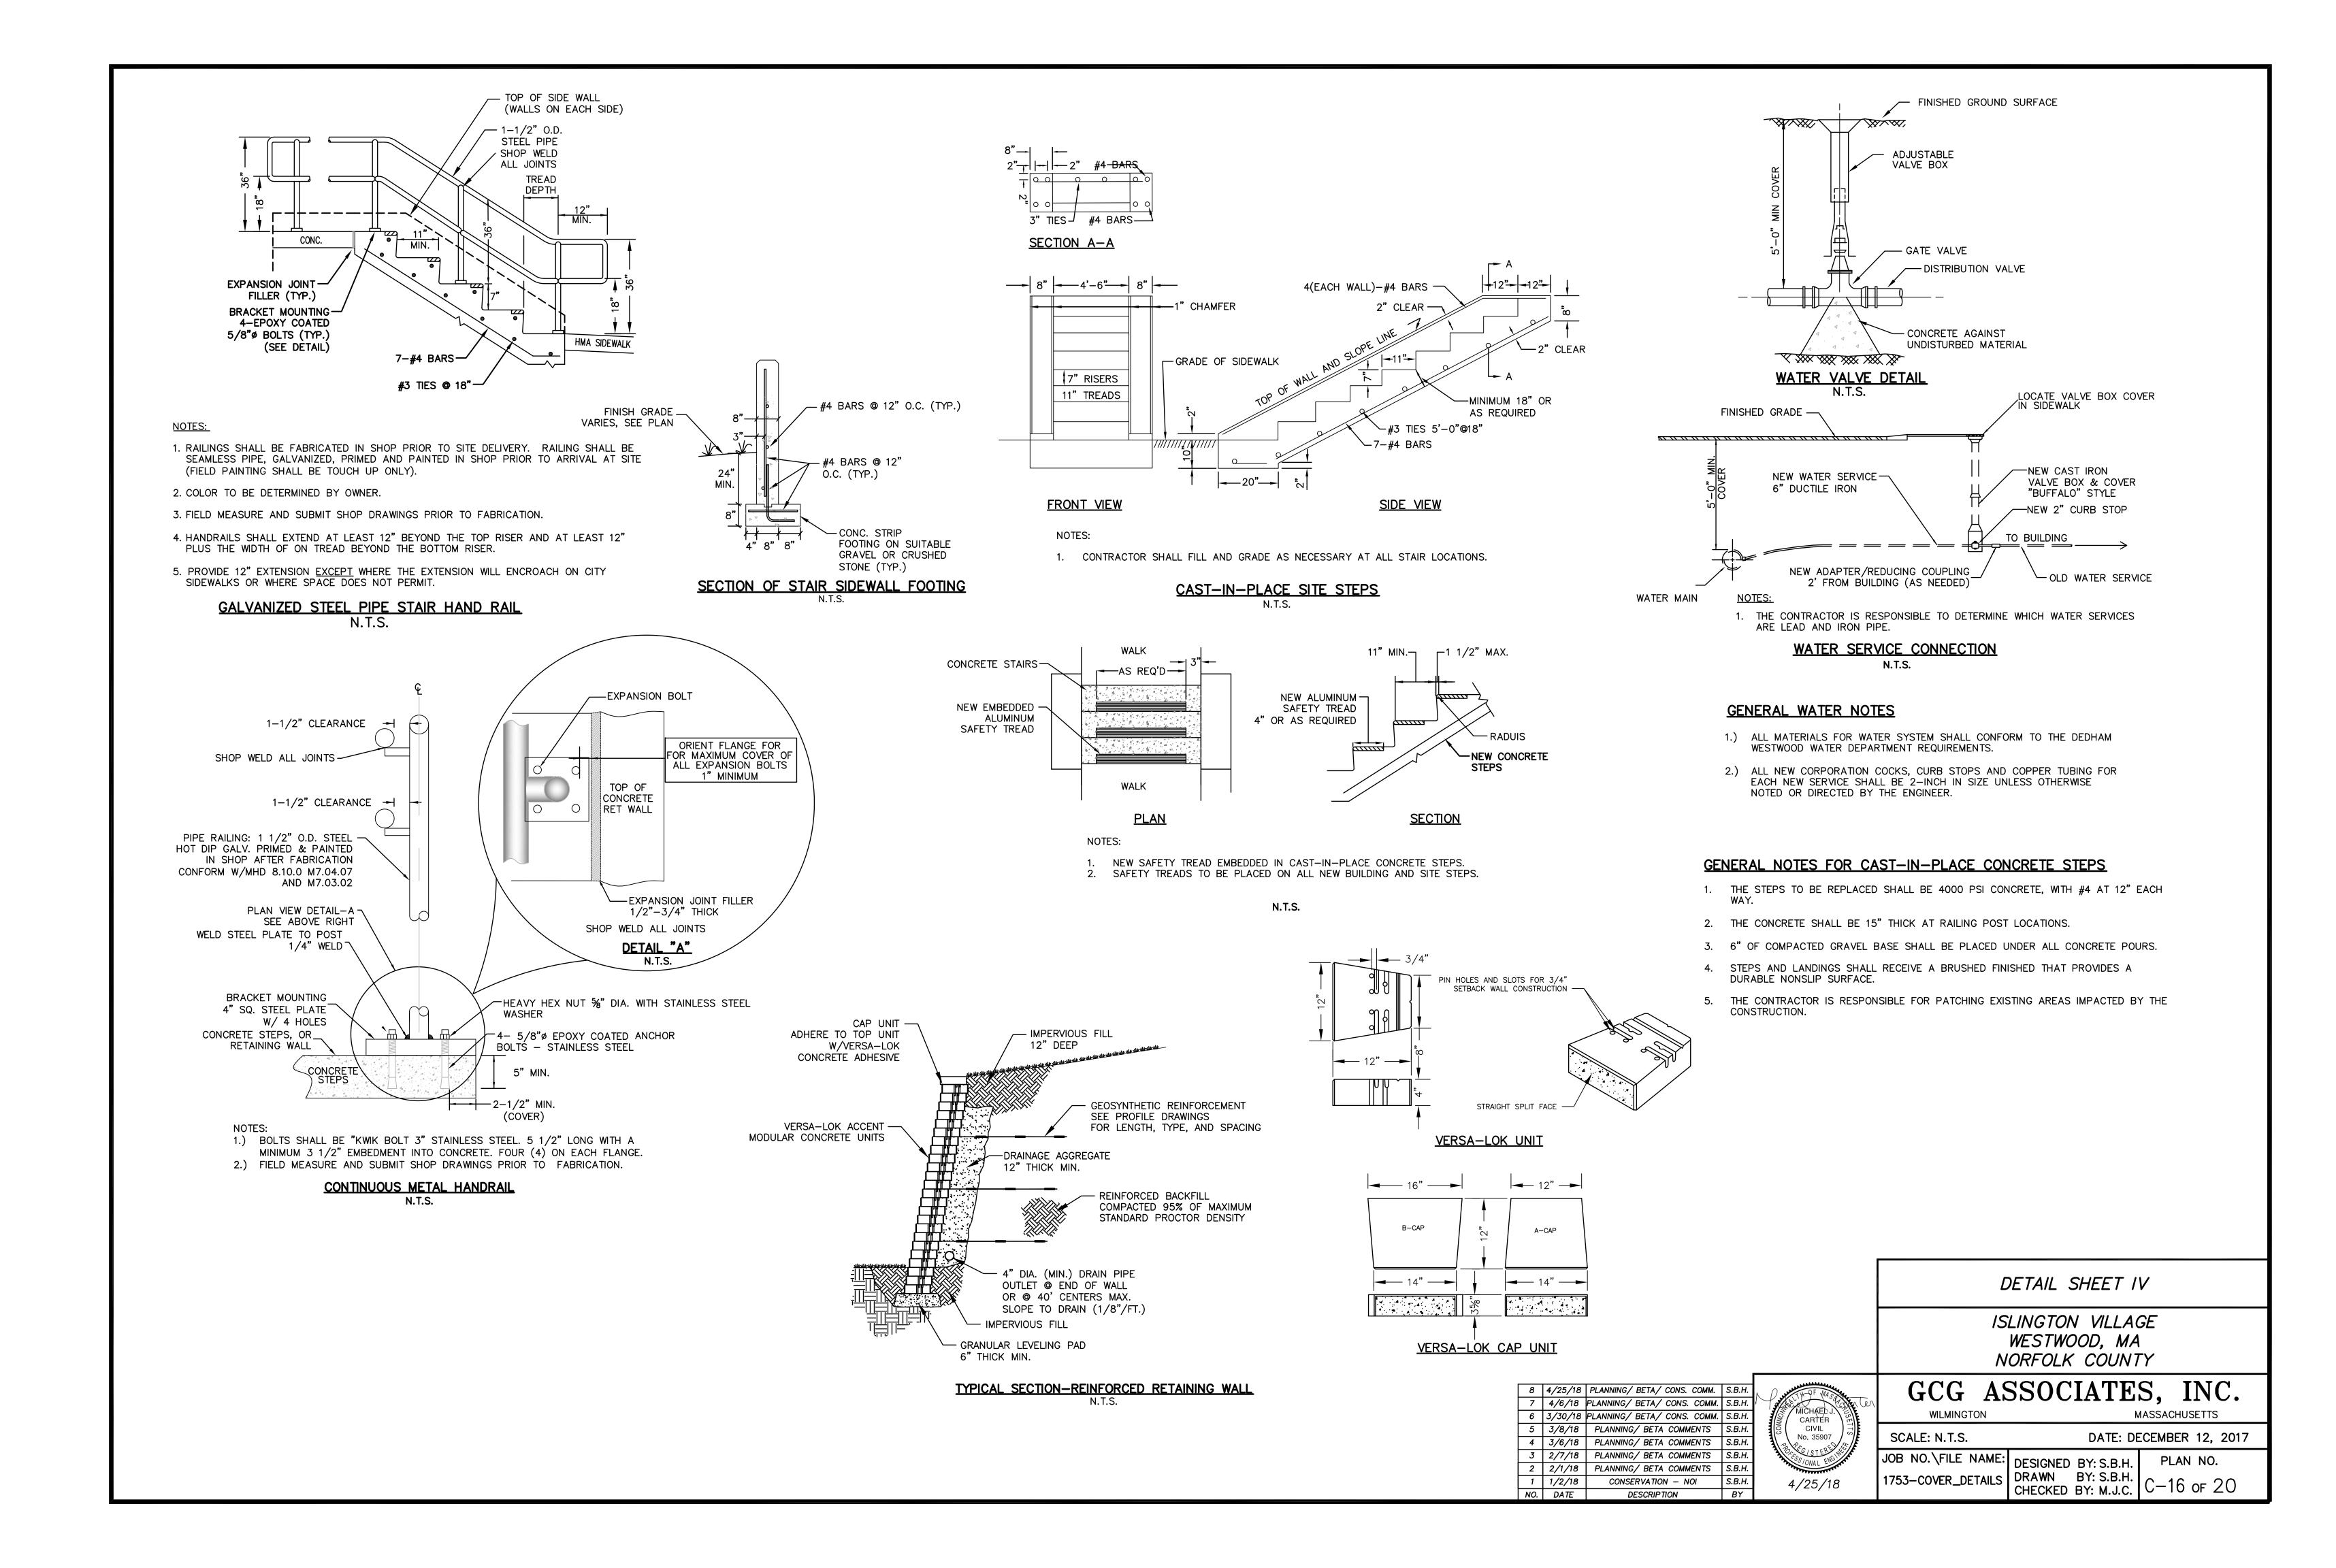

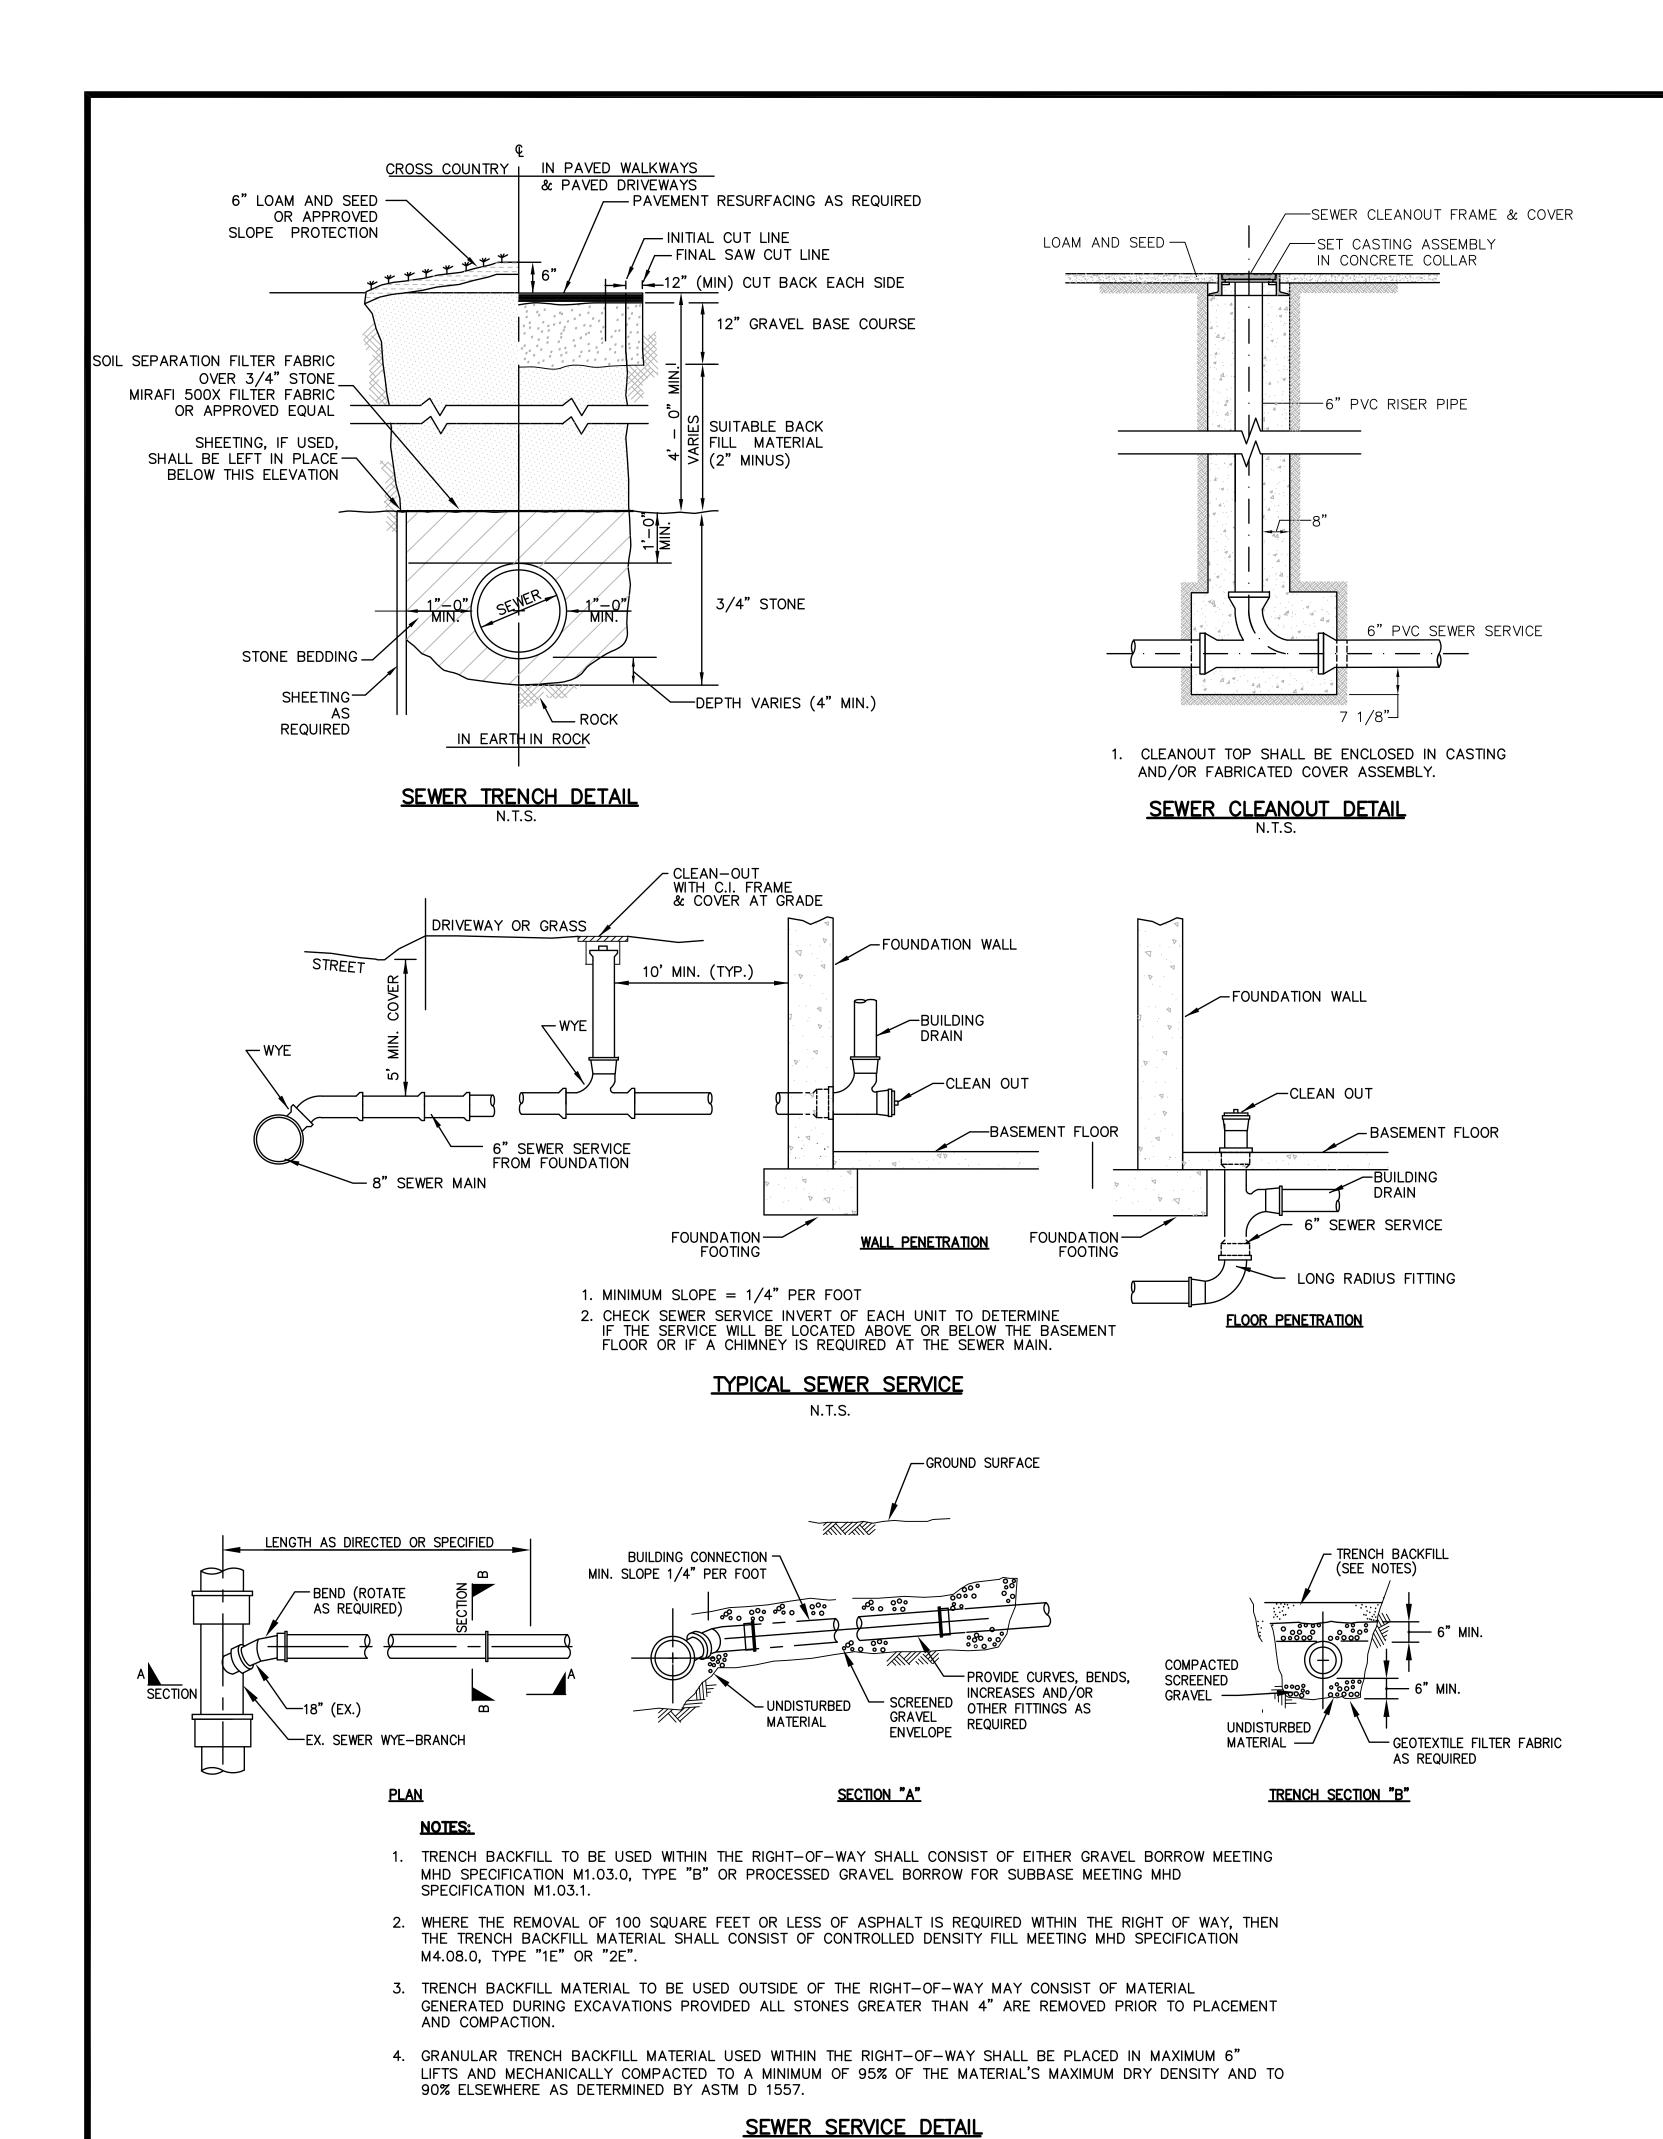


N.T.S.

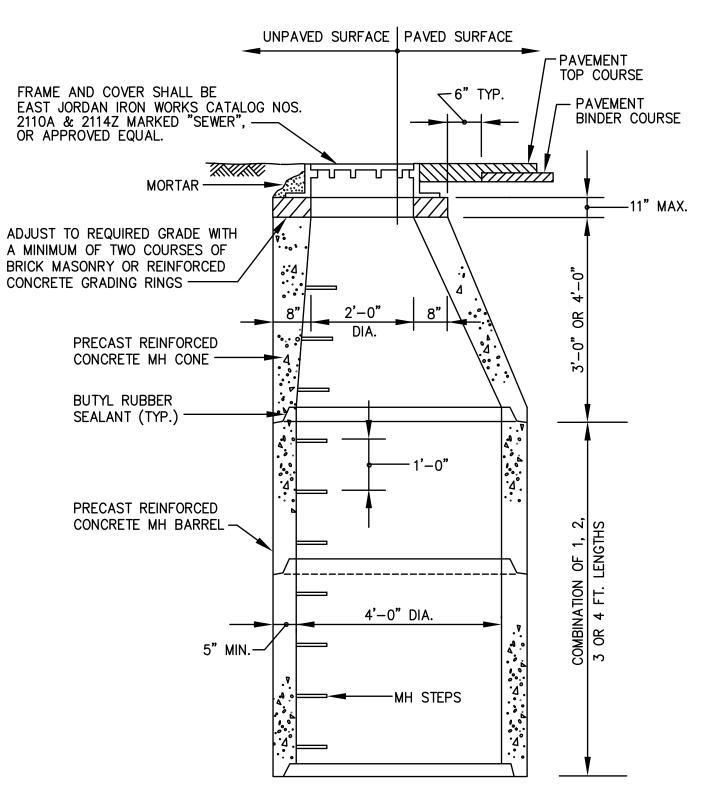

ALL EXTERIOR SURFACES OF MANHOLE GRADE ADJUSTMENT COURSES SHALL BE COVERED WITH 1/4" TO 3/8" MASONRY CEMENT PLASTER. SEWER MANHOLE DETAIL

N.T.S.

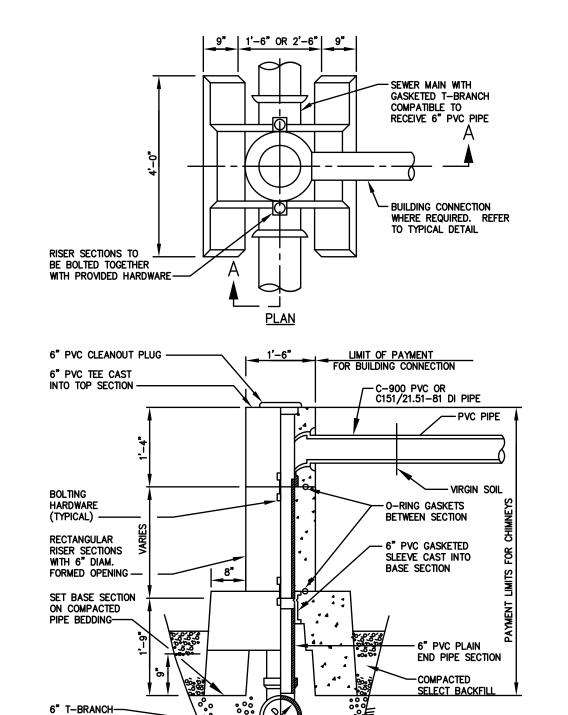

PRECAST REINFORCED CONCRETE SEWER CHIMNEY N.T.S.


SECTION A-A

- COMPACTED 3/4" CRUSHED STONE (M2.01.4)

NO. DATE


UNDISTURBED

CHIMNEYS ARE REQUIRED FOR DROPS

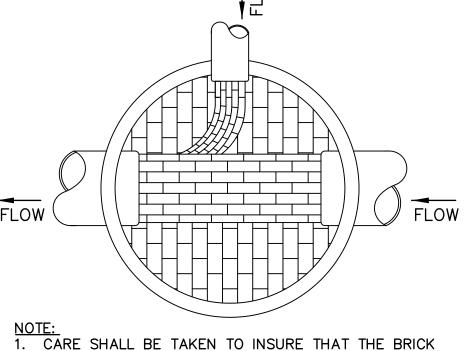

INVERT IS A SMOOTH CONTINUATION OF THE SEWER INVERT. INVERT BRICKS SHALL BE LAID ON EDGE. 2. INVERT AND SHELF TO BE PLACED AFTER VACUUM TEST.

SECTION B-B **SEWER MANHOLE PLAN** NOT TO SCALE

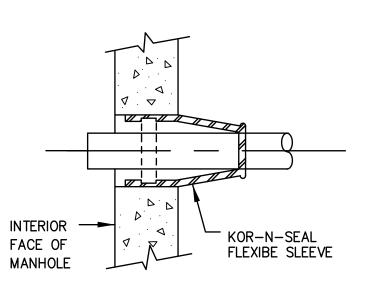

PIPE CONNECTION DETAIL

GENERAL SEWER NOTES

CONFORMANCE WITH ASTM D-3034.

- 1.) ALL MATERIALS FOR SEWER SHALL CONFORM TO THE TOWN OF WESTWOOD SEWER DEPARTMENT REQUIREMENTS.
- 2.) PROPOSED SEWER SERVICES ARE SHOWN IN THEIR APPROXIMATE LOCATION. THE EXACT LOCATION OF EACH SEWER SERVICE WILL BE DETERMINED BY THE ENGINEER AFTER TEST PITS ARE COMPLETED.
- 3.) THE CONTRACTOR SHALL BE RESPONSIBLE TO DETERMINE THE LOCATION OF THE EXISTING SEWER SERVICES AT FOR CONNECTION TO THE PROPOSED SEWER.
- 4.) ALL NEW GRAVITY SANITARY SEWER PIPE AND FITTINGS SHALL BE PVC PIPE, SDR-35 IN
- 5.) EXISTING SEWERS SHALL BE PIPED THROUGH MANHOLES WHERE APPROPRIATE WITH TWO FERNCO COUPLINGS..
- 6.) SEWER MANHOLES, SEWER PIPE AND ALL OTHER SEWER/SEPTIC/SESPOOL COMPONENTS IN THE LOCATION OF ABANDONED SEWER EASEMENT ON ASSESSOR'S PARCEL 23-162 AS WELL AS ANY OTHER ABANDONED SEWER PIPE ON LOCUS PARCELS SHALL BE REMOVED AND DISPOSED OF IN ACCORDANCE WITH LOCAL AND STATE REGULATIONS.

DETAIL SHEET V

ISLINGTON VILLAGE WESTWOOD, MA NORFOLK COUNTY

MICHAEL J. CARTÉR CIVIL No. 35907

4/25/18


GCG ASSOCIATES, INC. WILMINGTON MASSACHUSETTS


SCALE: AS NOTED DATE: DECEMBER 12, 2017 JOB NO. FILE NAME: DESIGNED BY: S.B.H. PLAN NO. DRAWN BY: S.B.H. 1753-COVER_DETAILS CHECKED BY: M.J.C. | C-17 of 20

8 4/25/18 PLANNING/ BETA/ CONS. COMM. S.B.H 7 4/6/18 PLANNING/ BETA/ CONS. COMM. S.B.H. 6 3/30/18 PLANNING/ BETA/ CONS. COMM. S.B.H.

5 3/8/18 PLANNING/ BETA COMMENTS S.B.H 4 3/6/18 PLANNING/ BETA COMMENTS S.B.H 3 2/7/18 PLANNING/ BETA COMMENTS S.B.H 2 2/1/18 PLANNING/ BETA COMMENTS CONSERVATION - NOI 1 1/2/18 S.B.H.


DESCRIPTION

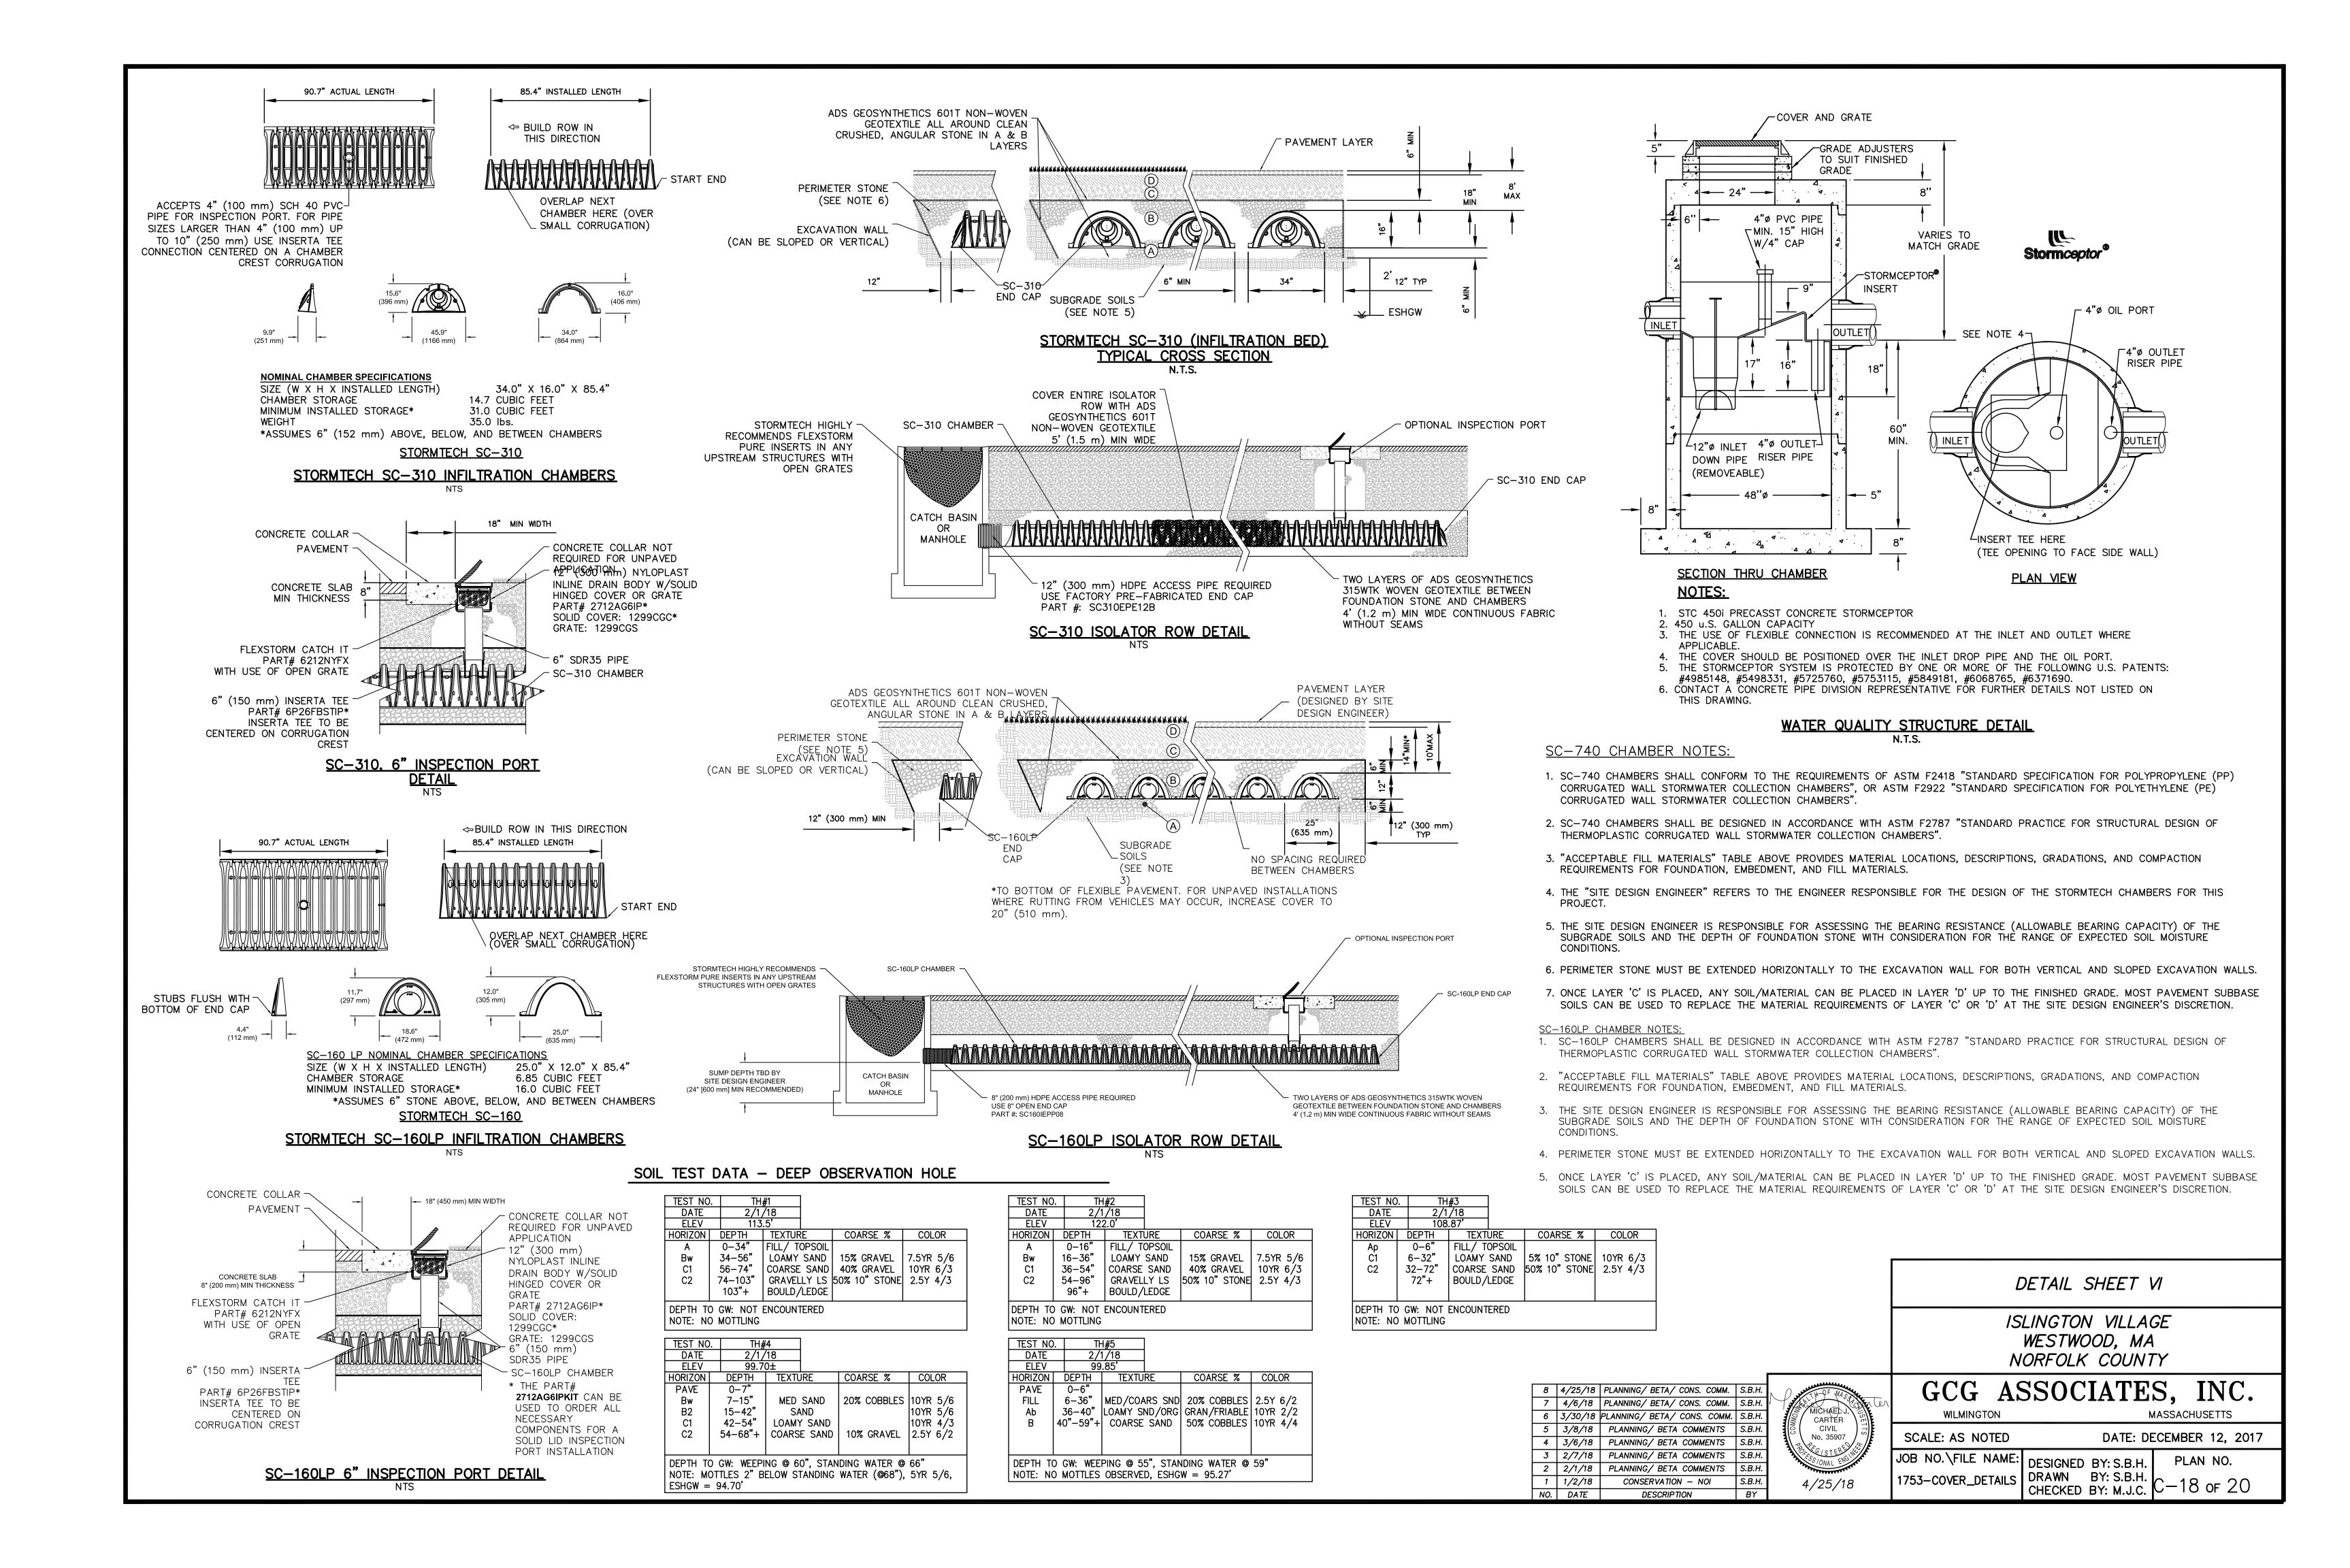

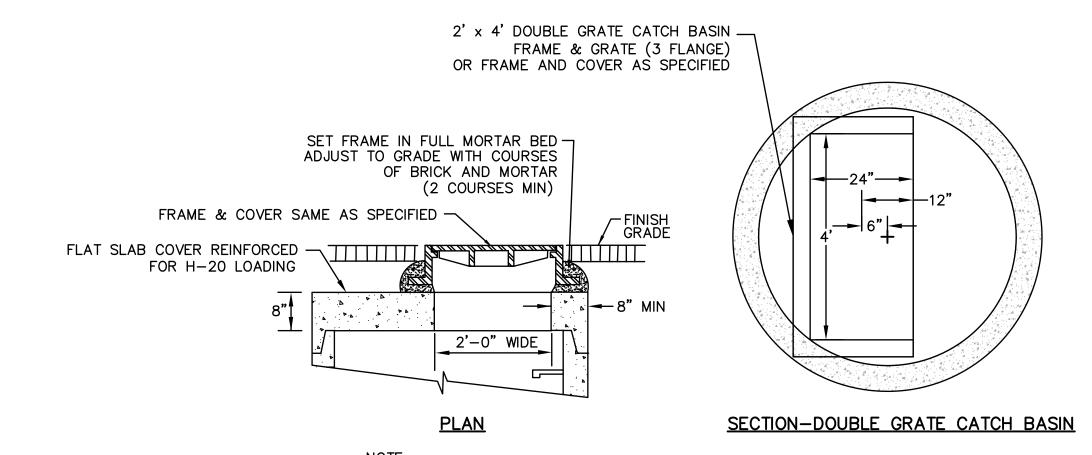


OFFSET TOPS TO BE USED ON PROPOSED CATCH BASINS AND MANHOLES THAT ARE IN CLOSE PROXIMITY TO OTHER UTILITIES.

ALTERNATE OFFSET TOP FOR DRAINAGE STRUCTURES

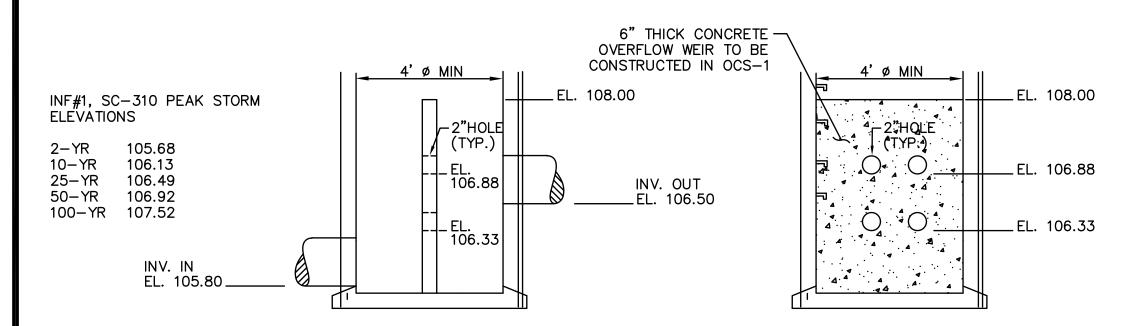


OUTLET CONTROL STRUCTURE (OCS-1) NTS

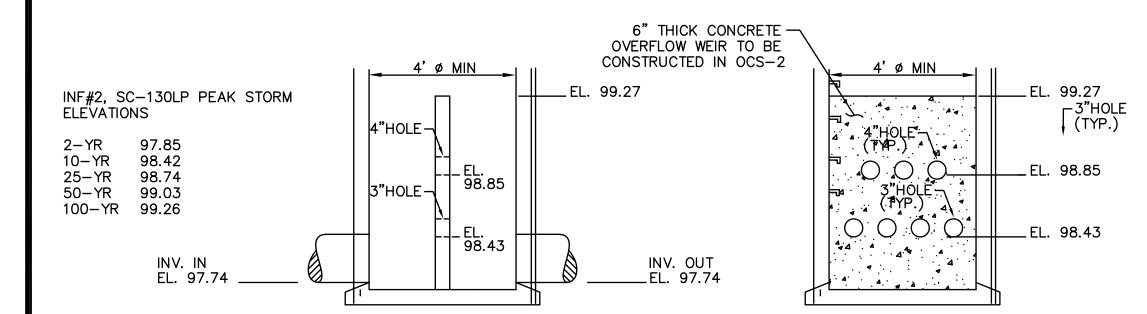


OUTLET CONTROL STRUCTURE (OCS-2)


NTS

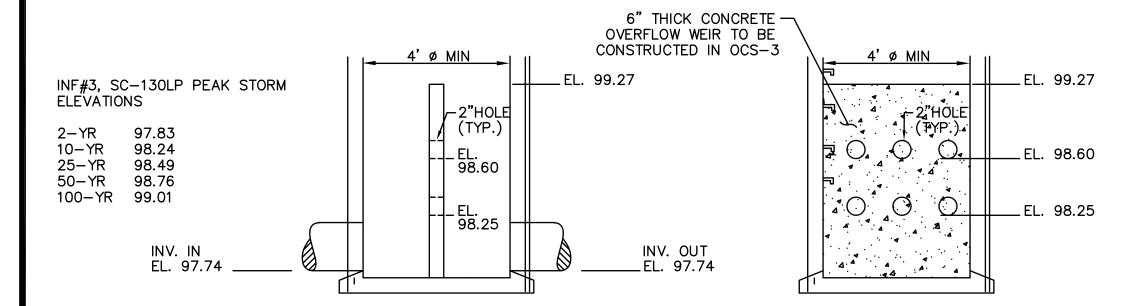

OUTLET CONTROL STRUCTURE (OCS-3)

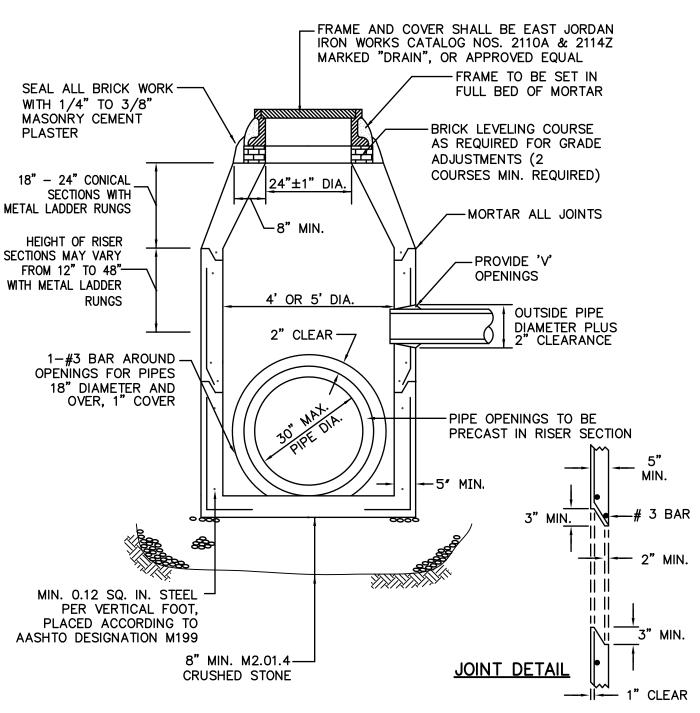

PRECAST CONCRETE DRAIN MANHOLE

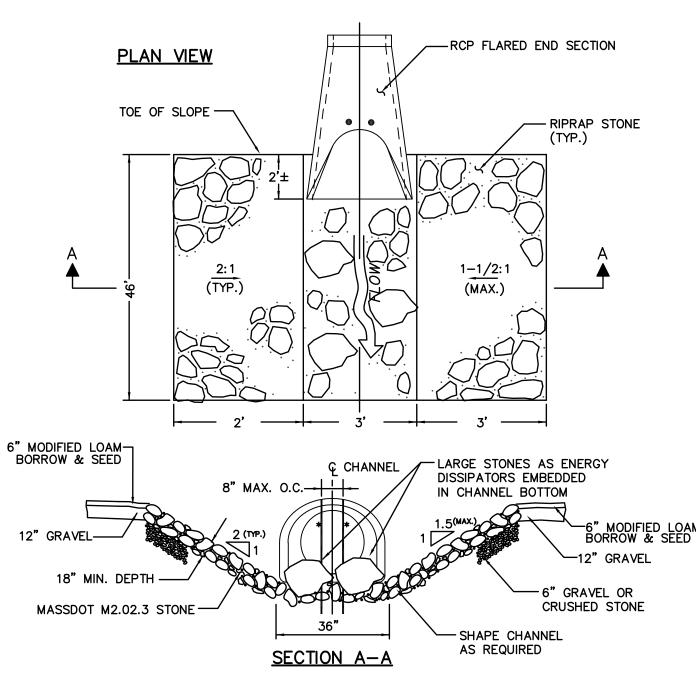

* PROVIDE #4 EPOXY COATED REBAR TO PREVENT A CHILD FROM CRAWLING INTO PIPE (MAXIMUM SPACING 8" O.C.)


RIP-RAP VELOCITY DISSIPATOR

- **EROSION & SEDIMENT CONTROL NOTES:**
- 1. THE SUBSURFACE INFILTRATION SYSTEMS SHALL BE CONSTRUCTED UNDER CONDITIONS WHICH WILL PRECLUDE THE ENTRANCE OF PRODUCTS OF EROSION AND SHOULD BE BACKFILLED IMMEDIATELY AND THE AREA MADE EROSION RESISTANT.
- 2. BARRIERS SHALL BE PLACED TO PREVENT VEHICLES FROM DRIVING OVER THE SYSTEM UNTIL THE INFILTRATION AREA IS BUILT AND CONSTRUCTED TO FINAL GRADE TO REDUCE VEHICULAR IMPACT TO THE SYSTEM. TEMPORARY CONSTRUCTION FENCE SHALL BE INSTALLED IN LOCATION AS SHOWN ON THIS PLAN DURING CONSTRUCTION PERIOD. FENCE SHALL BE INSPECTED DAILY AND REPAIRED AS NEEDED DURING CONSTRUCTION PERIOD.
- 3. CONSTRUCTION PERIOD SILT SACKS SHALL BE USED AT ALL INSTALLED CATCH BASINS. SILT SACKS SHALL BE KEPT FREE OF SEDIMENT AND DEBRIS, INSPECTED WEEKLY AND REPAIRED PROMPTLY.
- 4. SEDIMENT AND EROSION CONTROL STRAW FILTER TUBES SHALL BE PLACED UPSTREAM OF PROPOSED INFILTRATION SYSTEM LOCATION AS SHOWN ON THIS PLAN DURING CONSTRUCTION PERIOD. EROSION CONTROLS SHALL BE INSPECTED DAILY FOR SEDIMENT BUILDUP, DAMAGED FILTER TUBES AND FOR EVIDENCE OF RUNOFF BY-PASS AND CLEANED OR REPAIRED IMMEDIATELY.
- 5. ALL SLOPES AND EXCAVATIONS SHALL BE STABILIZED DURING CONSTRUCTION USING JUTE NETTING AND EROSION CONTROL BLANKETS, INSPECT FOR PROPER GROUND CONTACT. REPLACE DETERIORATED BLANKETS AND ADD LOAM AND RE-SEED ERODED AREAS AND RE-STABLE OR PIN FABRIC MATERIAL AS NEEDED.

FRAME AND GRATE SHALL BE EAST JORDAN IRON WORKS CATALOG NOS. 5520M5 & 5524Z FOR THE 4-FLANGE AND CATALOG NOS. 5520M5 & 5523Z FOR THE 3-FLANGE, OR APPROVED EQUAL. GRANITE CURB INLET -- FRAME TO BE SET IN FULL BED OF MORTAR SEAL ALL BRICK WORK-- ADJUST TO GRADE WITH A MINIMUM OF TWO COURSES TOP SLAB STEEL-OF BRICK MASONRY OR REINFORCED TO MEET REINFORCED CONCRETE ← OR EXCEED H-20 LOADING GRADE RINGS. 24"±1" DIA. -PROVIDE 'V' HEIGHT OF **OPENINGS** RISER SECTIONS (5' OR 6' DIA. FOR DOUBLE MAY VARY-GRATE CB'S) FROM 12" TOUTSIDE PIPE DIAMETER PLUS 2" CLEARANCE TO 48" NORMAL WATER LEVEL MORTAR ALL JOINTS MIN. 0.12 SQ. IN. STEEL — PER VERTICAL FOOT, PLACED --- PRECAST CEMENT ACCORDING TO AASHTO CONCRETE BASE UNIT DESIGNATION M199 -OIL AND GREASE TRAP SNOUT/HOOD SHALL BE BMP 8" MIN. M2.01.4— INC. 18R, ELIMINATOR OR CRUSHED STONE 9.0' OR LESS IN DEPTH

PRECAST CONCRETE CATCH BASIN W/4' SUMP

APPROVED EQUAL

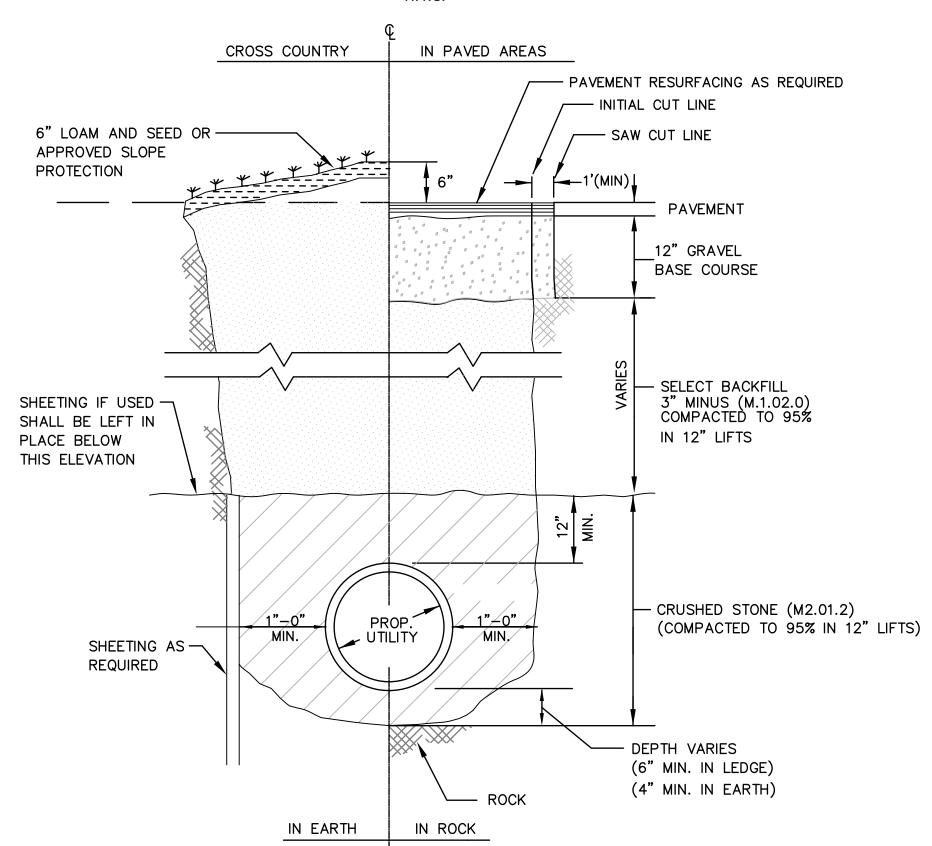

TYPICAL DRAIN TRENCH DETAIL N.T.S.

MICHAEL J.

CARTER

CIVIL


4/25/18


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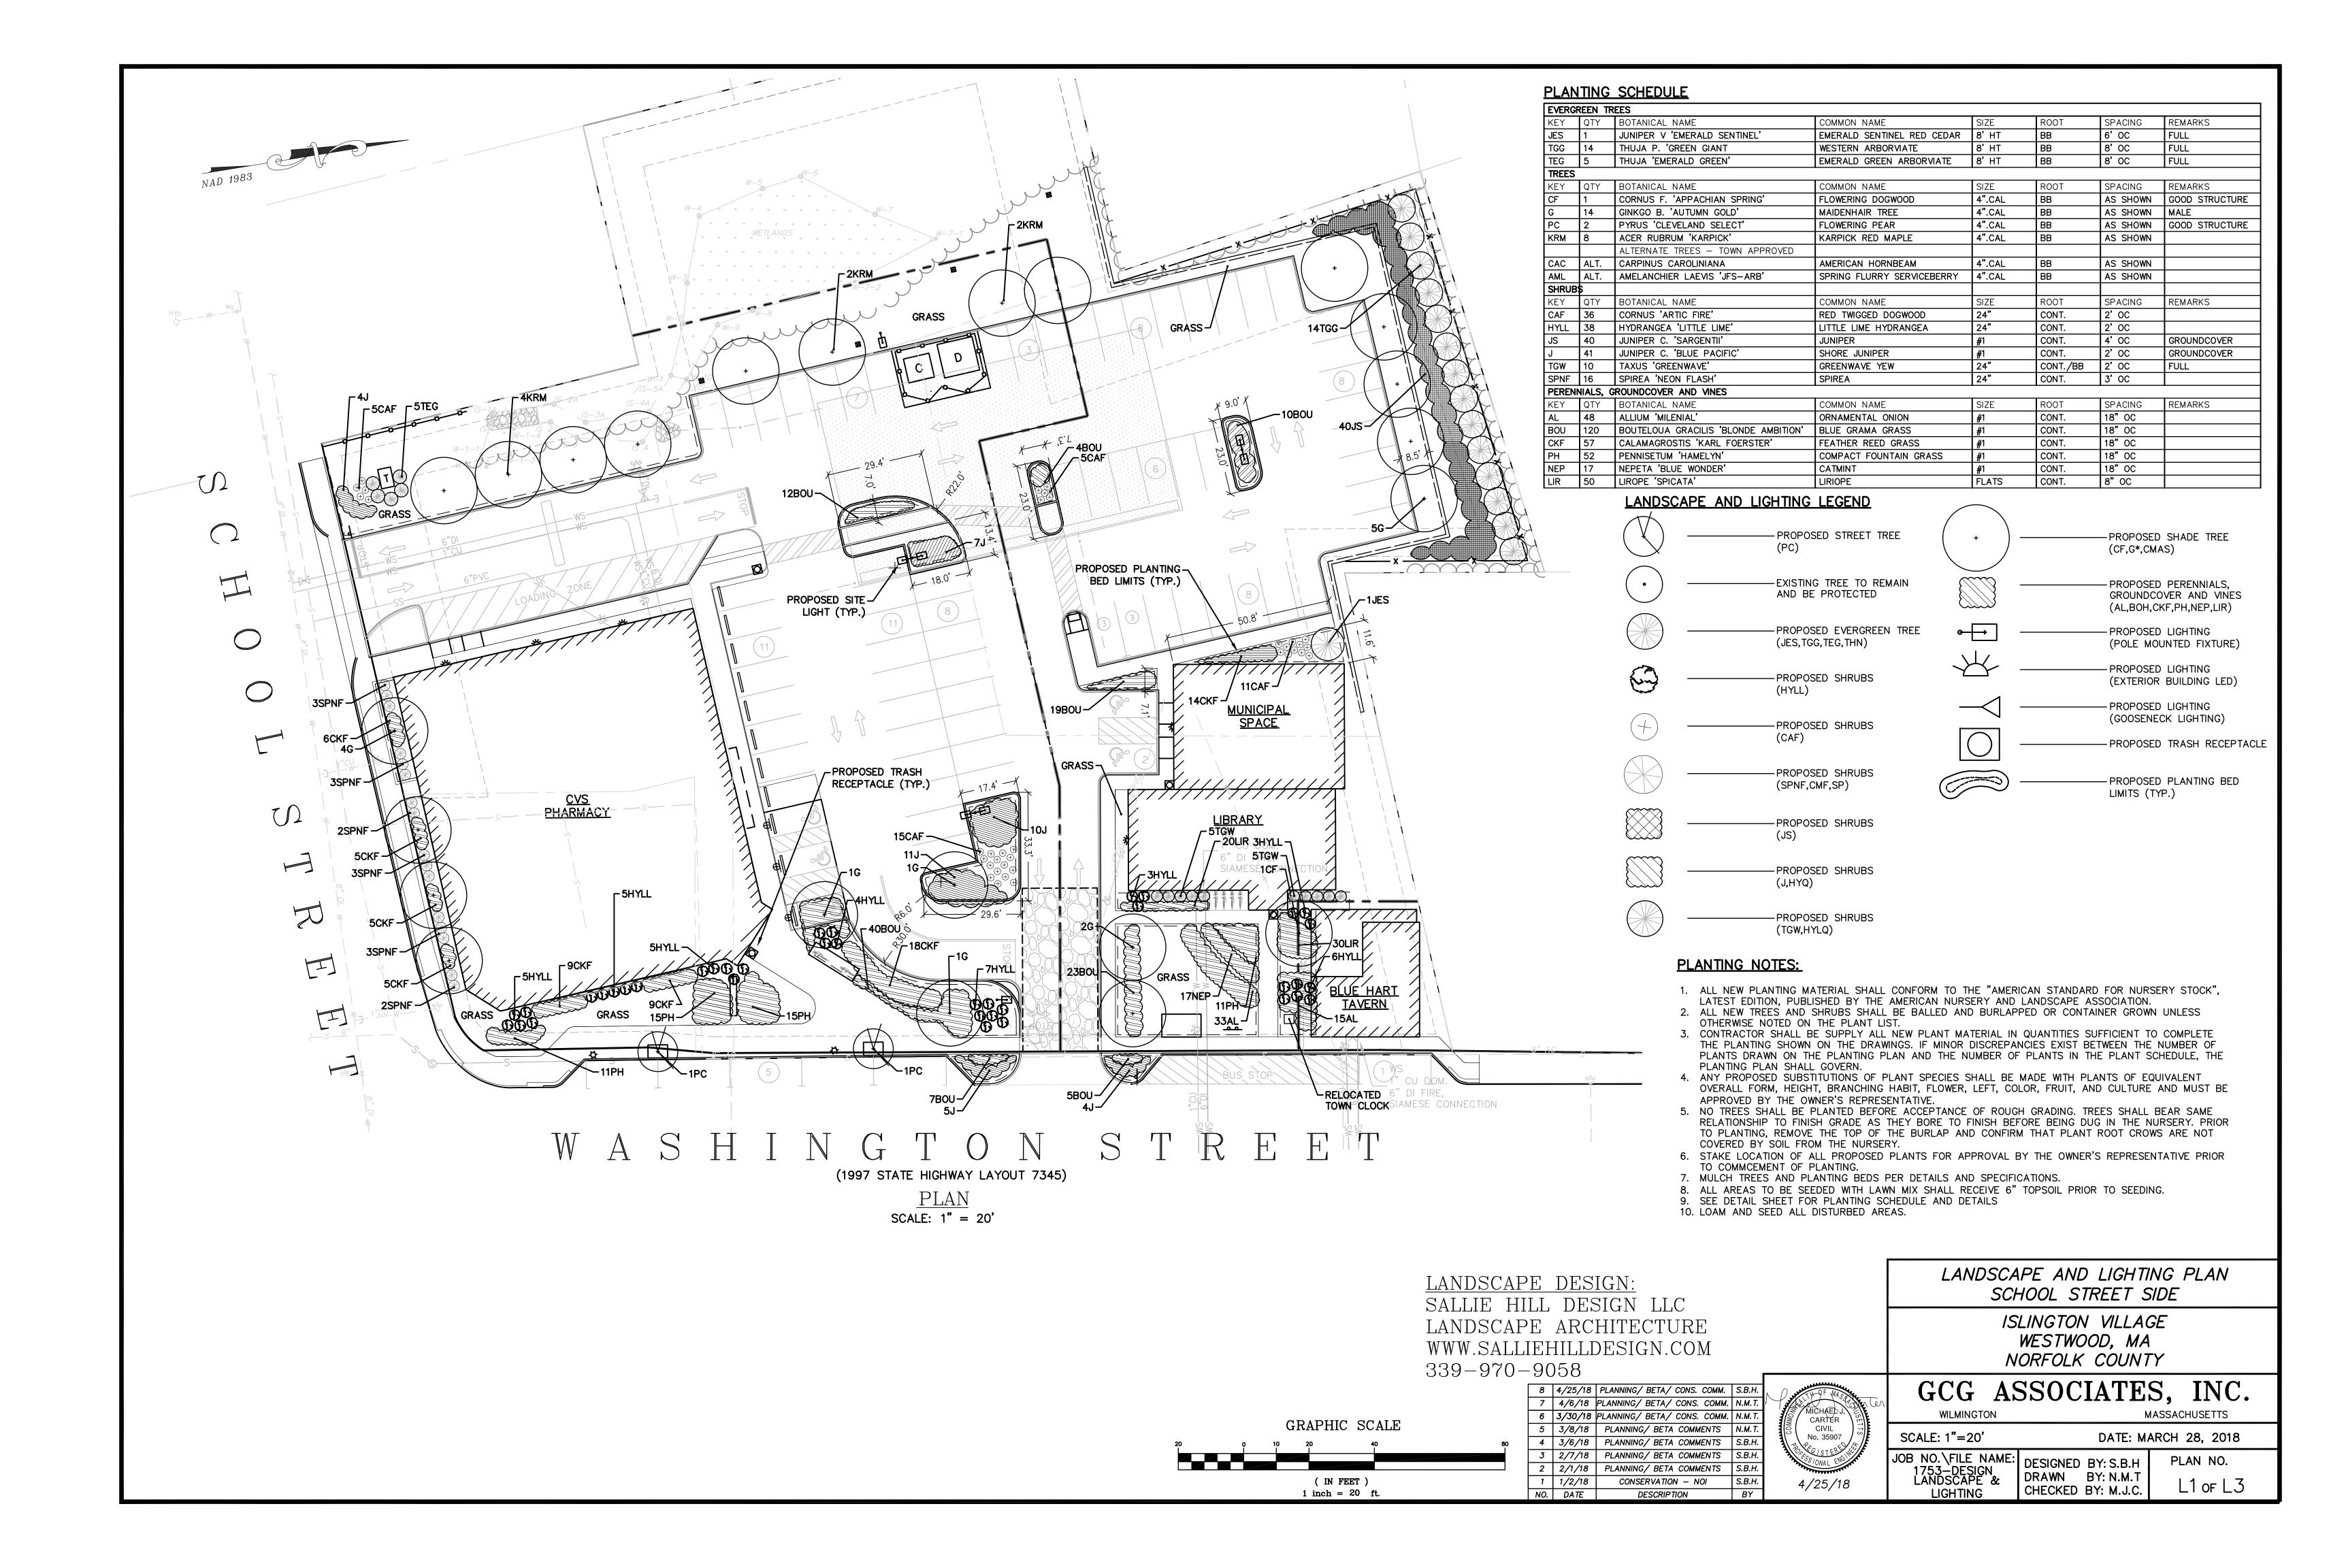
DETAIL SHEET VII ISLINGTON VILLAGE WESTWOOD, MA NORFOLK COUNTY


GCG ASSOCIATES, INC.

MASSACHUSETTS WILMINGTON DATE: DECEMBER 12, 2017 SCALE: AS NOTED JOB NO. FILE NAME: DESIGNED BY: S.B.H. PLAN NO. DRAWN BY: S.B.H. CHECKED BY: M.J.C. C-19 of 20 1753-COVER_DETAILS



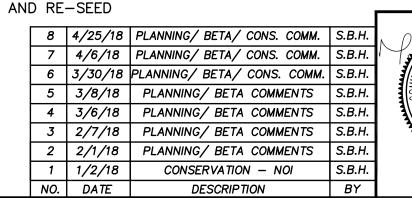

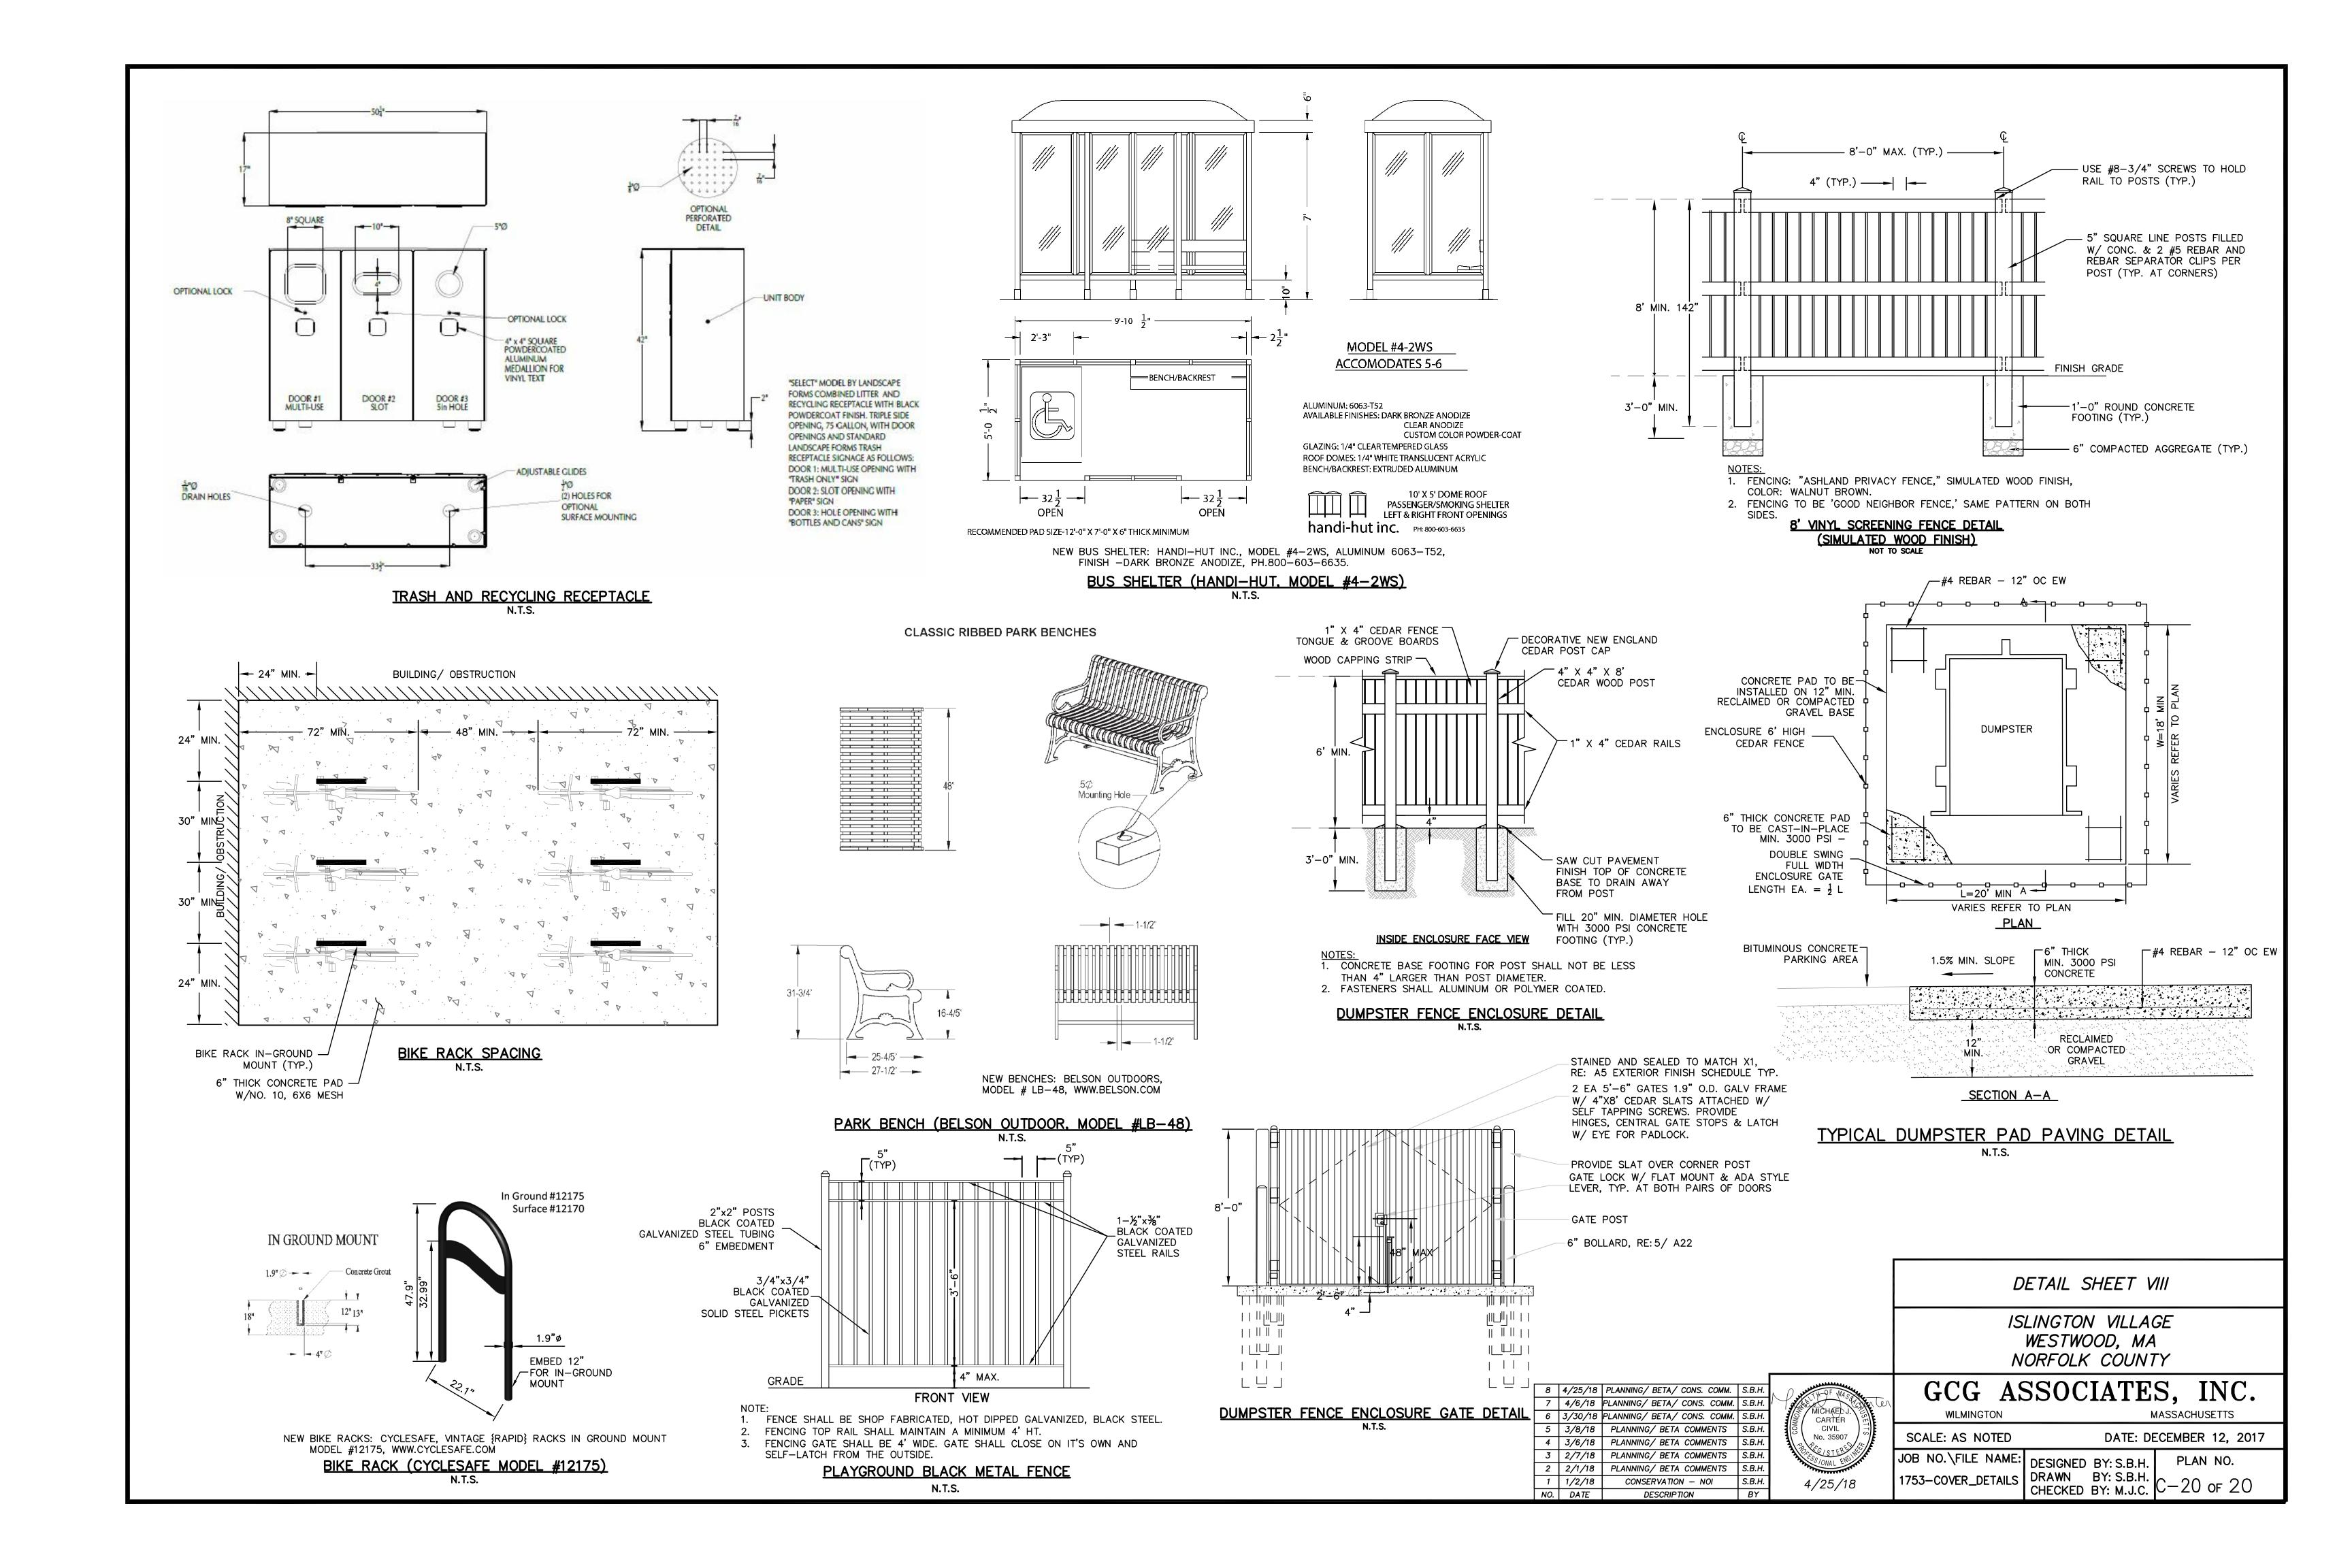


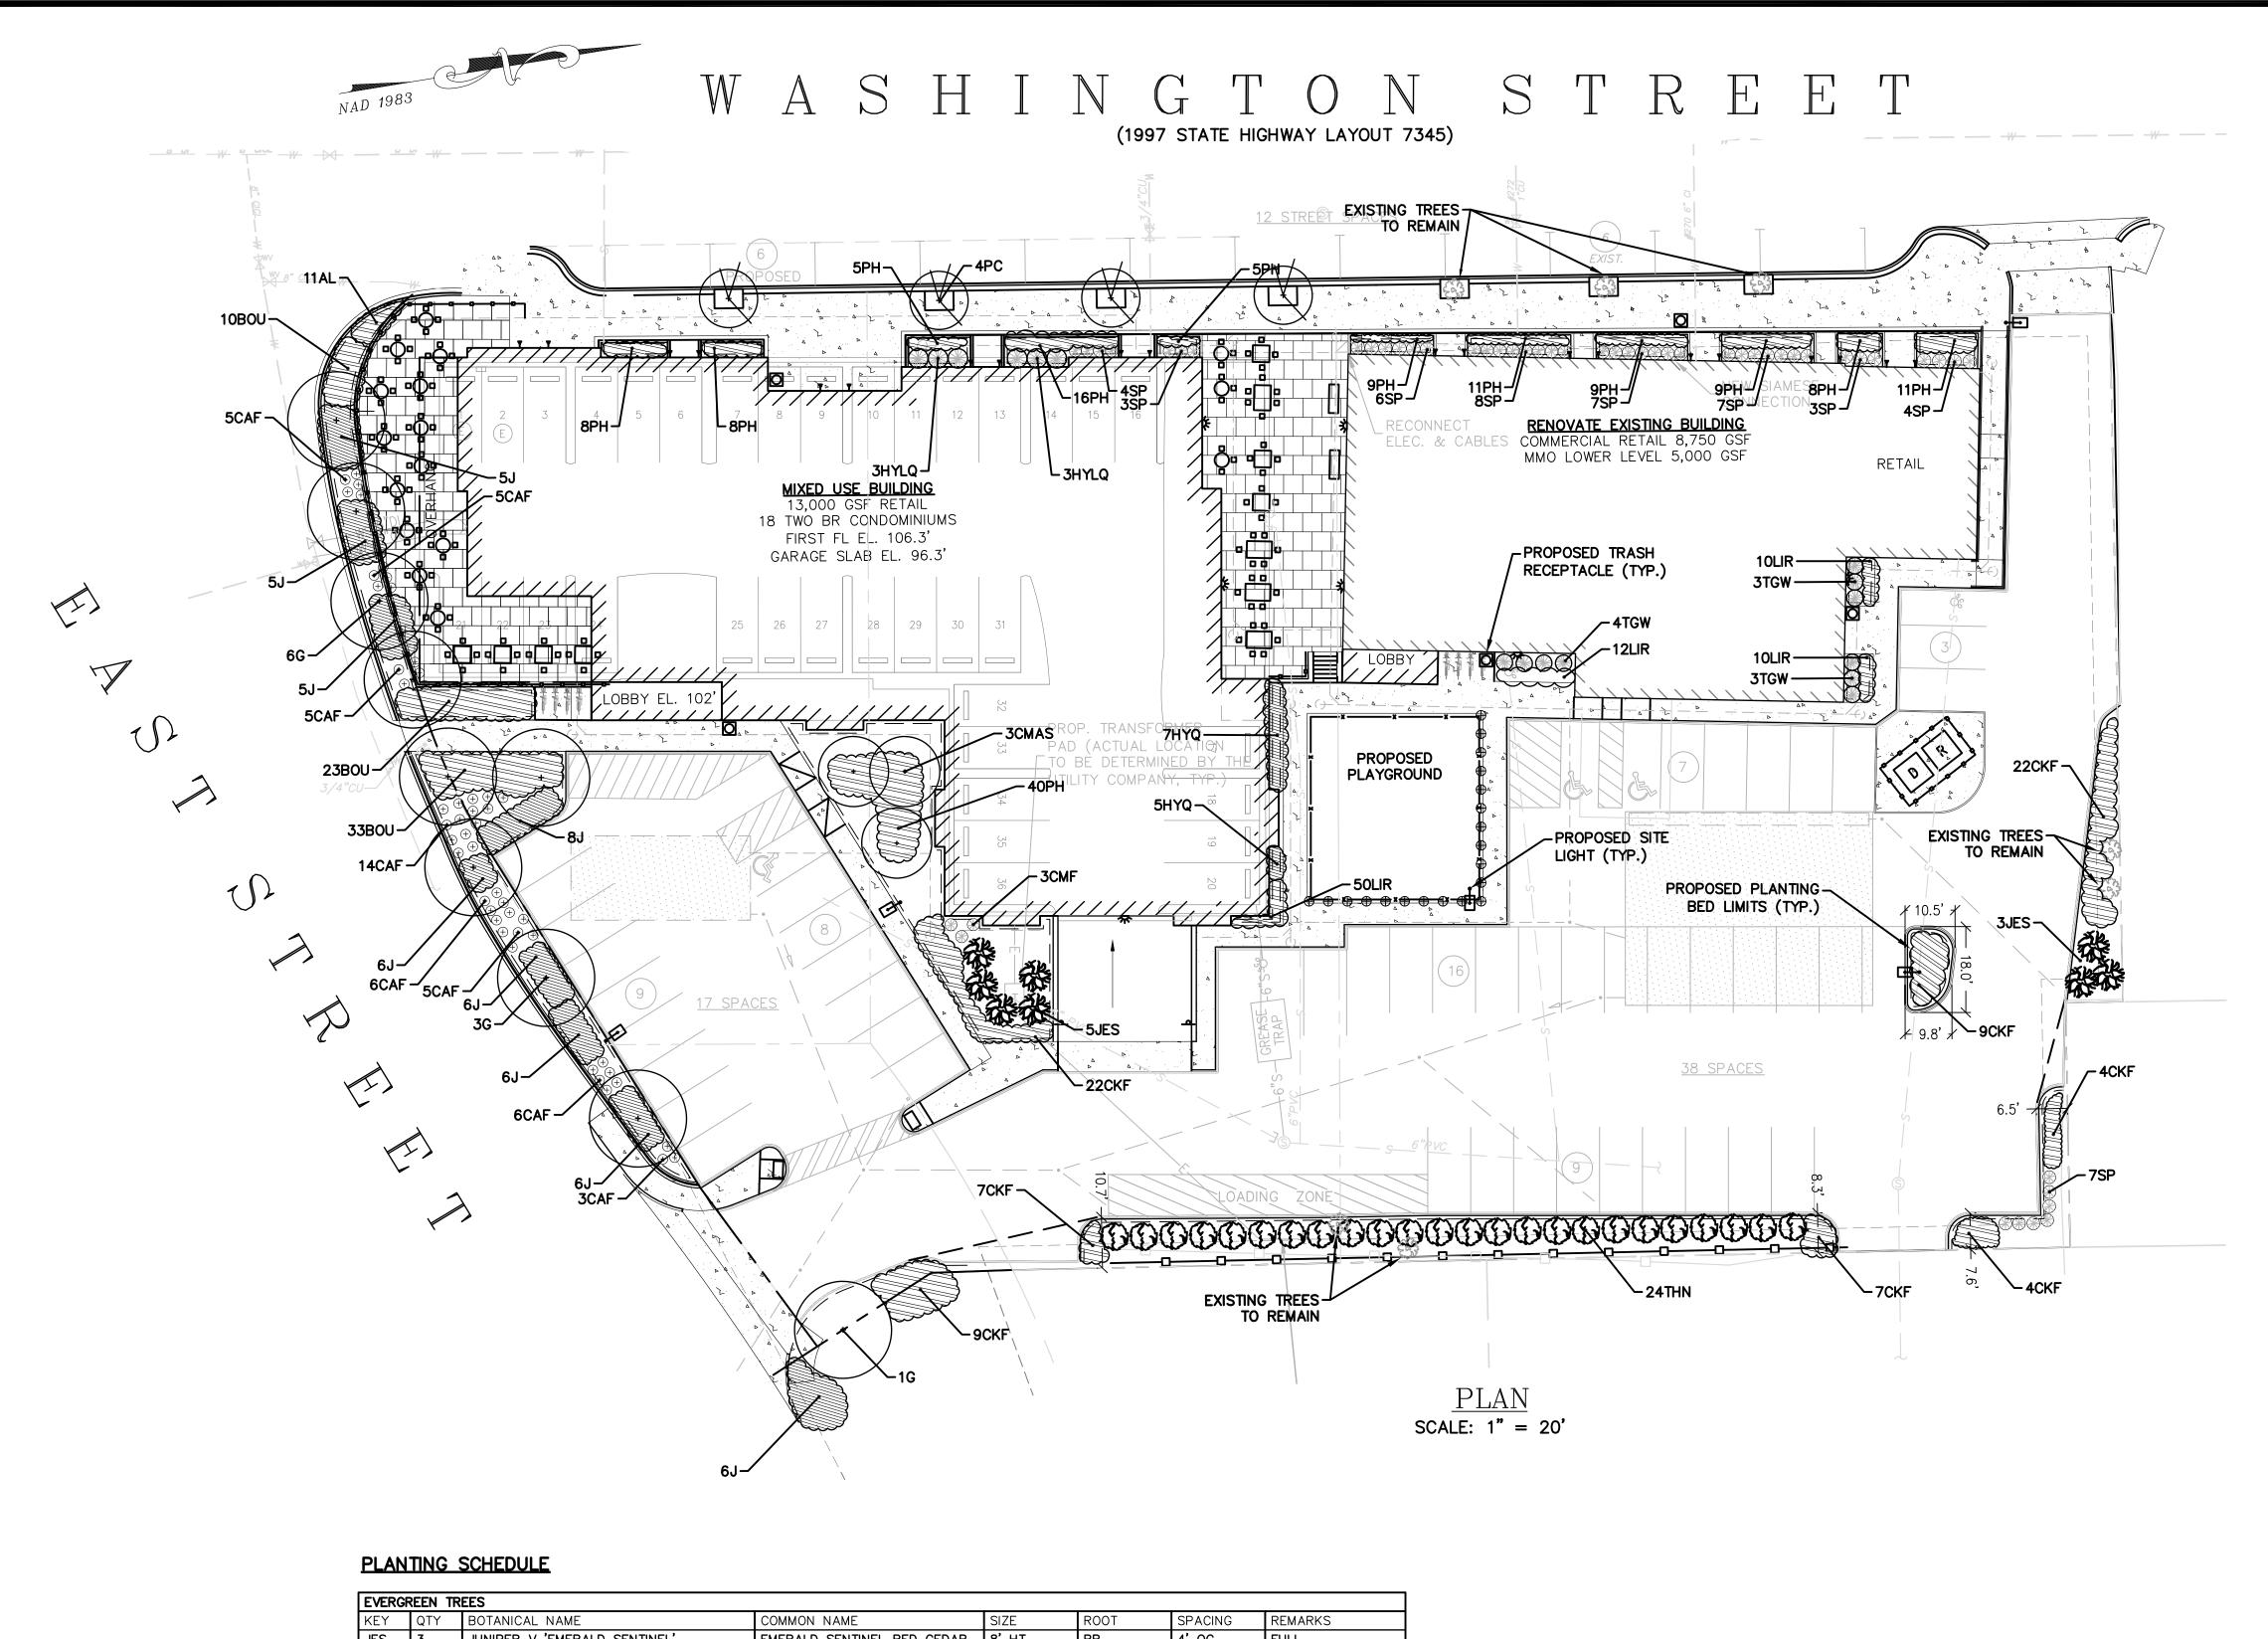

EVERG	REEN TE	REES					
KEY	QTY	BOTANICAL NAME	COMMON NAME	SIZE	ROOT	SPACING	REMARKS
JES	3	JUNIPER V 'EMERALD SENTINEL'	EMERALD SENTINEL RED CEDAR	8' HT	BB	4' OC	FULL
THN	24	THUGA 'NIGRA'	NIGRA ARBORVIATE	8' HT	BB	5' OC	FULL
TREES	•	•	•	•	•	•	•
KEY	QTY	BOTANICAL NAME	COMMON NAME	SIZE	ROOT	SPACING	REMARKS
CMAS	3	CORNUS MAS	CORNELIANCHERRY DOGWOOD	7-8' HT	BB	AS SHOWN	MULTI STEM
G*	10	GINKGO B. 'AUTUMN GOLD'	MAIDENHAIR TREE	4" CAL	BB	AS SHOWN	MALE ONLY
PC	4	PYRUS 'CLEVELAND SELECT'	FLOWERING PEAR	4" CAL	BB	AS SHOWN	GOOD STRUCTURE
SHRUB	S	•	•		•	•	•
KEY	QTY	BOTANICAL NAME	COMMON NAME	SIZE	ROOT	SPACING	REMARKS
CAF	49	CORNUS 'ARTIC FIRE'	RED TWIGGED DOGWOOD	24"	CONT.	2' OC	
CMF	39	CORNUS 'MIDWINTER FIRE'	RED TWIG DOGWOOD	24"	CONT.	2' OC	
HYLQ	6	HYDRANGEA P. 'LITTLE QUICKFIRE'	LITTLE QUICKFIRE HYDRANGEA	24"	CONT.	3' OC	
HYQ	12	HYDRANGEA Q. 'SNOW QUEEN'	OAKLEAF HYDRANGEA	24"	CONT.	2' OC	
J	53	JUNIPER C. 'BLUE PACIFIC'	SHORE JUNIPER	#1	CONT.	4' OC	GROUNDCOVER
SP	49	SPIREA 'SHIROBANA'	SPIREA	24"	CONT.	2' OC	
TGW	10	TAXUS 'GREENWAVE'	GREENWAVE YEW	24"	CONT/BB.	2' OC	FULL
PEREN	NIALS, (GROUNDCOVER AND VINES	•	•	-	•	•
KEY	QTY	BOTANICAL NAME	COMMON NAME	SIZE	ROOT	SPACING	REMARKS
AL	11	ALLIUM 'MILENIAL'	ORNAMENTAL ONION	#1	CONT.	18" OC	
BOU	65	BOUTELOUA GRACILIS 'BLONDE AMBITION'	BLUE GRAMA GRASS	# 1	CONT.	18" OC	
CKF	84	CALAMAGROSTIS 'KARL FOERSTER'	FEATHER REED GRASS	#2	CONT.	3' OC	
PH	139	PENNISETUM 'HAMELYN'	COMPACT FOUNTAIN GRASS	#1	CONT.	18" OC	
LIR	82	LIROPE 'SPICATA'	LIRIOPE	FLATS	CONT.	8" OC	

LANDSCAPE DESIGN:
SALLIE HILL DESIGN LLC
LANDSCAPE ARCHITECTURE
WWW.SALLIEHILLDESIGN.COM

339-970-9058

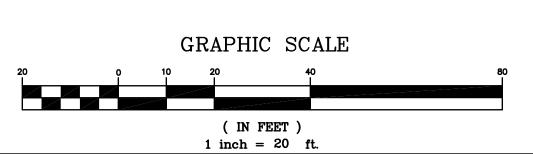

1	8		PLANNING/ BETA/ CONS. COMM.		ν Ω
	7	4/6/18	PLANNING/ BETA/ CONS. COMM.	N.M.T.	1
	6	3/30/18	PLANNING/ BETA/ CONS. COMM.	N.M.T.	SWW03
	5	3/8/18	PLANNING/ BETA COMMENTS	N.M.T.	
0	4	3/6/18	PLANNING/ BETA COMMENTS	S.B.H.	3 \
	3	2/7/18	PLANNING/ BETA COMMENTS	S.B.H.	3
	2	2/1/18	PLANNING/ BETA COMMENTS	S.B.H.	
	1	1/2/18	CONSERVATION - NOI	S.B.H.	
	NO.	DATE	DESCRIPTION	BY	

LANDSCAPE AND LIGHTING PLAN EAST STREET SIDE

ISLINGTON VILLAGE
WESTWOOD, MA
NORFOLK COUNTY

GCG ASSOCIATES, INC.

MICHAED J.

CARTER

CIVIL

No. 35907

4/25/18

WILMINGTON MASSACHUSETTS

SCALE: 1"=20' DATE: MARCH 28, 2018


JOB NO.\FILE NAME:
1753-DESIGN
LANDSCAPE & DESIGNED BY: S.B.H.
DRAWN BY: N.M.T.
CHECKED BY: M.J.C.

L2 of L3



- 1. NEW STREET LIGHT SHALL BE SAME MAKE, TYPE, COLOR AND HEIGHT OF THE LIGHT POLE AND LIGHT FIXTURE EXISTING ON WASHINGTON STREET. (OR APPROVED EQUAL)
- 2. LIGHT POLE AND FIXTURE INFORMATION CONTACT: MASSBAY ELECTRICAL CORPORATION 125 ORLEANS STREET
- EAST BOSTON, MA 02128 PHONE: 617-567-2001; 1-800-457-1081 FAX: 617+561-0854

TYPICAL STREET LIGHTING DETAIL N.T.S.

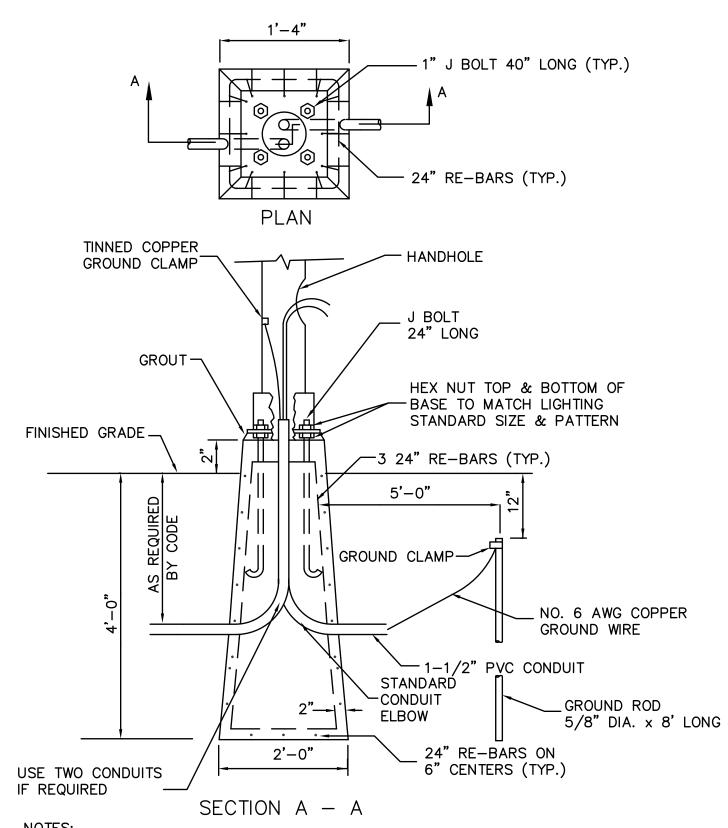

NOTES:

1. THE LIGHTING FOUNDATION SHOWN IS FOR REFERENCE PURPOSES. THE ACTUAL LIGHT

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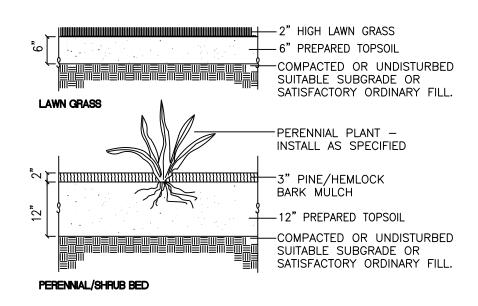
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1. THE LIGHT FOUNDATION SHOWN IS FOR REFERENCE PURPOSES. THE ACTUAL PURPOSES PURPO FOUNDATION DESIGN IS SUBJECT TO CHANGE BASED ON FINAL POLE AND FIXTURE SELECTION AND GEOTECHNICAL SITE INVESTIGATION. IF LEDGE IS ENCOUNTERED THE BASE SHALL BE ADJUSTED AND ANCHORED TO THE LEDGE.

PRECAST LIGHTING FOUNDATION (BASE)

THE CONTRACTOR MAY SUBSTITUTE A CAST IN PLACE BASE.


N.T.S.




PERENNIAL & LAWN GRASS N.T.S.

NOTES: SHRUB SHALL BEAR SAME

RELATIONSHIP TO FINISHED GRADE AS

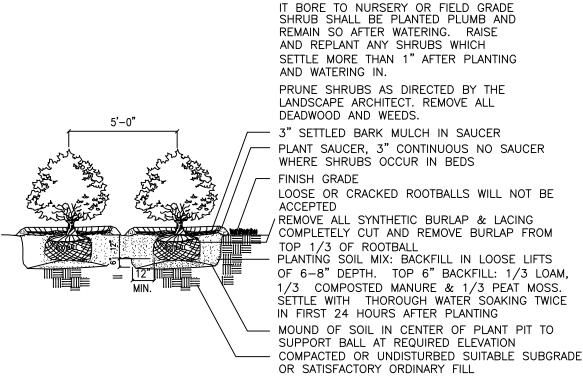

PERENNIAL & LAWN GRASS

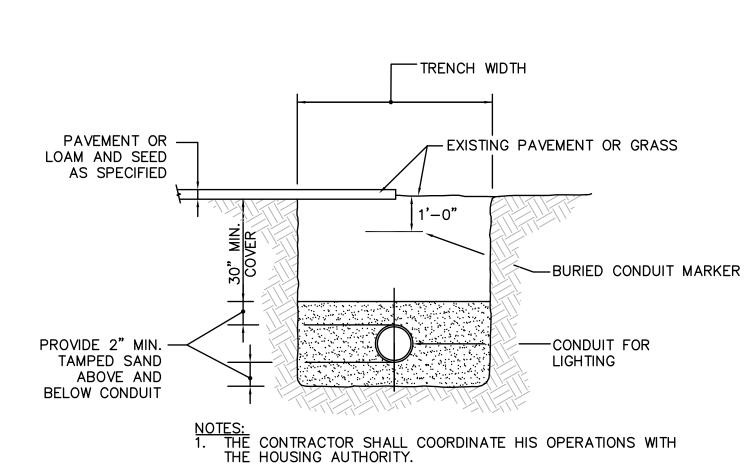

TYPICAL TRENCH DETAIL FOR TELEPHONE AND ELECTRICAL CONDUIT N.T.S.

- NOTES:


 1. THE LIGHTING FOUNDATION SHOWN IS FOR REFERENCE PURPOSES. THE ACTUAL LIGHT FOUNDATION DESIGN IS SUBJECT TO CHANGE BASED ON FINAL POLE AND FIXTURE SELECTION AND GEOTECHNICAL SITE INVESTIGATION.

 2. IF LEDGE IS ENCOUNTERED THE BASE SHALL BE ADJUSTED AND ANCHORED TO THE
- THE CONTRACTOR MAY SUBSTITUTE A CAST IN PLACE BASE PROPOSED LED PARKING AREA LIGHTS SHALL BE AS SUPPLIED BY TECHLIGHT — SABER LED AREA LIGHT — MODEL NO. LSBW6C8T5WD1—BZ OR EQUAL AND SHALL
- INCLUDE CONCRETE BASE, 25' ROUND ALUMINUM POLES, HORIZONTAL TENON ADAPTER, PHOTOELECTRIC CELL AND BULB AS SPECIFIED. 5. PROPOSED LED WALKWAY LIGHTS SHALL BE AS SUPPLIED BY RAB LIGHTING - MODEL NO. ALED5T52 OR EQUAL AND SHALL INCLUDE 10' SQUARE POLES WITH WELDED TENON, PHOTOELECTRIC CELL AND BULB AS SPECIFIED.
- 6. PROPOSED PRECAST CONCRETE ELECTRIC HANDHOLES SHALL BE AS MANUFACTURED BY SCITUATE RAY PRECAST - MODEL - MDC CONCRETE HANDHOLE 18" x 24"HHMDC. CAST IRON FRAME AND COVER SHALL BE AS MANUFACTURED BY EAST JORDAN IRON WORKS MODEL NO. 0MA801000003/0MA801000012 OR EQUAL AND AS
- 7. THE PRICE FOR THE PROPOSED LIGHTING SYSTEMS SHALL INCLUDE THE COST FOR ALL PERMITS, WORK AND MATERIALS REQUIRED AND AS SPECIFIED AND SHOWN ON THE DRAWINGS AND ACCORDING TO CURRENT MASSACHUSETTS ELECTRICAL CODES.


SITE LIGHTING SPECIFICATION:

SITE LIGHTING -STREET LIGHTING - (MATCH EXISTING TOWN OF WESTWOOD LIGHTS, POLES AND BASES)


1) ALL NEW AND RE-USED LIGHTING TO BE MOUNTED IN NEW PRECAST FOUNDATION PER DETAIL. 2) EXISTING LIGHTING FOUNDATION (BASE) TO BE DETACHED FROM POST AND REMOVED FROM GROUND LOCATION.

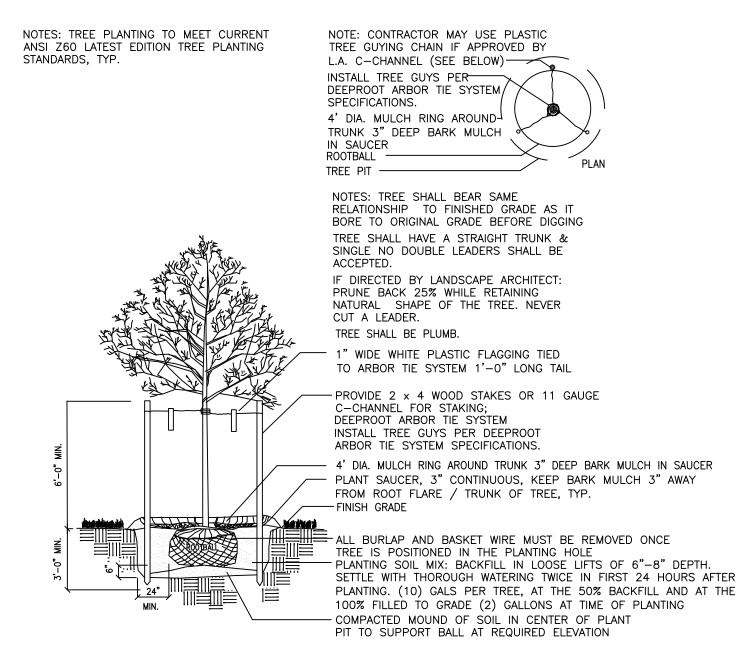


DECIDUOUS TREE PLANTING AND STAKING

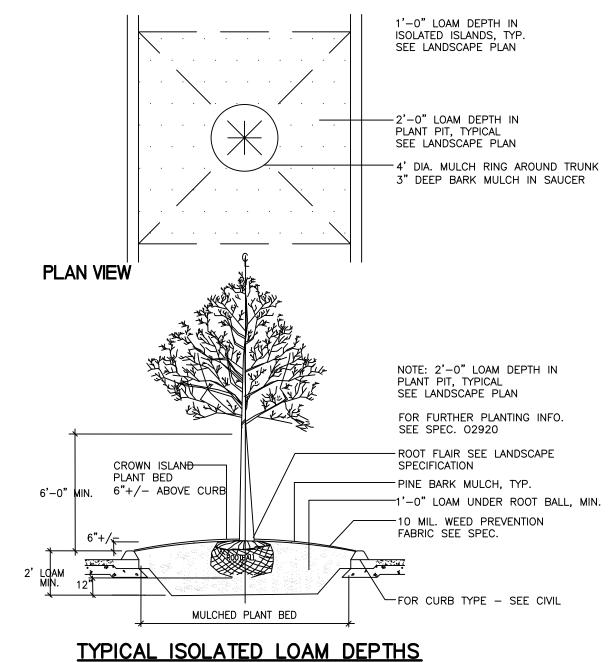

N.T.S.

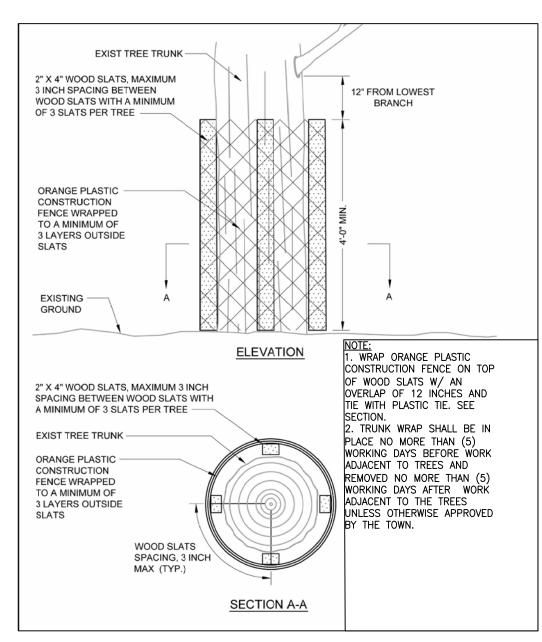

EXISTING TREE TRUNKS WRAP PROTECTION DETAIL

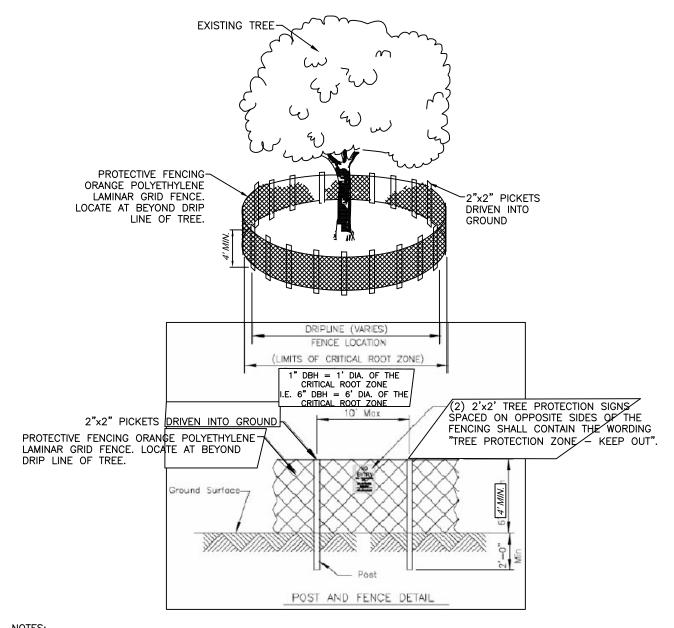

- NOTES:

 TREE PROTECTION BARRIERS MUST BE PLACED AROUND TREES TO BE RETAINED WITHIN AN AREA WHERE LAND ALTERATION AND CONSTRUCTION ACTIVITIES WILL OCCUR. TREES TO REMAIN SHALL BE INDICATED ON THE PLANS. TREE PROTECTION BARRIER MUST REMAIN IN PLACE UNTIL GRADING AND CONSTRUCTION ACTIVITY IS COMPLETE OR UNTIL COMMENCEMENT OF FINISH GRADING AND SODDING
- BARRIERS SHALL BE PLACED AROUND TREES AT THE DRIPLINE EXCEPT WHERE LAND ALTERATION OR CONSTRUCTION ACTIVITIES ARE APPROVED WITHIN THE DRIPLINE. 4. THE DRIPLINE OF A TREE IS THE IMAGINARY VERTICAL LINE THAT EXTENDS DOWNWARD FROM THE OUTERMOST TIPS OF
- THE TREE'S BRANCHES TO THE GROUND.

 AREAS SURROUNDED BY THE TREE PROTECTION BARRIERS SHALL BE PROTECTED FROM VEGETATION REMOVAL, PLACEMENT OF SOIL, DEBRIS, SOLVENTS, CONSTRUCTION MATERIAL, MACHINERY OR OTHER EQUIPMENT OF ANY KIND. 6. WHEN CONSTRUCTION OCCURS OUTSIDE OF THE PROTECTION BARRIER / DRIP LINE ALL TREE ROOTS WITHIN AREA TO BE GRADED AND ORIGINATING FROM A PROTECTED TREE SHALL BE SEVERED CLEANLY AT THE LIMITS OF THE PROTECTED AREA. ALL TREE PRUNING AND TRIMMING ON ANY TREE TO BE RETAINED SHALL BE PERFORMED BY AN ARBORIST CERTIFIED BY
- THE AMERICAN SOCIETY OF ARBORICULTURE (ASA). 8. (2) 2'x2' TREE PROTECTION SIGNS SPACED ON OPPOSITE SIDES OF EVERY EXISTING TREES PROTECTION BARRIER TO REMAIN SHALL CONTAIN THE WORDING "TREE PROTECTION ZONE - KEEP OUT".

EXISTING TREE CRITICAL ROOT ZONE PROTECTION DETAIL N.T.S.

> LANDSCAPE AND LIGHTING PLAN **DETAILS**

> > ISLINGTON VILLAGE WESTWOOD, MA NORFOLK COUNTY



8 4/25/18 PLANNING/ BETA/ CONS. COMM. N.M.1

7 4/6/18 PLANNING/ BETA/ CONS. COMM. N.M.1

3 2/7/18 PLANNING/ BETA COMMENTS S.B.H

2 2/1/18

1 1/2/18

PLANNING/ BETA COMMENTS

CONSERVATION - NOI

DESCRIPTION

S.B.H.

GCG ASSOCIATES, INC.

MASSACHUSETTS WILMINGTON DATE: MARCH 07, 2018 SCALE: 1"=20' JOB NO.\FILE NAME: PLAN NO. DESIGNED BY: S.B.H. DRAWN BY: N.M.T. L3 of L3 CHECKED BY: M.J.C. LIGHTING

